


TOWN OF BURRILLVILLE, RI BURRILLVILLE SEWER COMMISSION WWTF HEADWORKS & OAKLAND PUMP STATION IMPROVEMENTS, CONTRACT NO. 20 MAY 2023

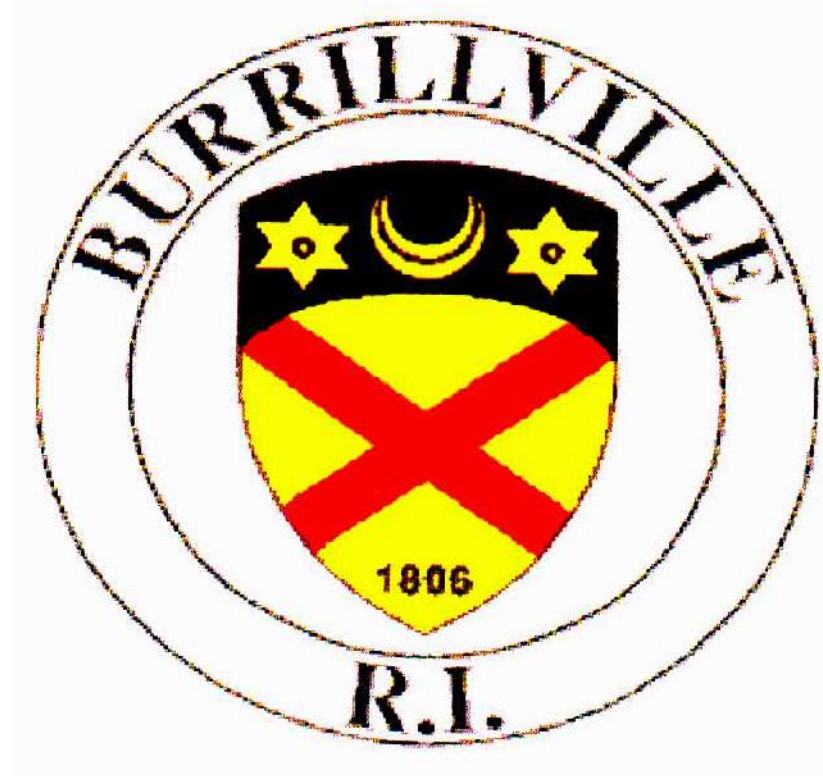

BURRILLVILLE SEWER COMMISSION


WILLIAM ANDREWS
RICHARD NOLAN
RUSSELL FONTAINE
GARY ROULEAU
DANIEL JOUBERT

CHAIRMAN
VICE CHAIRMAN
SECRETARY
MEMBER
MEMBER

MICHAEL EMOND


WWTF SUPERINTENDENT

Burrillville
WWTF

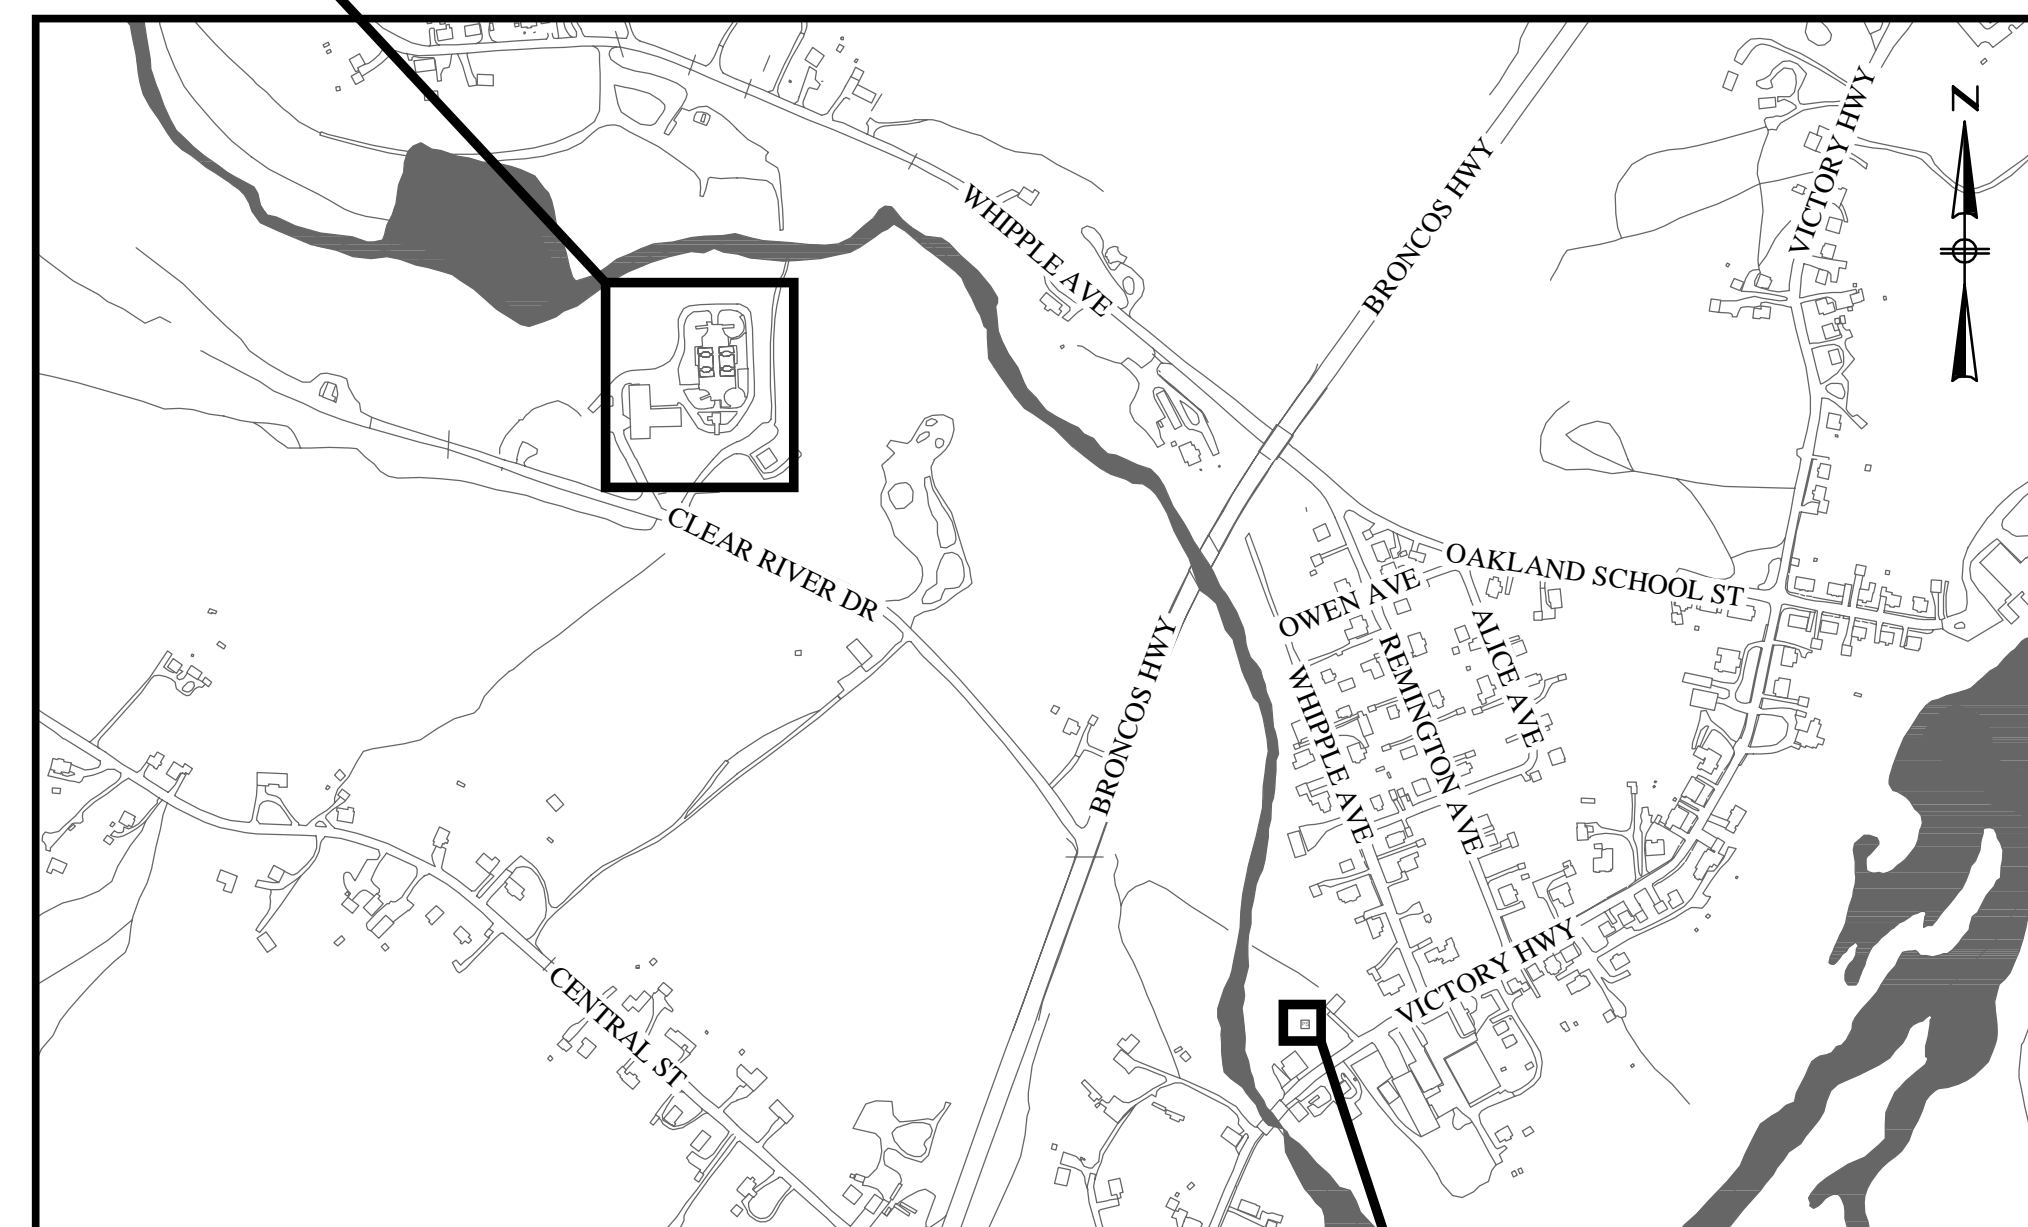

LOCUS MAP
NOT TO SCALE


Oakland Pump Station

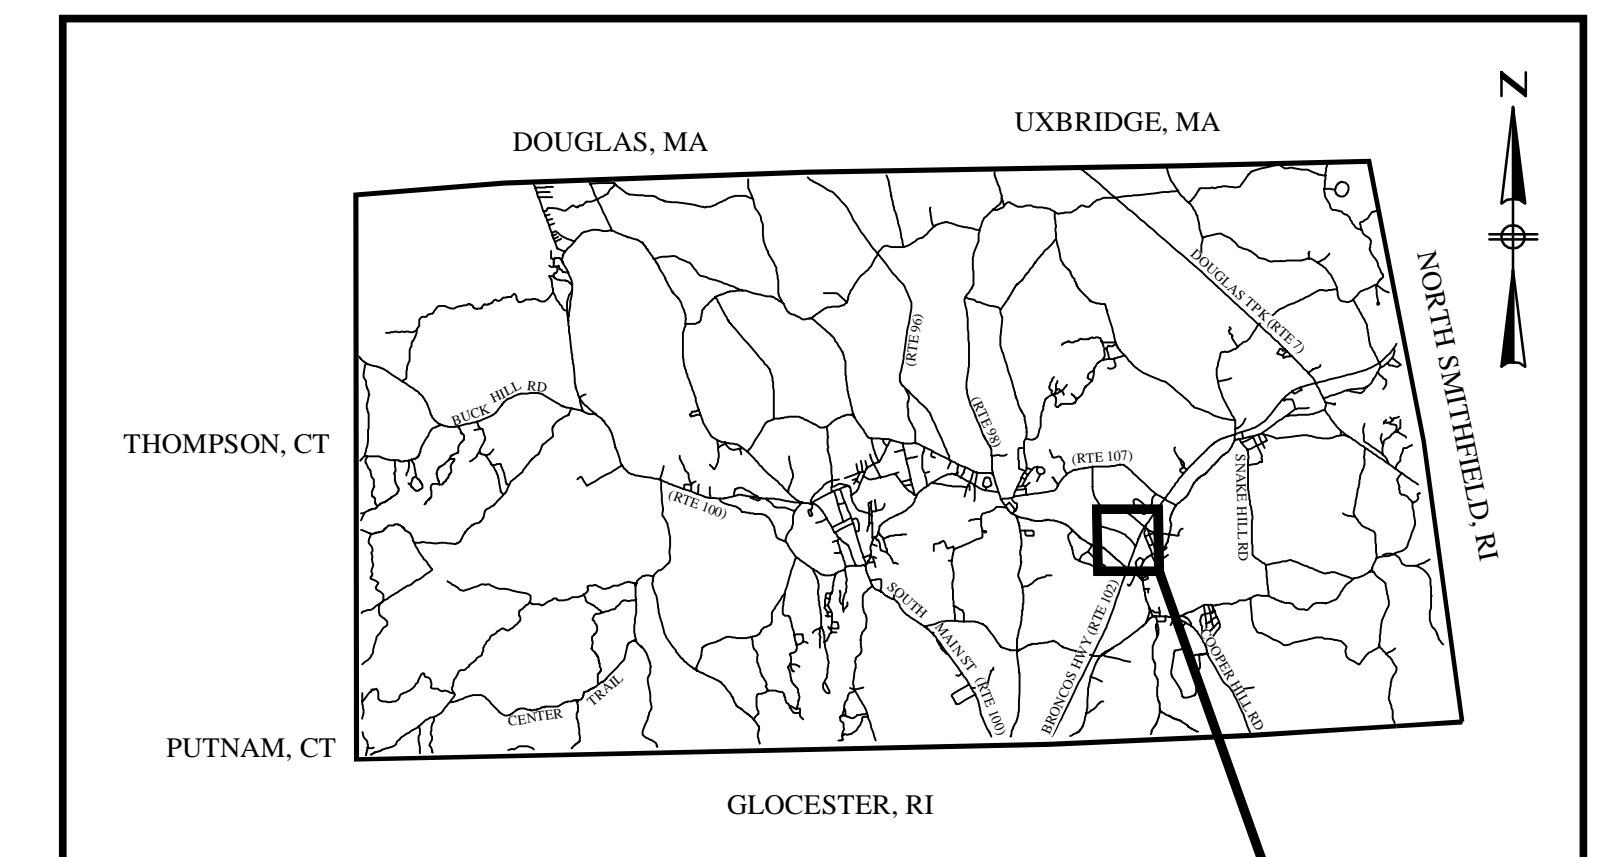

LOCATION MAP
NOT TO SCALE

Project
Location

PREPARED BY:

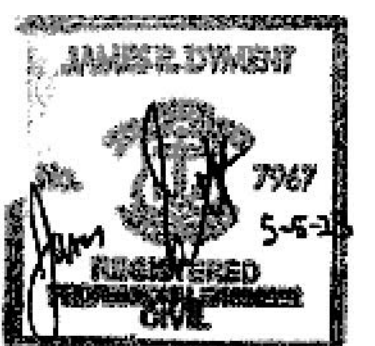

LEGEND

EXISTING

Table listing existing symbols and their descriptions: GRAVITY SEWER PIPE, SEWER FORCE MAIN, DRAIN PIPE, SEWER MANHOLE, DRAIN MANHOLE, CATCH BASIN, PLANT WATER HYDRANT, ELECTRICAL OVERHEAD, ELECTRICAL UNDERGROUND, ELECTRICAL HANDHOLE, UTILITY POLE / LIGHT POLE, CURB OR BERM (TYPE AS NOTED), EDGE OF PAVEMENT, BUILDING, PAVEMENT, CHAIN LINK FENCE, WOOD FENCE, TREE / SHRUB, TREE LINE, PROPERTY LINE, EASEMENT LINE, BANK / WETLAND FLAG, EDGE OF RIVER / STREAM, 50-FT WETLAND BUFFER, 100-FT WETLAND BUFFER, CONTOUR - MAJOR (5FT), CONTOUR - MINOR (1FT).

PROPOSED

Table listing proposed symbols and their descriptions: SEWER MAIN BYPASS PIPE, SEWER MAIN BYPASS PUMP, SEWER PIPE, GATE VALVE, TEE, BEND, SOLID SLEEVE / CONNECT TO EXISTING, EDGE OF PAVEMENT, PAVEMENT, CHAIN LINK FENCE, BOLLARD, TEST PIT, EROSION CONTROL / STRAW WATTLES, SAWCUT.

ABBREVIATIONS

Table of abbreviations for materials and terms: AIR, FERROUS SULFATE, SHEET, AERATED GRIT CHAMBER EFFLUENT, FINISHED FLOOR ELEVATION, SECONDARY SCUM, ALUM SOLUTION LINE, FLANGE, STEEL, APPROX. APPROXIMATE, FORCE MAIN, SERVICE WATER, AERATION TANK EFFLUENT, FLEXIBLE TUBE, CHLORINE REMOVAL INJECTION WATER, BITUMINOUS, GALVANIZED, SEWER MANHOLE, BLENDED SLUDGE LINE, HHWR, HEATING HOT WATER RETURN, COMPRESSED AIR, HHWS, HEATING HOT WATER SUPPLY, CATCH BASIN, I.D., INSIDE DIAMETER, CAST IRON, INF, INFLUENT, CIW, CHLORINE INJECTION WATER, INV, INVERT, CONC. CONCRETE, LS, LIME SLURRY, COL. COLUMN, MAX. MAXIMUM, C.L. CENTERLINE, MH, MANHOLE, CLF CHAIN LINK FENCE, MIN. MINIMUM, CLS CHLORINE SOLUTION, MJ, MECHANICAL JOINT, CMU CONCRETE MASONRY UNIT, NaS, SODIUM SULFIDE, CTE CONNECT TO EXISTING, NaOH, SODIUM HYDROXIDE, CU COPPER, O.C. ON CENTER, CW CITY WATER, O.D. OUTSIDE DIAMETER, DI DUCTILE IRON, PE, PRIMARY EFFLUENT, DIA. DIAMETER, PSC, PRIMARY SCUM, DW DEWATERING, PSL, PRIMARY SLUDGE LINE, DWY DRIVEWAY, PROP. PROPOSED, ECC. ECCENTRIC, PVC, POLYVINYL CHLORIDE, EFC EFFLUENT FROM FILTER CELLS, RCP, REINFORCED CONCRETE PIPE, EFF EFFLUENT, RFO, REJECT FROM FILTER CELLS, EFW EFFLUENT FLUSHING WATER, R&D, REMOVE AND DISPOSE, EL ELEVATION, R&R, REMOVE AND RESET, EOP EDGE OF PAVEMENT, RSL, RETURN SLUDGE LINE, EXIST. EXISTING, SCH, SCHEDULE, FE FINAL EFFLUENT, SDS, CHLORINE REMOVAL, FeCL FERRIC CHLORIDE, SG, SLIDE GATE / SLUICE GATE

GENERAL NOTES

- 1. VERTICAL DATUM = NAVD 88 AND HORIZONTAL COORDINATES ARE IN RHODE ISLAND STATE PLANE COORDINATE SYSTEM (NAD 83).
2. FEMA MAP NUMBER 44007C0135G EFFECTIVE MARCH 2, 2009 INDICATES THE TREATMENT PLANT IS LOCATED IN A ZONE AE FLOOD PLAIN WITH BASE FLOOD ELEVATION OF 315.60 (NAVD 88) AND THE OAKLAND PUMP STATION IS LOCATED IN A ZONE AE FLOOD PLAIN WITH BASE FLOOD ELEVATION OF 313.0 (NAVD 88).
3. THE MOST CURRENT VERSION OF THE BURRILLVILLE SEWER COMMISSION'S CONSTRUCTION STANDARDS SHALL CONTROL, EXCEPT WHERE OTHERWISE SPECIFIED OR SHOWN IN THE CONTRACT DOCUMENTS.
4. EXISTING BUILDING CONDITIONS AT THE TREATMENT PLANT DIGITIZED/SCANNED FROM 'WASTEWATER TREATMENT FACILITIES' RECORD DRAWINGS, 1977 (METCALF & EDDY, INC.), A SURVEY BY MARC N. NYBERG ASSOCIATES, INC. DATED MAY 20, 2014, RHODE ISLAND GIS INFORMATION, AND FIELD EDITS BY BETA GROUP, INC.
5. EXISTING BUILDING CONDITIONS AT THE OAKLAND PUMP STATION DIGITIZED/SCANNED FROM 'SANITARY SEWERS, PUMP STATIONS AND APPURTENANT WORK FOR OAKLAND / MAPLEVILLE' RECORD DRAWINGS, 1992 (BETA ENGINEERING, INC.), RHODE ISLAND GIS INFORMATION, AND FIELD EDITS BY BETA GROUP, INC.
6. THE LIMIT OF WORK SHOWN AT THE TREATMENT PLANT IS WITHIN PROPERTY OWNED BY THE TOWN OF BURRILLVILLE, RI, ASSESSOR'S PARCEL 161-040. THE LIMIT OF WORK SHOWN AT OAKLAND PUMP STATION IS WITHIN PROPERTY OWNED BY THE TOWN OF BURRILLVILLE, RI, ASSESSOR'S PARCEL 179-116 AND THE TEMPORARY CONSTRUCTION EASEMENT. THE CONTRACTOR IS RESPONSIBLE FOR ALL REQUIRED PERMITS AND/OR FEES ASSOCIATED WITH WORK. CONTRACTOR SHALL NOT WORK OUTSIDE LIMITS OF PROPOSED WORK WITHOUT WRITTEN PERMISSION OF THE PROPERTY OWNER AND THE TOWN.
7. EXISTING UTILITIES HAVE BEEN PLOTTED FROM THE BEST AVAILABLE DATA AND AS APPROXIMATE ONLY. THE CONTRACTOR MUST NOTIFY DIG SAFE PRIOR TO ANY EXCAVATION, DEMOLITION WORK IN PUBLIC OR PRIVATE WAYS OR UTILITY COMPANY RIGHT OF WAY OR EASEMENT (PUBLIC AND PRIVATE). THE LOCATION, SIZE, AND MATERIAL OF EXISTING PIPES, DUCTS, CONDUITS AND OTHER UNDERGROUND STRUCTURES AND/OR UTILITIES SHOWN ON THESE PLANS ARE FROM THE BEST SOURCES AVAILABLE AT PRESENT AND ARE NOT WARRANTED TO BE EXACT, NOR IS IT WARRANTED THAT ALL UNDERGROUND PIPES, UTILITIES OR STRUCTURES ARE SHOWN. EXACT LOCATIONS TO BE DETERMINED IN THE FIELD BY THE CONTRACTOR.
8. WHERE AN EXISTING UTILITY IS FOUND TO CONFLICT WITH THE PROPOSED WORK, THE LOCATION, ELEVATION AND SIZE OF THE UTILITY SHALL BE ACCURATELY DETERMINED WITHOUT DELAY BY THE CONTRACTOR, AND THE INFORMATION FURNISHED TO THE ENGINEER FOR THE RESOLUTION OF THE CONFLICT.
9. THE CONTRACTOR SHALL ALTER THE MASONRY OF THE TOP SECTION OF ALL EXISTING DRAINAGE AND SANITARY STRUCTURES AS NECESSARY FOR THE CHANGES IN GRADE, AND RESET ALL WATER, AND DRAINAGE FRAMES, GRATES AND BOXES TO THE PROPOSED FINISH SURFACE GRADE. REQUIRED NEW MASONRY SHALL BE CLAY BRICK CONFORMING TO RHODE ISLAND STANDARDS, OR APPROVED ALTERNATE MATERIAL.
10. THE CONTRACTOR SHALL MAKE ALL ARRANGEMENTS FOR THE ALTERATION AND ADJUSTMENT OF GAS, ELECTRIC, TELEPHONE, CABLE TV, FIRE ALARM AND ANY OTHER PRIVATE UTILITIES BY THE UTILITY COMPANIES.
11. AREAS OUTSIDE THE LIMITS OF PROPOSED WORK DISTURBED BY THE CONTRACTOR'S OPERATIONS SHALL BE RESTORED BY THE CONTRACTOR TO THEIR ORIGINAL CONDITION OR BETTER AT THE CONTRACTOR'S EXPENSE.
12. THE TERM "PROPOSED" (PROP.) MEANS WORK TO BE CONSTRUCTED USING NEW MATERIALS OR, WHERE APPLICABLE, RE-USING EXISTING MATERIALS IDENTIFIED AS "REMOVE AND RESET" (R&R).
13. WHERE EXISTING MATERIALS ARE ENCOUNTERED WHICH, IN THE OPINION OF THE OWNER/ENGINEER ARE UNSUITABLE FOR BEDDING, BACK FILLING OR OTHER INTENDED USE, SUCH MATERIALS SHALL BE REMOVED AS DIRECTED AND REPLACED BY THE CONTRACTOR WITH SUITABLE CRUSHED STONE OR BORROW, AS DIRECTED BY THE OWNER/ENGINEER.
14. JOINTS BETWEEN NEW BITUMINOUS CONCRETE ROADWAY PAVEMENT AND SAWCUT EXISTING PAVEMENT SHALL BE SEALED WITH BITUMEN AND BACKSANDS.
15. CATCH BASIN AND MANHOLE FRAMES AND GRATES/COVERS SHALL CLEARLY ALIGN WITH THE OPENINGS IN THE PRECAST STRUCTURES AND THE GRADE OF THE ROADWAY.
16. CONTRACTOR SHALL VERIFY EXISTING GRADE ELEVATIONS. IF ANY ADJUSTMENT IS REQUIRED DUE TO DIFFERENT EXISTING GRADES FOUND IN THE FIELD, THE CONTRACTOR SHALL NOTIFY AND SEEK THE APPROVAL OF THE ENGINEER PRIOR TO PERFORMING THE WORK.
17. EXCEPT WHERE NOTED BY PROPOSED CONTOUR LINES AND/OR SPOT GRADES, ALL FINAL CONTOUR LINE ELEVATIONS SHALL BE THE SAME AS EXISTING CONTOUR LINE ELEVATIONS.

CONSTRUCTION NOTES

- 1. THE INSTALLATION, TESTING, FUEL, AND MAINTENANCE OF THE BYPASS PUMPING SYSTEM SHALL BE THE RESPONSIBILITY OF THE CONTRACTOR. THE CONTRACTOR SHALL COORDINATE ALL CONSTRUCTION OPERATIONS AND MAINTENANCE ACTIVITIES ASSOCIATED WITH THE BYPASS AND BYPASS CONTROLS WITH THE OWNER. THE BYPASS SYSTEM DEPICTED ON THE CONTRACT PLANS IS FOR GENERAL INFORMATION ONLY. THE DESIGN AND LAYOUT IS THE RESPONSIBILITY OF THE CONTRACTOR. SUBMIT DETAILED SHOP DRAWINGS OF THE SPECIFIED BYPASS PUMPS, PIPING, FLOW METER, AND APPURTENANCES FOR THE BYPASS PUMPING SYSTEM IN ACCORDANCE WITH SECTION 01300 - SUBMITTALS AND SECTION 02149 - MAINTAINING EXISTING FLOW. INCLUDE CAPAOWNER DATA AND CONTROL SYSTEM DESCRIPTION FOR THE PUMPS.
2. CONTRACTOR SHALL SUBMIT DESCRIPTIONS OF THE PROCEDURES FOR INSTALLING THE BYPASS SYSTEM AND FOR OPERATING THE BYPASS PUMPING ARRANGEMENT. REFER TO SPECIFICATION SECTION 02149. THE OWNER, ENGINEER, AND CONTRACTOR SHALL BE PRESENT FOR TESTING AND CUT OVER OF BYPASS CONTROLS AND BYPASS PUMPING.
3. THE BYPASS SYSTEM, INCLUDING PUMPS, PIPING, AUTOMATIC LEVEL CONTROL AND ALARM ANNUNCIATION, SHALL BE IN PLACE, TESTED, AUTOMATICALLY OPERATED FOR UP TO THREE DAYS AND APPROVED BY THE OWNER PRIOR TO COMMENCING WORK IN THE STATION.
4. ALL TOWN OF BURRILLVILLE OWNED VALVES AND EQUIPMENT ARE TO BE OPERATED BY TOWN OF BURRILLVILLE PERSONNEL ONLY. ENGINEER TO COORDINATE WITH BURRILLVILLE DPW FOR ALL VALVE OPERATIONS.
8. THROUGHOUT BYPASS PUMPING, THE CONTRACTOR SHALL BE SOLELY RESPONSIBLE FOR MAINTAINING EXISTING FLOWS, OPERATING AND MAINTAINING THEIR BYPASS SYSTEM.
9. DISTURBED AREAS SHALL BE RESTORED AT NO ADDITIONAL COST TO THE OWNER.
10. DISTURBED GRASSED AREAS SHALL BE RESTORED IN ACCORDANCE WITH SPECIFICATION SECTION 02930.
11. DISTURBED PAVED AREAS SHALL BE RESTORED IN ACCORDANCE WITH SPECIFICATION SECTION 02500 AND DETAIL SHOWN ON CD-3.
12. THE CONTRACTOR SHALL PROTECT EXISTING MONITORING WELLS PRESENT ON THE SITE. DAMAGED MONITORING WELLS SHALL BE REPLACED BY THE CONTRACTOR AT NO ADDITIONAL COST TO THE OWNER.

ENVIRONMENTAL NOTES

- 1. SEE SPECIFICATION SECTION 02055 - REMOVAL AND DISPOSAL OF UNDERGROUND STORAGE TANKS AND 02075 - REMOVAL AND DISPOSAL OF PETROLEUM CONTAMINATED SOIL FOR REQUIREMENTS.

YARD PIPING NOTES

- 1. INVERTS AND DIRECTIONS OF PIPES AND CONDUITS ARE SHOWN FOR THE PURPOSE OF INDICATING THE BASIC PARAMETERS USED DURING THE DESIGN. HOWEVER, MINOR CHANGES IN HORIZONTAL AND VERTICAL LOCATIONS MAY BE REQUIRED DURING CONSTRUCTION AS FIELD CONDITIONS WARRANT. FINAL LOCATIONS OF OTHER PIPES AND/OR CONDUITS SHALL BE DETERMINED IN THE FIELD. ANY CHANGES SHALL BE APPROVED BY THE ENGINEER.
2. CONTRACTOR SHALL CONDUCT TEST PITS AS SHOWN AND AS REQUIRED IN ORDER TO ASCERTAIN THE EXACT LOCATION OF EXISTING UNDERGROUND UTILITIES, TO FIELD VERIFY THE EXACT SIZE, MATERIAL, LOCATION, INVERT ELEVATION AND ALIGNMENT (VERTICAL AND HORIZONTAL) OF EXISTING UNDERGROUND UTILITIES, PIPES, AND STRUCTURES.
3. UNLESS OTHERWISE NOTED, MINIMUM COVER FOR PIPES AND/OR DUCTS SHALL BE AS FOLLOWS: WATER 5'-0"; SEWER 4'-6"; DRAIN 4'-0"; GAS 3'-6"; ELECTRIC 2'-6". ANY PIPE AND/OR DUCT WITH LESS THAN 2'-0" OF COVER SHALL HAVE AN ADDITIONAL 6" OF CONCRETE ENCASEMENT ON THE UPPER PORTION.
4. EXISTING PIPES RETAINED, BUT WHICH MUST BE REMOVED IN ORDER TO INSTALL NEW PIPES, SHALL BE REINSTALLED OR REPLACED IN KIND.
5. ALL PIPING SHALL BE PROVIDED WITH FLEXIBLE DRESSER STYLE CONNECTIONS WHERE EXITING OR ENTERING STRUCTURES AND BUILDINGS. FLEXIBLE DRESSER STYLE CONNECTIONS SHALL BE COORDINATED WITH PIPE MANUFACTURER AND APPROVED BY THE ENGINEER.
6. ALL NEW PIPING REQUIRED TO BE INSTALLED UNDER THIS CONTRACT IS SHOWN IN BOLD LINES. ALL EXISTING PIPING IS SCREENED.
7. ALL NEW AND EXISTING PIPING BEING INSTALLED SHALL BE SUITABLY SUPPORTED AND BRACED AT ALL TIMES BY THE CONTRACTOR.
8. THE CONTRACTOR SHALL PROVIDE CONCRETE THRUST BLOCKS FOR ALL UNDERGROUND PIPING, BENDS AND TEES IN PRESSURE LINES AS DETAILED AND SPECIFIED.
9. CONCRETE CLOSURE COLLARS, FIELD FABRICATED ELBOWS AND/OR SPECIAL BENDS ROTATED AS NECESSARY SHALL BE INSTALLED TO ALIGN NEW PIPING WITH EXISTING PIPING.
10. PROVIDE SEPARATION BETWEEN SEWER/DRAIN/WATER TO THE MAXIMUM EXTENT FEASIBLE IN ACCORDANCE WITH THE TOWN OF BURRILLVILLE'S CONSTRUCTION STANDARDS.


PLAN INDEX

Table with columns SHEET NO. and DESCRIPTION. Lists sheets for COVER, CIVIL, STRUCTURAL, MECHANICAL, HVAC, PLUMBING, and ELECTRICAL, including descriptions like WWTF - EXISTING SITE PLAN, OAKLAND PS - EXISTING SITE PLAN, etc.

PREPARED BY



REGISTERED PROFESSIONAL

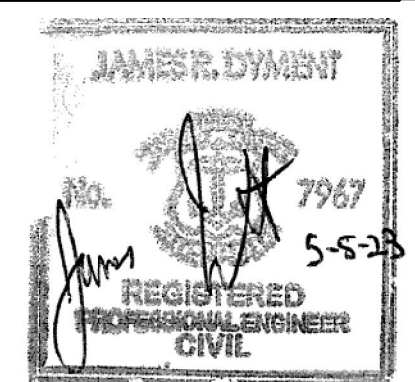

SUBCONSULTANT

PROJECT

BURRILLVILLE WWTF HEADWORKS & OAKLAND PUMP STATION IMPROVEMENTS

BURRILLVILLE, RI

TITLE

LEGEND, GENERAL NOTES, & INDEX

Table with columns NO., REVISIONS, and DATE. Contains revision information.

Table with columns DRAWN BY, DESIGNED BY, CHECKED BY, and ISSUE DATE. Lists project personnel and dates.

BETA JOB NO.: 6861-105

SCALE

NONE

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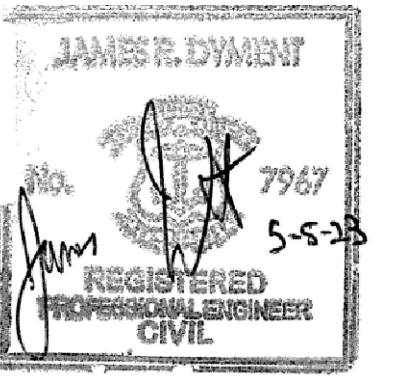
SHEET NO.

G-1

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REGISTERED PROFESSIONAL



SUBCONSULTANT

PROJECT

BURRILLVILLE WWTF HEADWORKS & OAKLAND PUMP STATION IMPROVEMENTS

BURRILLVILLE, RI

TITLE

WWTF - EXISTING SITE PLAN

NO.	REVISIONS	DATE

DRAWN BY:	CJM
DESIGNED BY:	AJG
CHECKED BY:	JRD
ISSUE DATE:	MAY 2023
BETA JOB NO.:	6861-105

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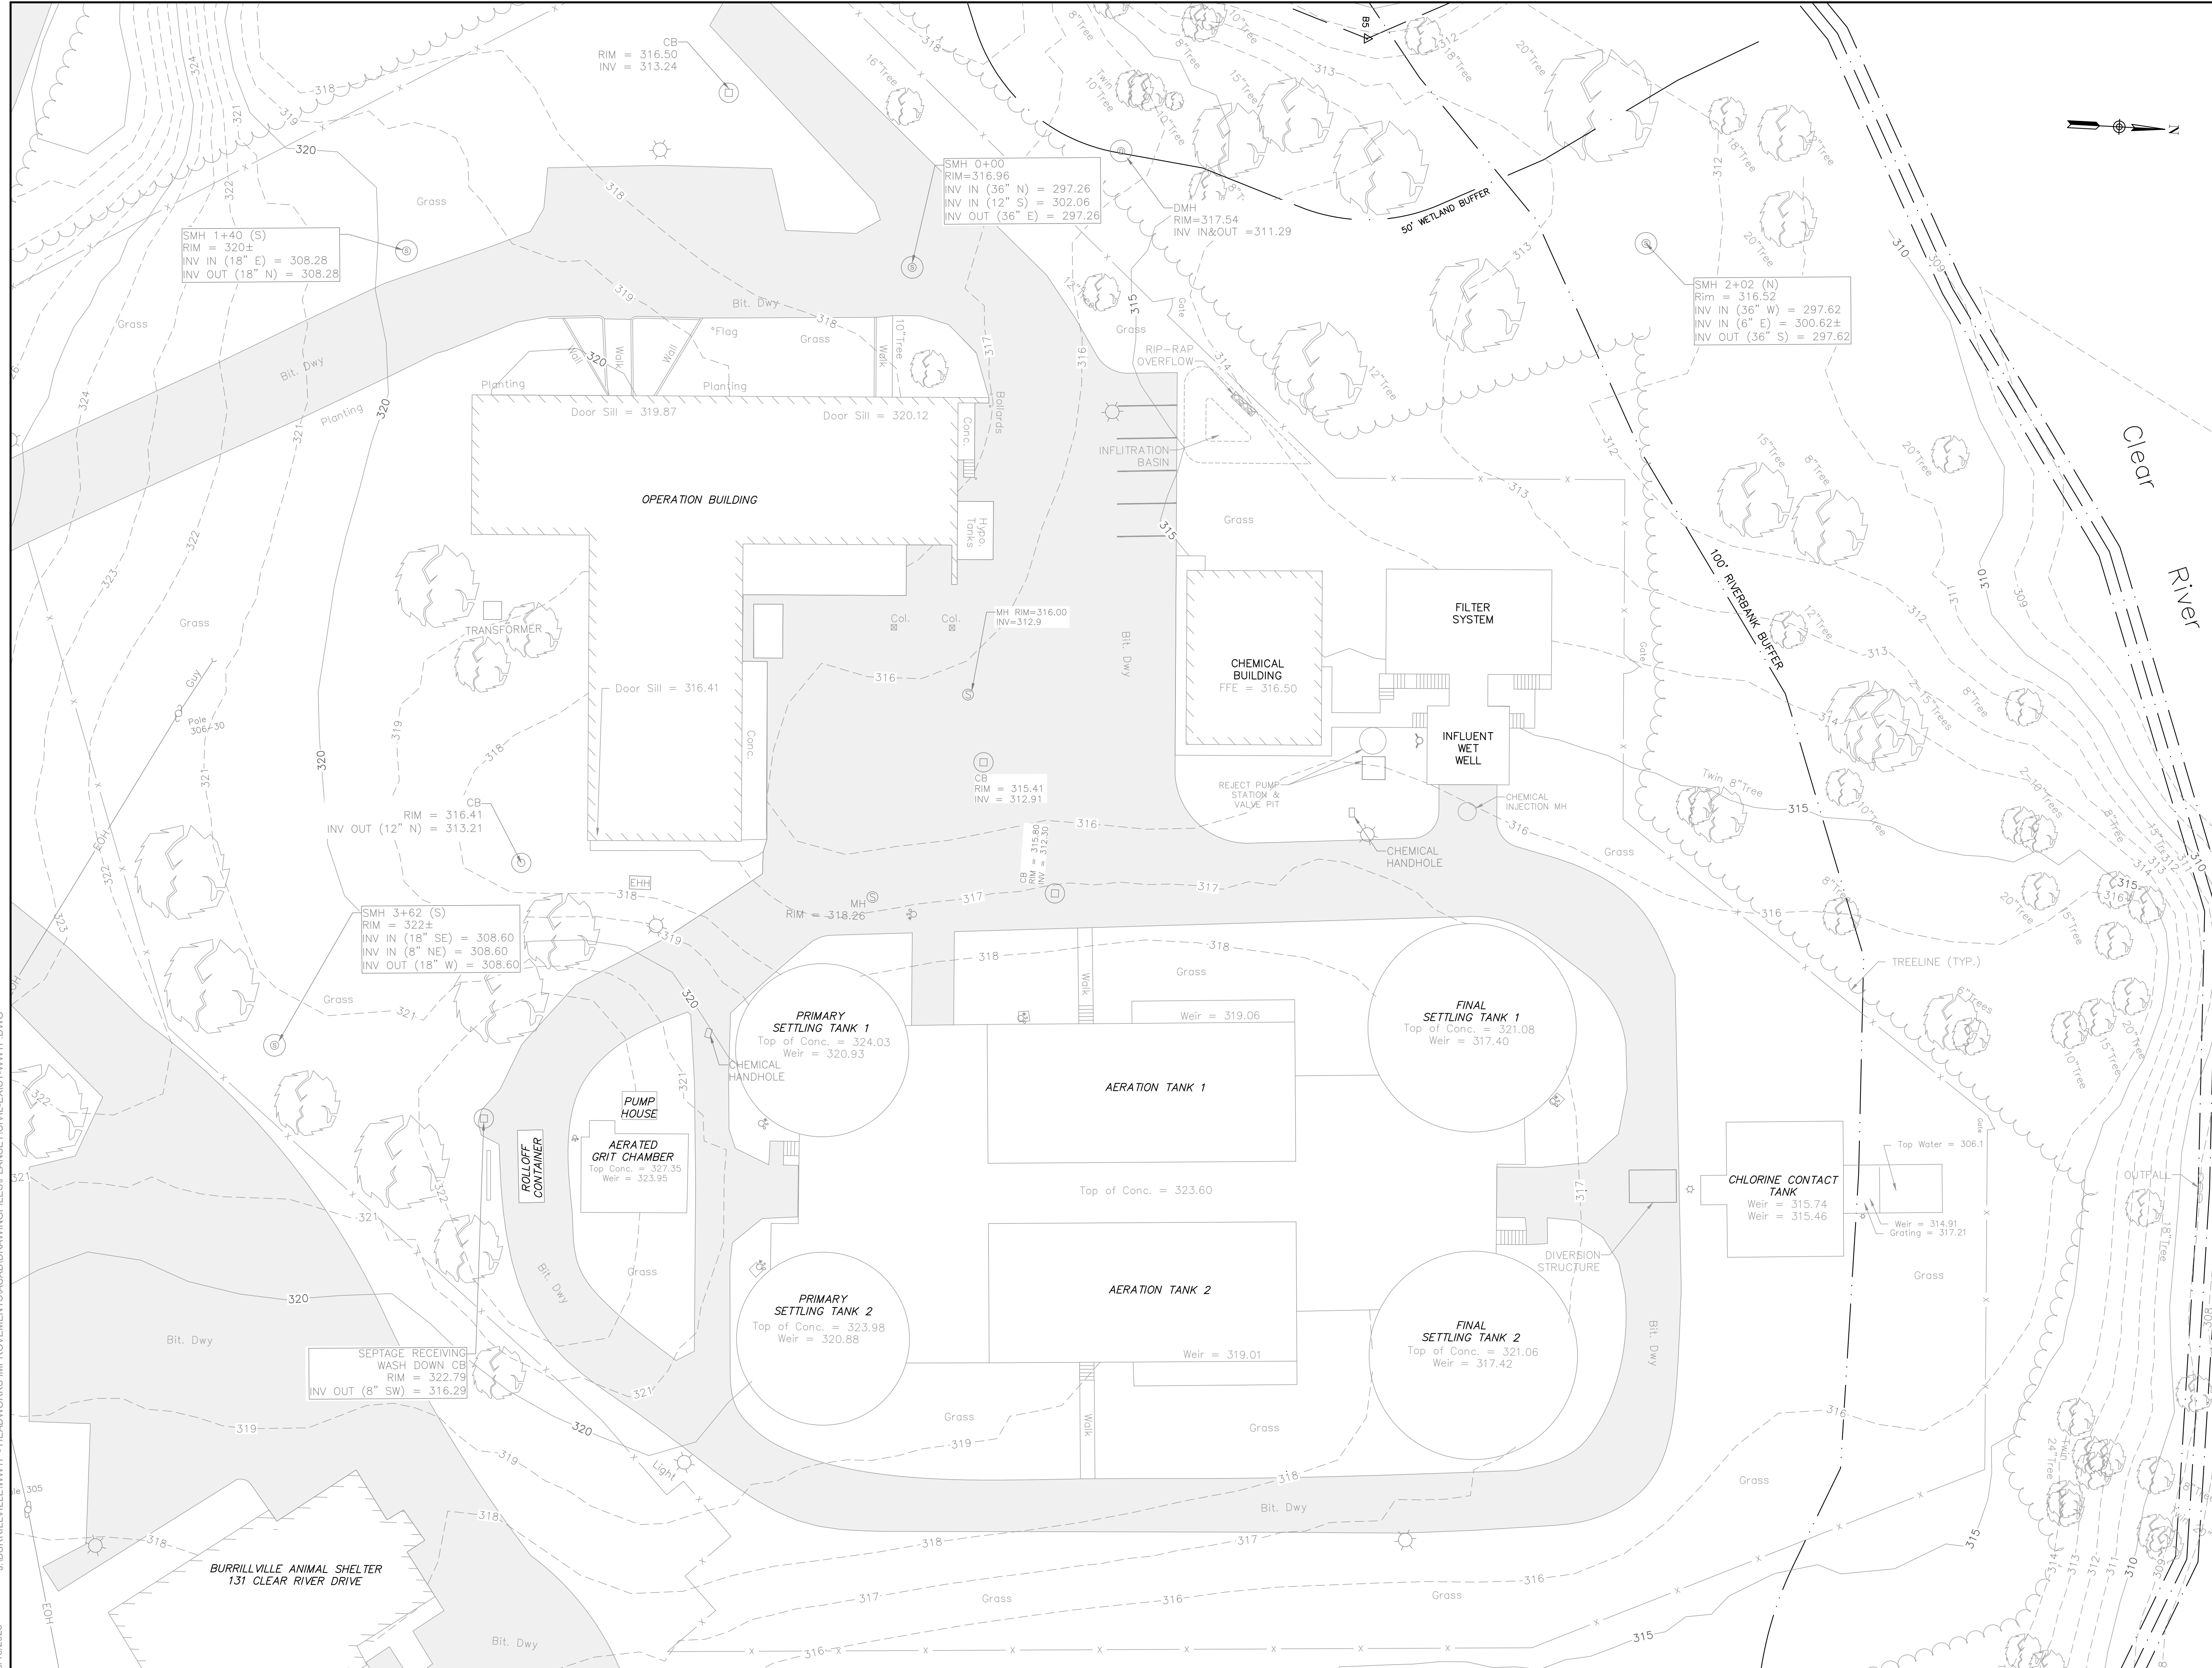


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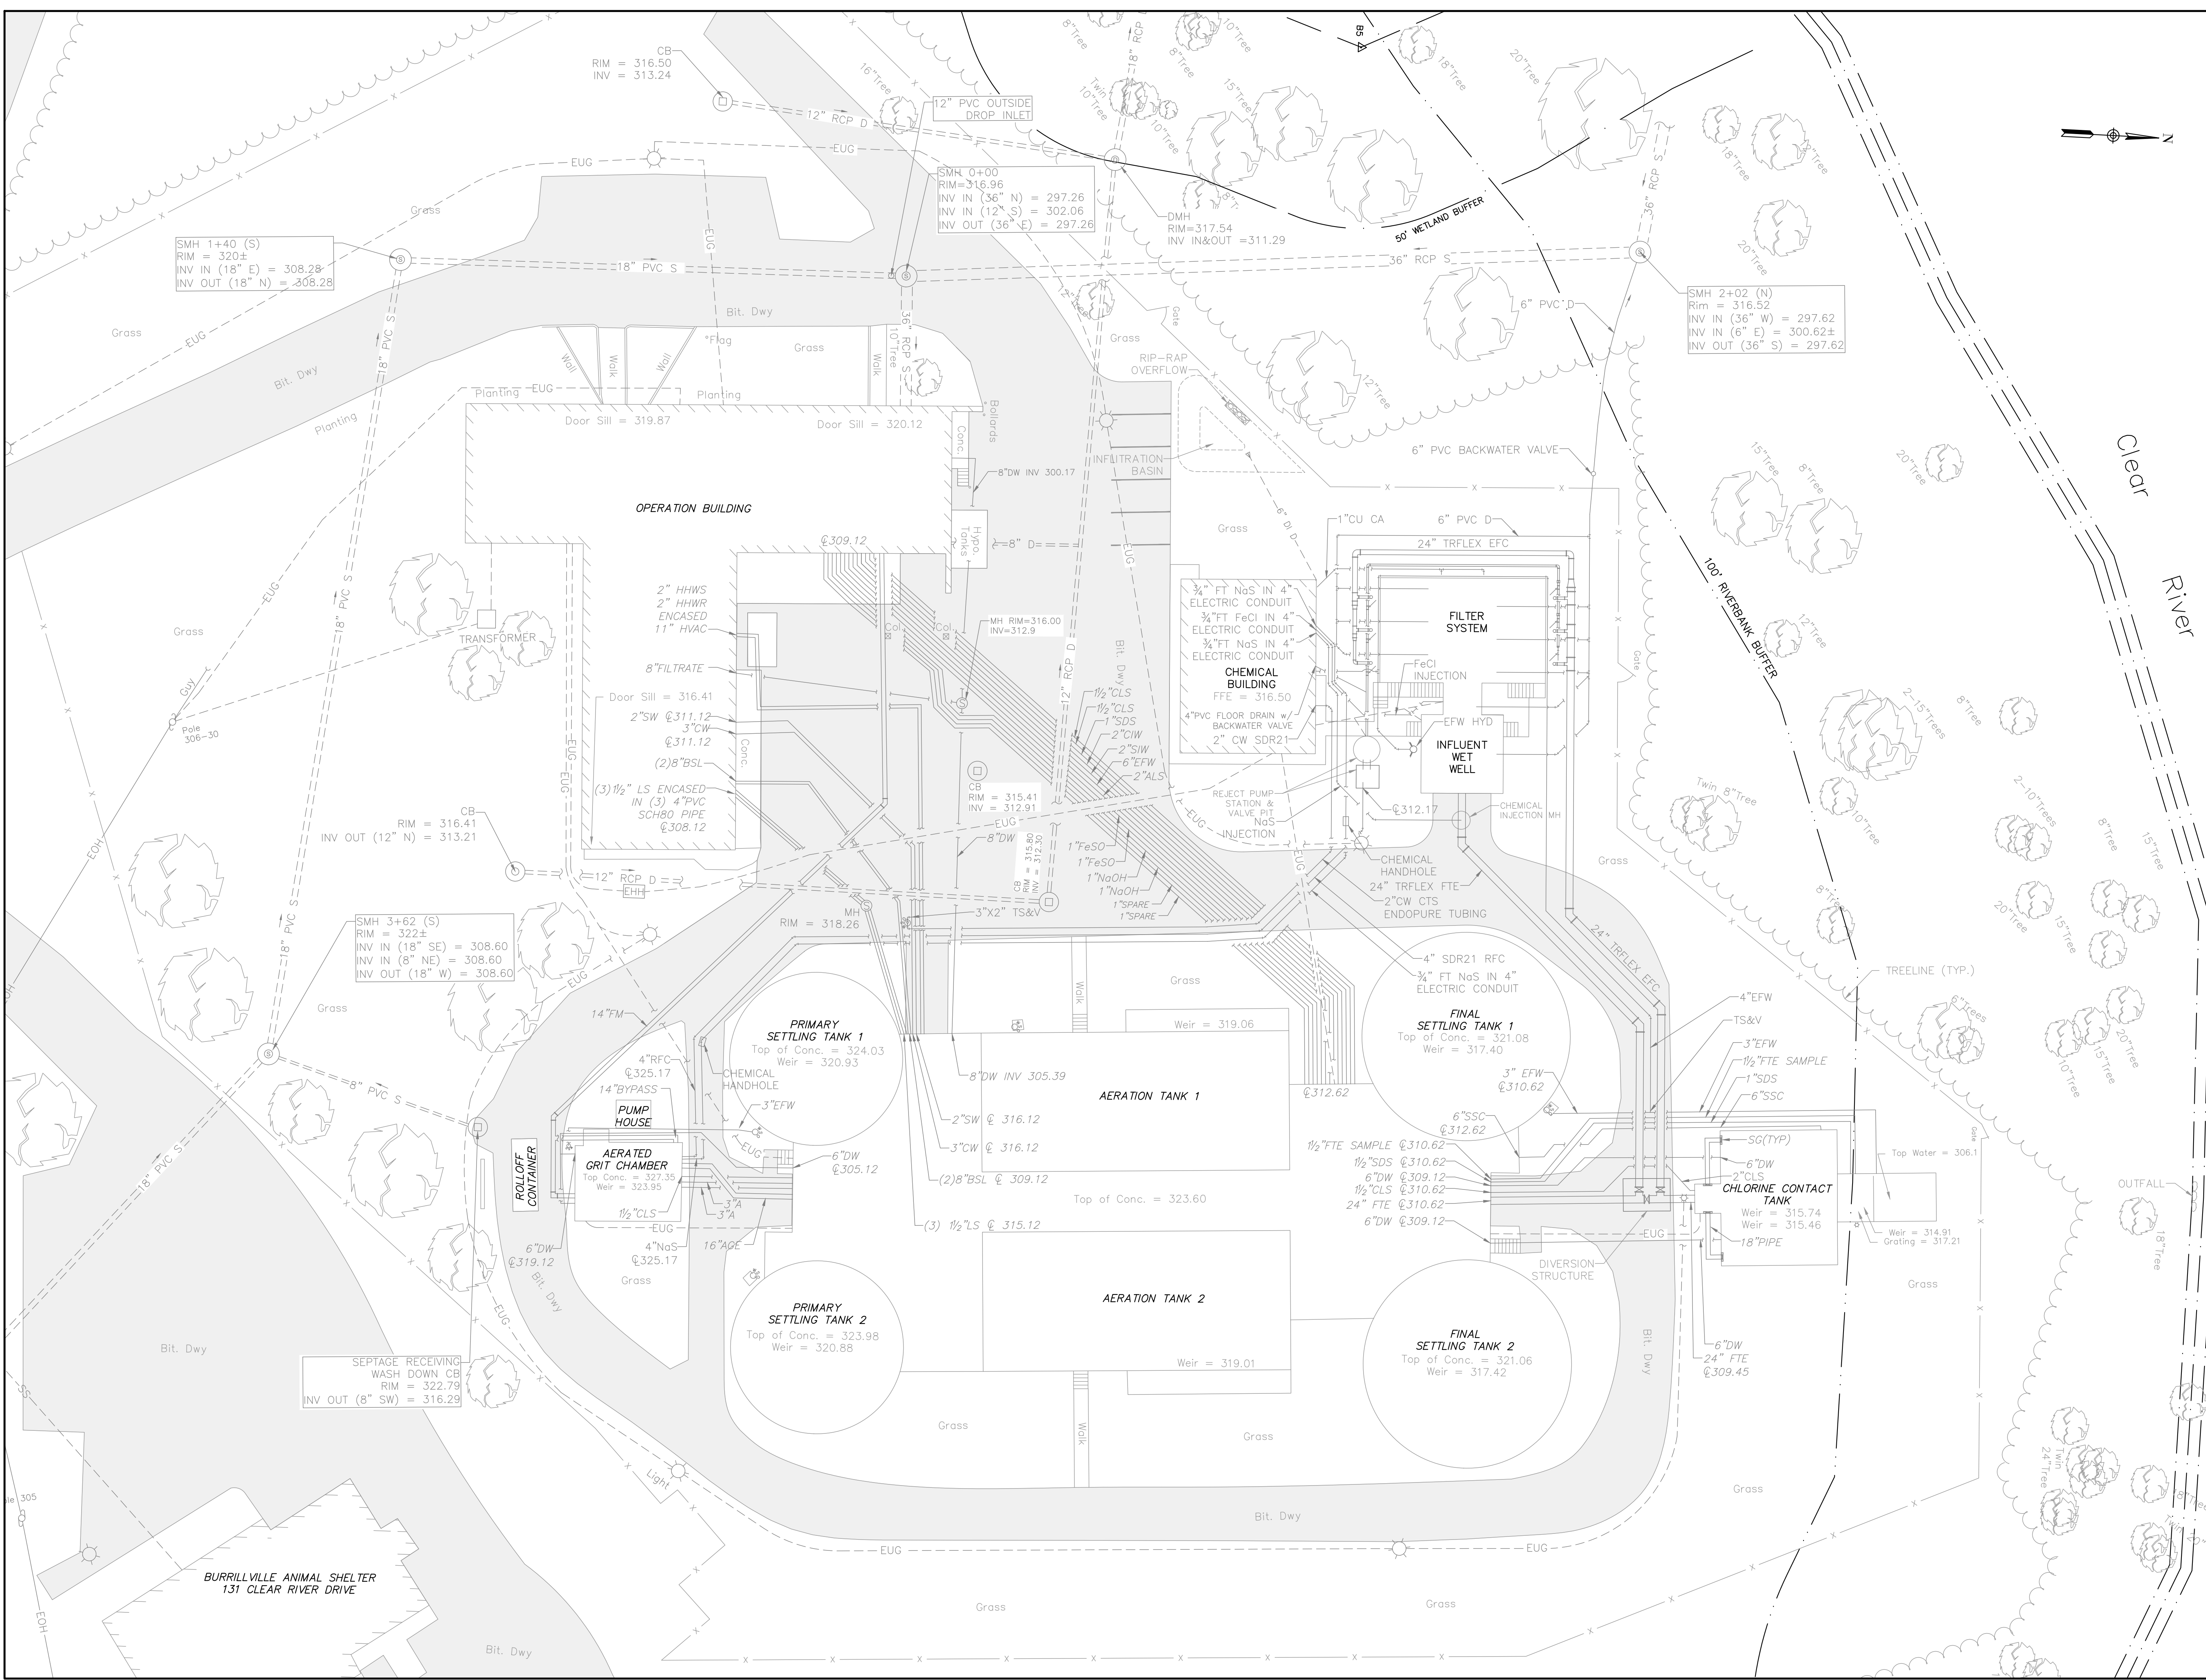
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5/16/2023



PREPARED BY
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REGISTERED PROFESSIONAL ENGINEER
CIVIL

SUBCONSULTANT
PROJECT
**BURRILLVILLE WWTF
HEADWORKS &
OAKLAND PUMP
STATION
IMPROVEMENTS**

BURRILLVILLE, RI
TITLE
**WWTF -
EXISTING YARD
PIPING PLAN**

NO.	REVISIONS	DATE

DRAWN BY: CJM
DESIGNED BY: AJG
CHECKED BY: JRD
ISSUE DATE: MAY 2023
BETA JOB NO.: 6861-105


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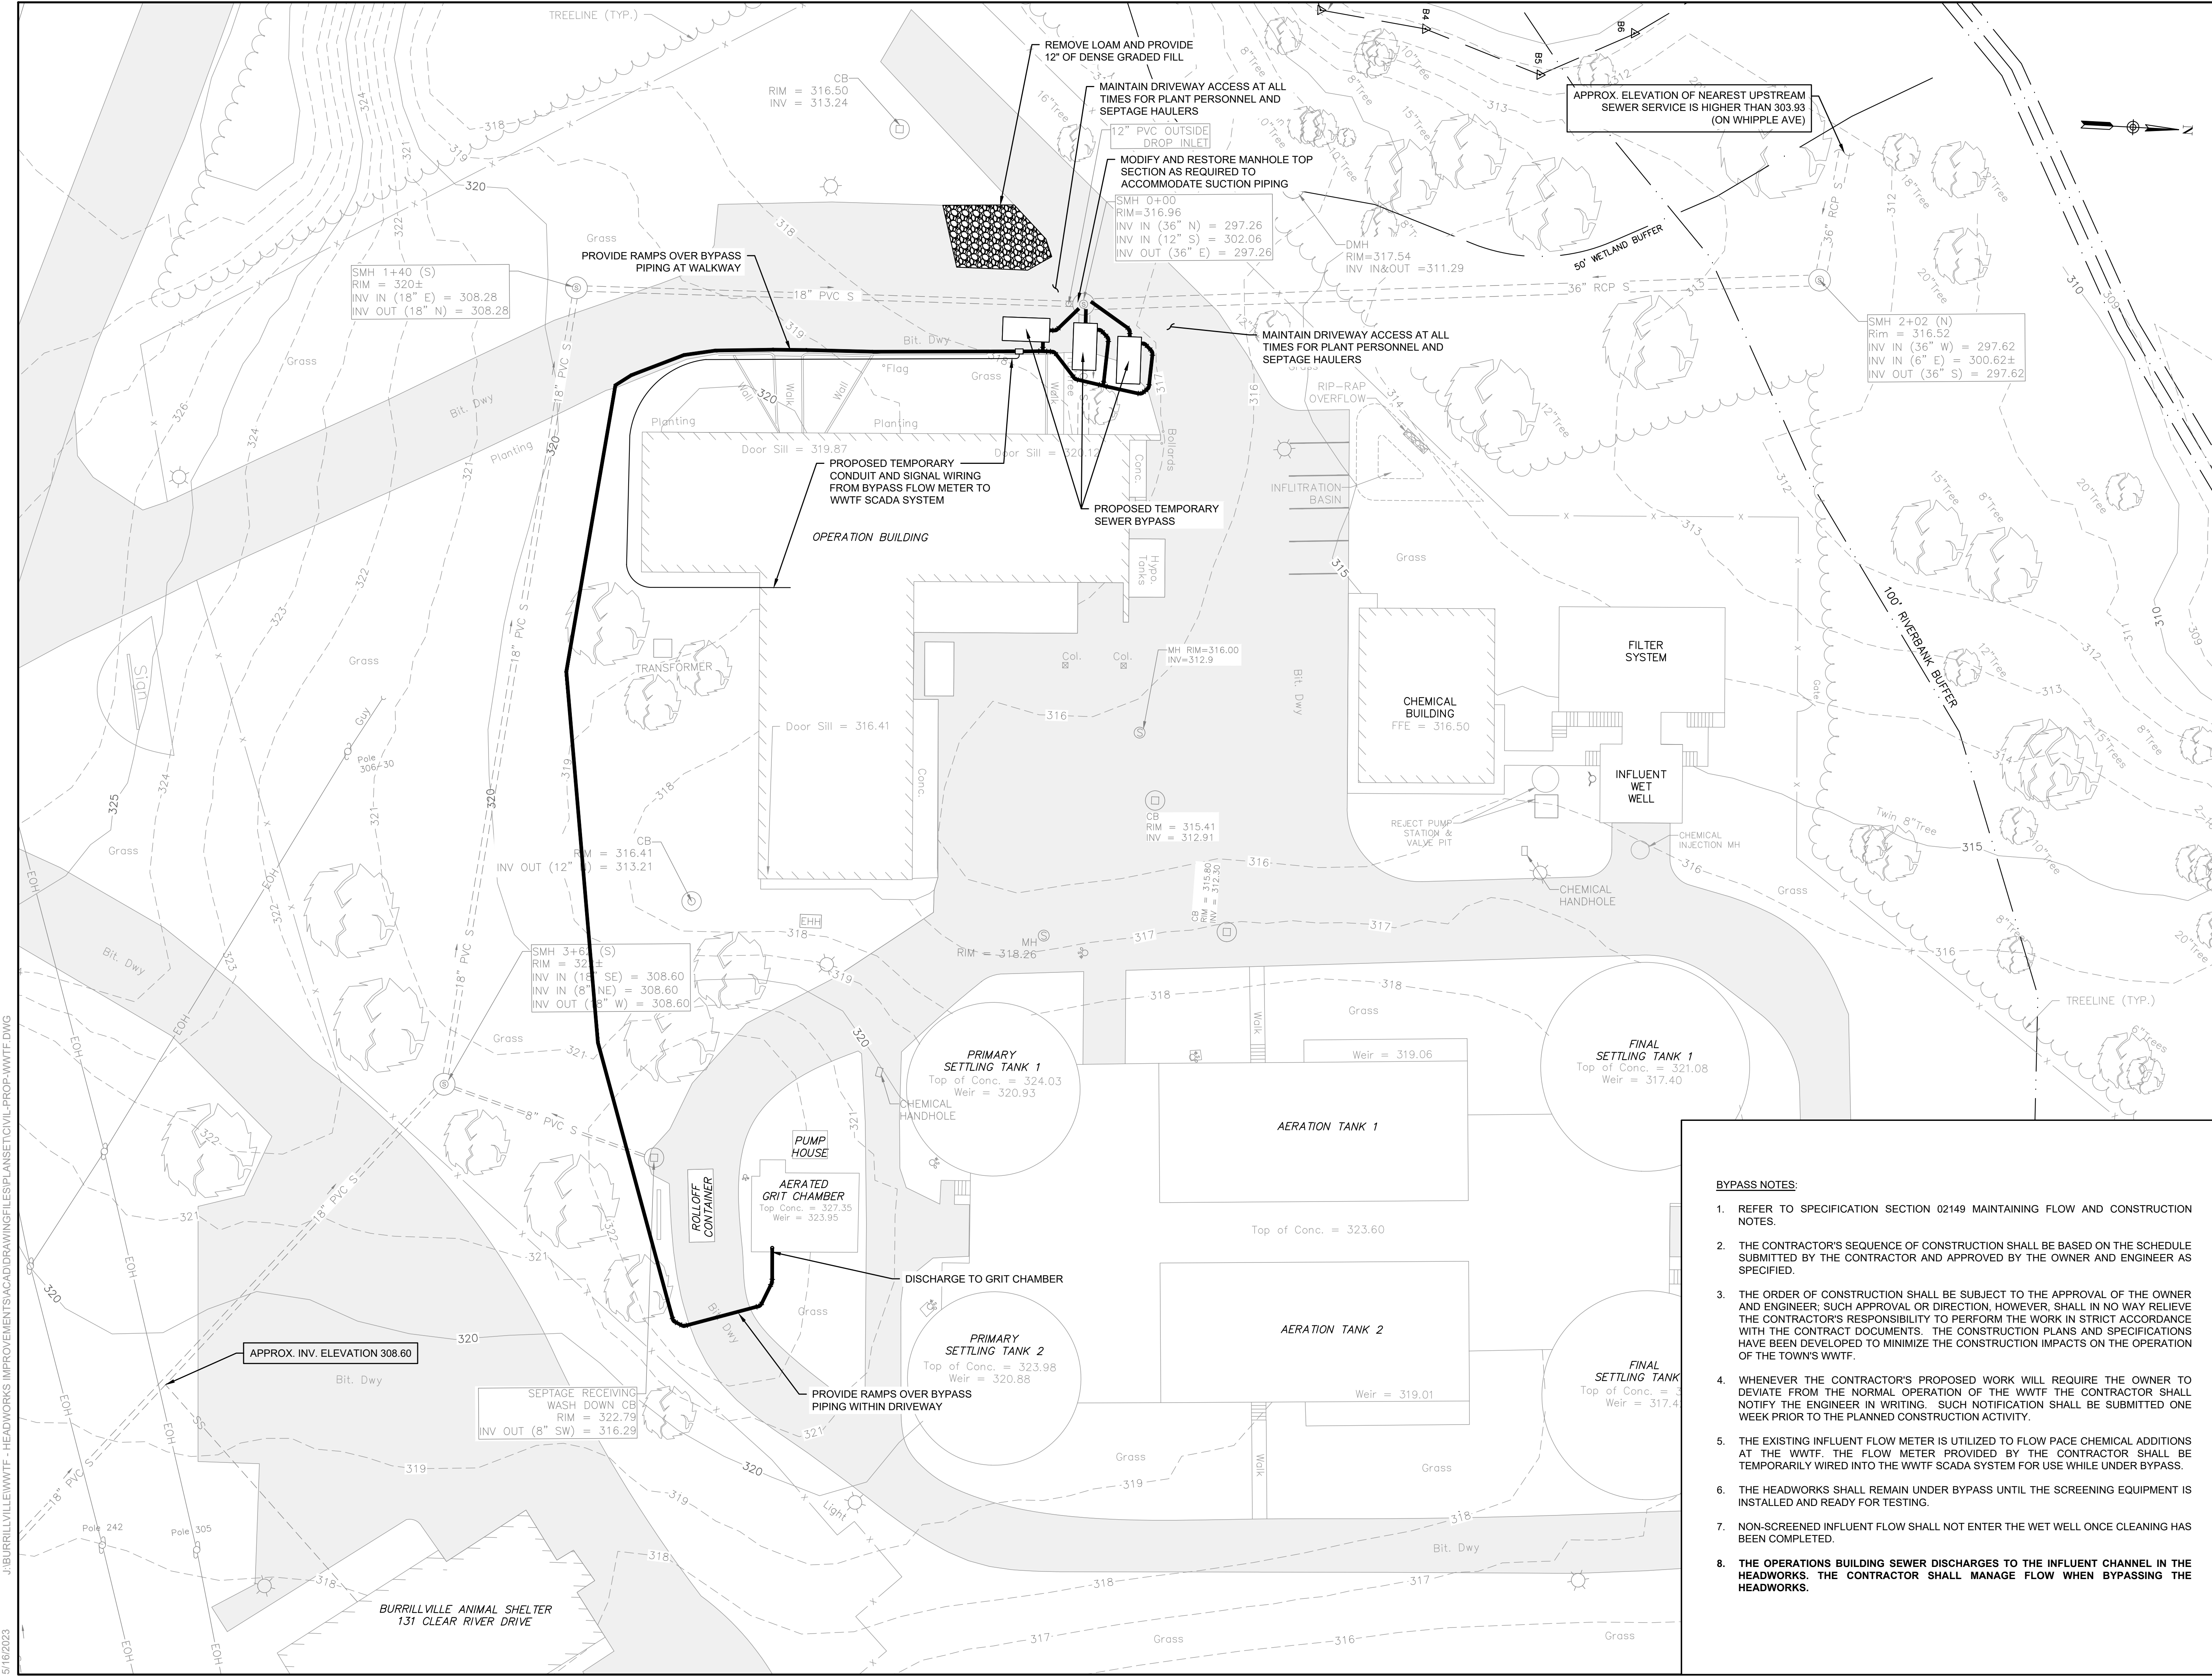
PROJECT

BURRILLVILLE WWTF HEADWORKS & OAKLAND PUMP STATION IMPROVEMENTS

BURRILLVILLE, RI

TITLE

WWTF - PROPOSED BYPASS PLAN

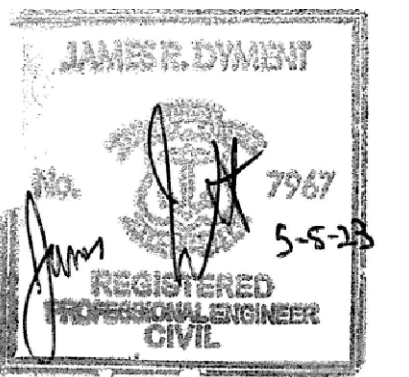

BYPASS NOTES:

- REFER TO SPECIFICATION SECTION 02149 MAINTAINING FLOW AND CONSTRUCTION NOTES.
- THE CONTRACTOR'S SEQUENCE OF CONSTRUCTION SHALL BE BASED ON THE SCHEDULE SUBMITTED BY THE CONTRACTOR AND APPROVED BY THE OWNER AND ENGINEER AS SPECIFIED.
- THE ORDER OF CONSTRUCTION SHALL BE SUBJECT TO THE APPROVAL OF THE OWNER AND ENGINEER; SUCH APPROVAL OR DIRECTION, HOWEVER, SHALL IN NO WAY RELIEVE THE CONTRACTOR'S RESPONSIBILITY TO PERFORM THE WORK IN STRICT ACCORDANCE WITH THE CONTRACT DOCUMENTS. THE CONSTRUCTION PLANS AND SPECIFICATIONS HAVE BEEN DEVELOPED TO MINIMIZE THE CONSTRUCTION IMPACTS ON THE OPERATION OF THE TOWN'S WWTF.
- WHENEVER THE CONTRACTOR'S PROPOSED WORK WILL REQUIRE THE OWNER TO DEVIATE FROM THE NORMAL OPERATION OF THE WWTF THE CONTRACTOR SHALL NOTIFY THE ENGINEER IN WRITING. SUCH NOTIFICATION SHALL BE SUBMITTED ONE WEEK PRIOR TO THE PLANNED CONSTRUCTION ACTIVITY.
- THE EXISTING INFLUENT FLOW METER IS UTILIZED TO FLOW PACE CHEMICAL ADDITIONS AT THE WWTF. THE FLOW METER PROVIDED BY THE CONTRACTOR SHALL BE TEMPORARILY WIRED INTO THE WWTF SCADA SYSTEM FOR USE WHILE UNDER BYPASS.
- THE HEADWORKS SHALL REMAIN UNDER BYPASS UNTIL THE SCREENING EQUIPMENT IS INSTALLED AND READY FOR TESTING.
- NON-SCREENED INFLUENT FLOW SHALL NOT ENTER THE WET WELL ONCE CLEANING HAS BEEN COMPLETED.
- THE OPERATIONS BUILDING SEWER DISCHARGES TO THE INFLUENT CHANNEL IN THE HEADWORKS. THE CONTRACTOR SHALL MANAGE FLOW WHEN BYPASSING THE HEADWORKS.


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DESIGNED BY:	AJG
CHECKED BY:	JRD
ISSUE DATE:	MAY 2023
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
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5/16/2023

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5/16/2023




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PROJECT

BURRILLVILLE WWTF HEADWORKS & OAKLAND PUMP STATION IMPROVEMENTS

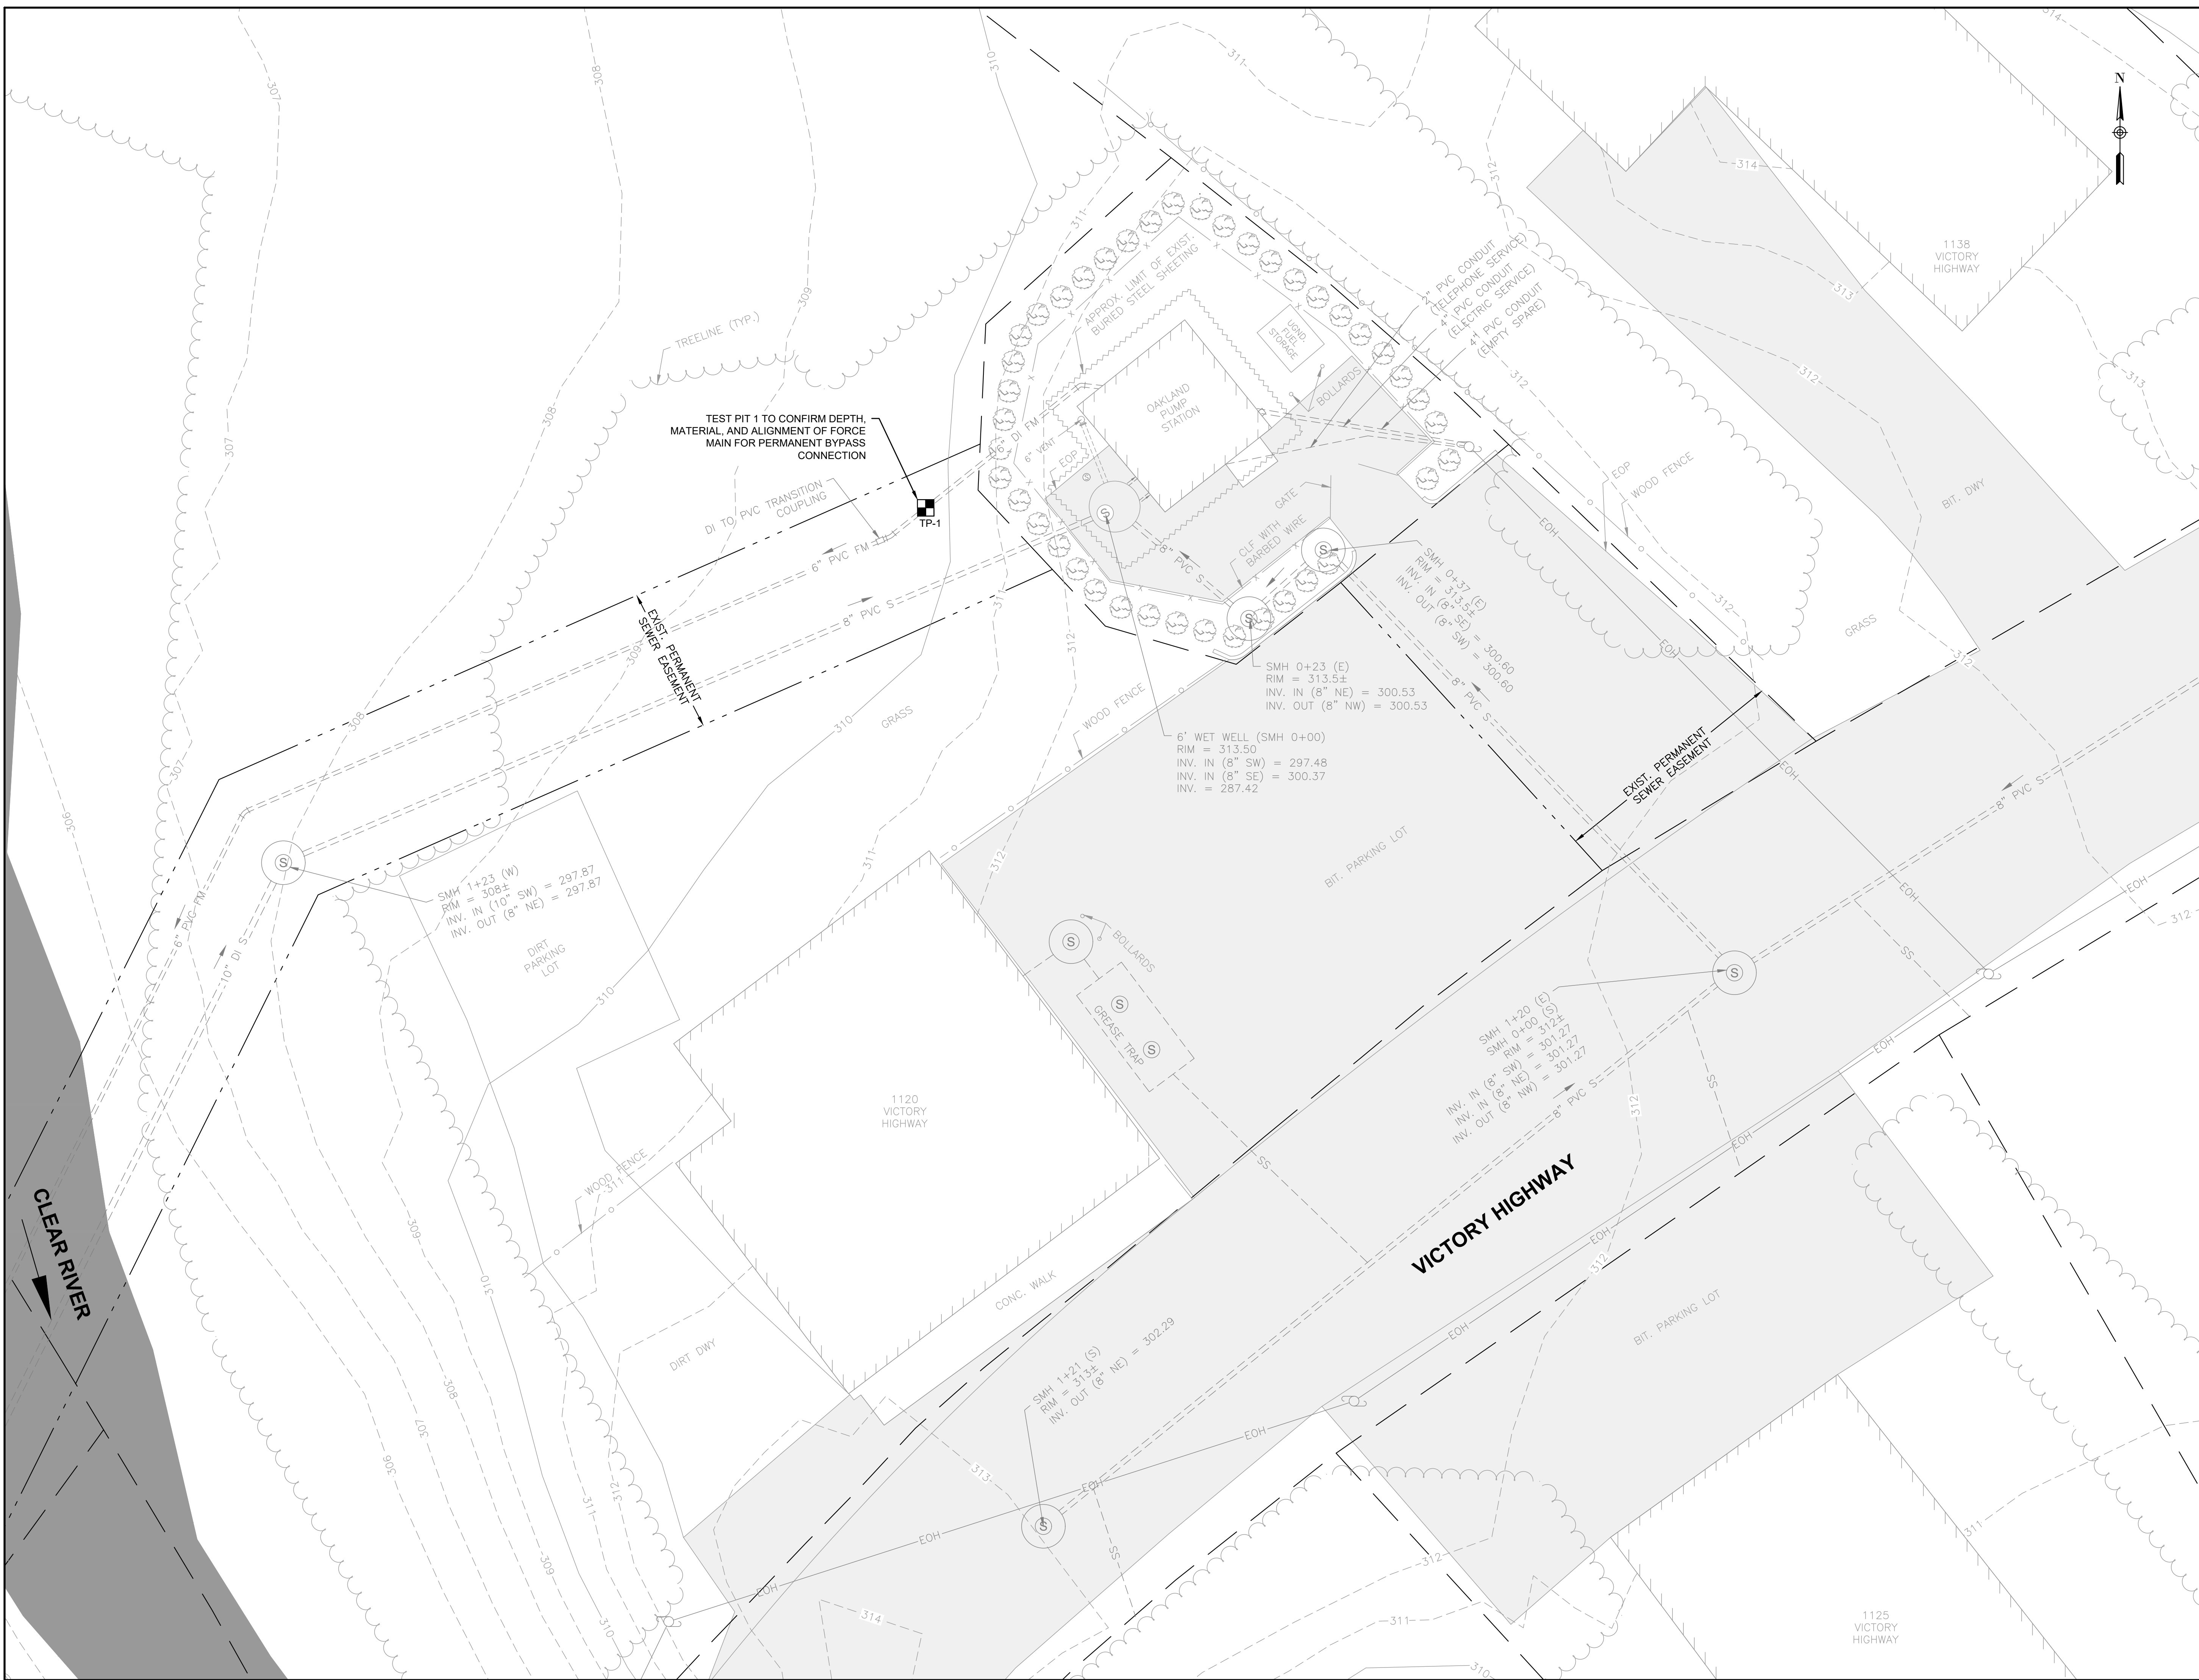BURRILLVILLE, RI

TITLE

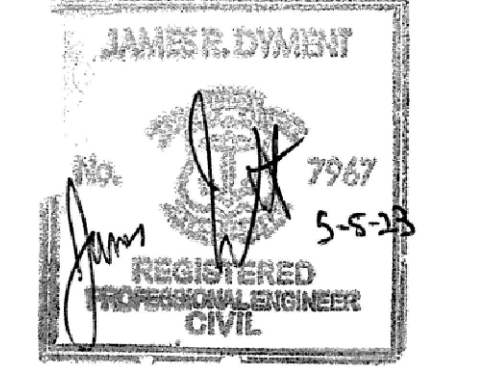OAKLAND PS - EXISTING SITE PLAN

NO.	REVISIONS	DATE

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
DESIGNED BY: AJG

CHECKED BY: JRD

ISSUE DATE: MAY 2023

BETA JOB NO.: 6861-105

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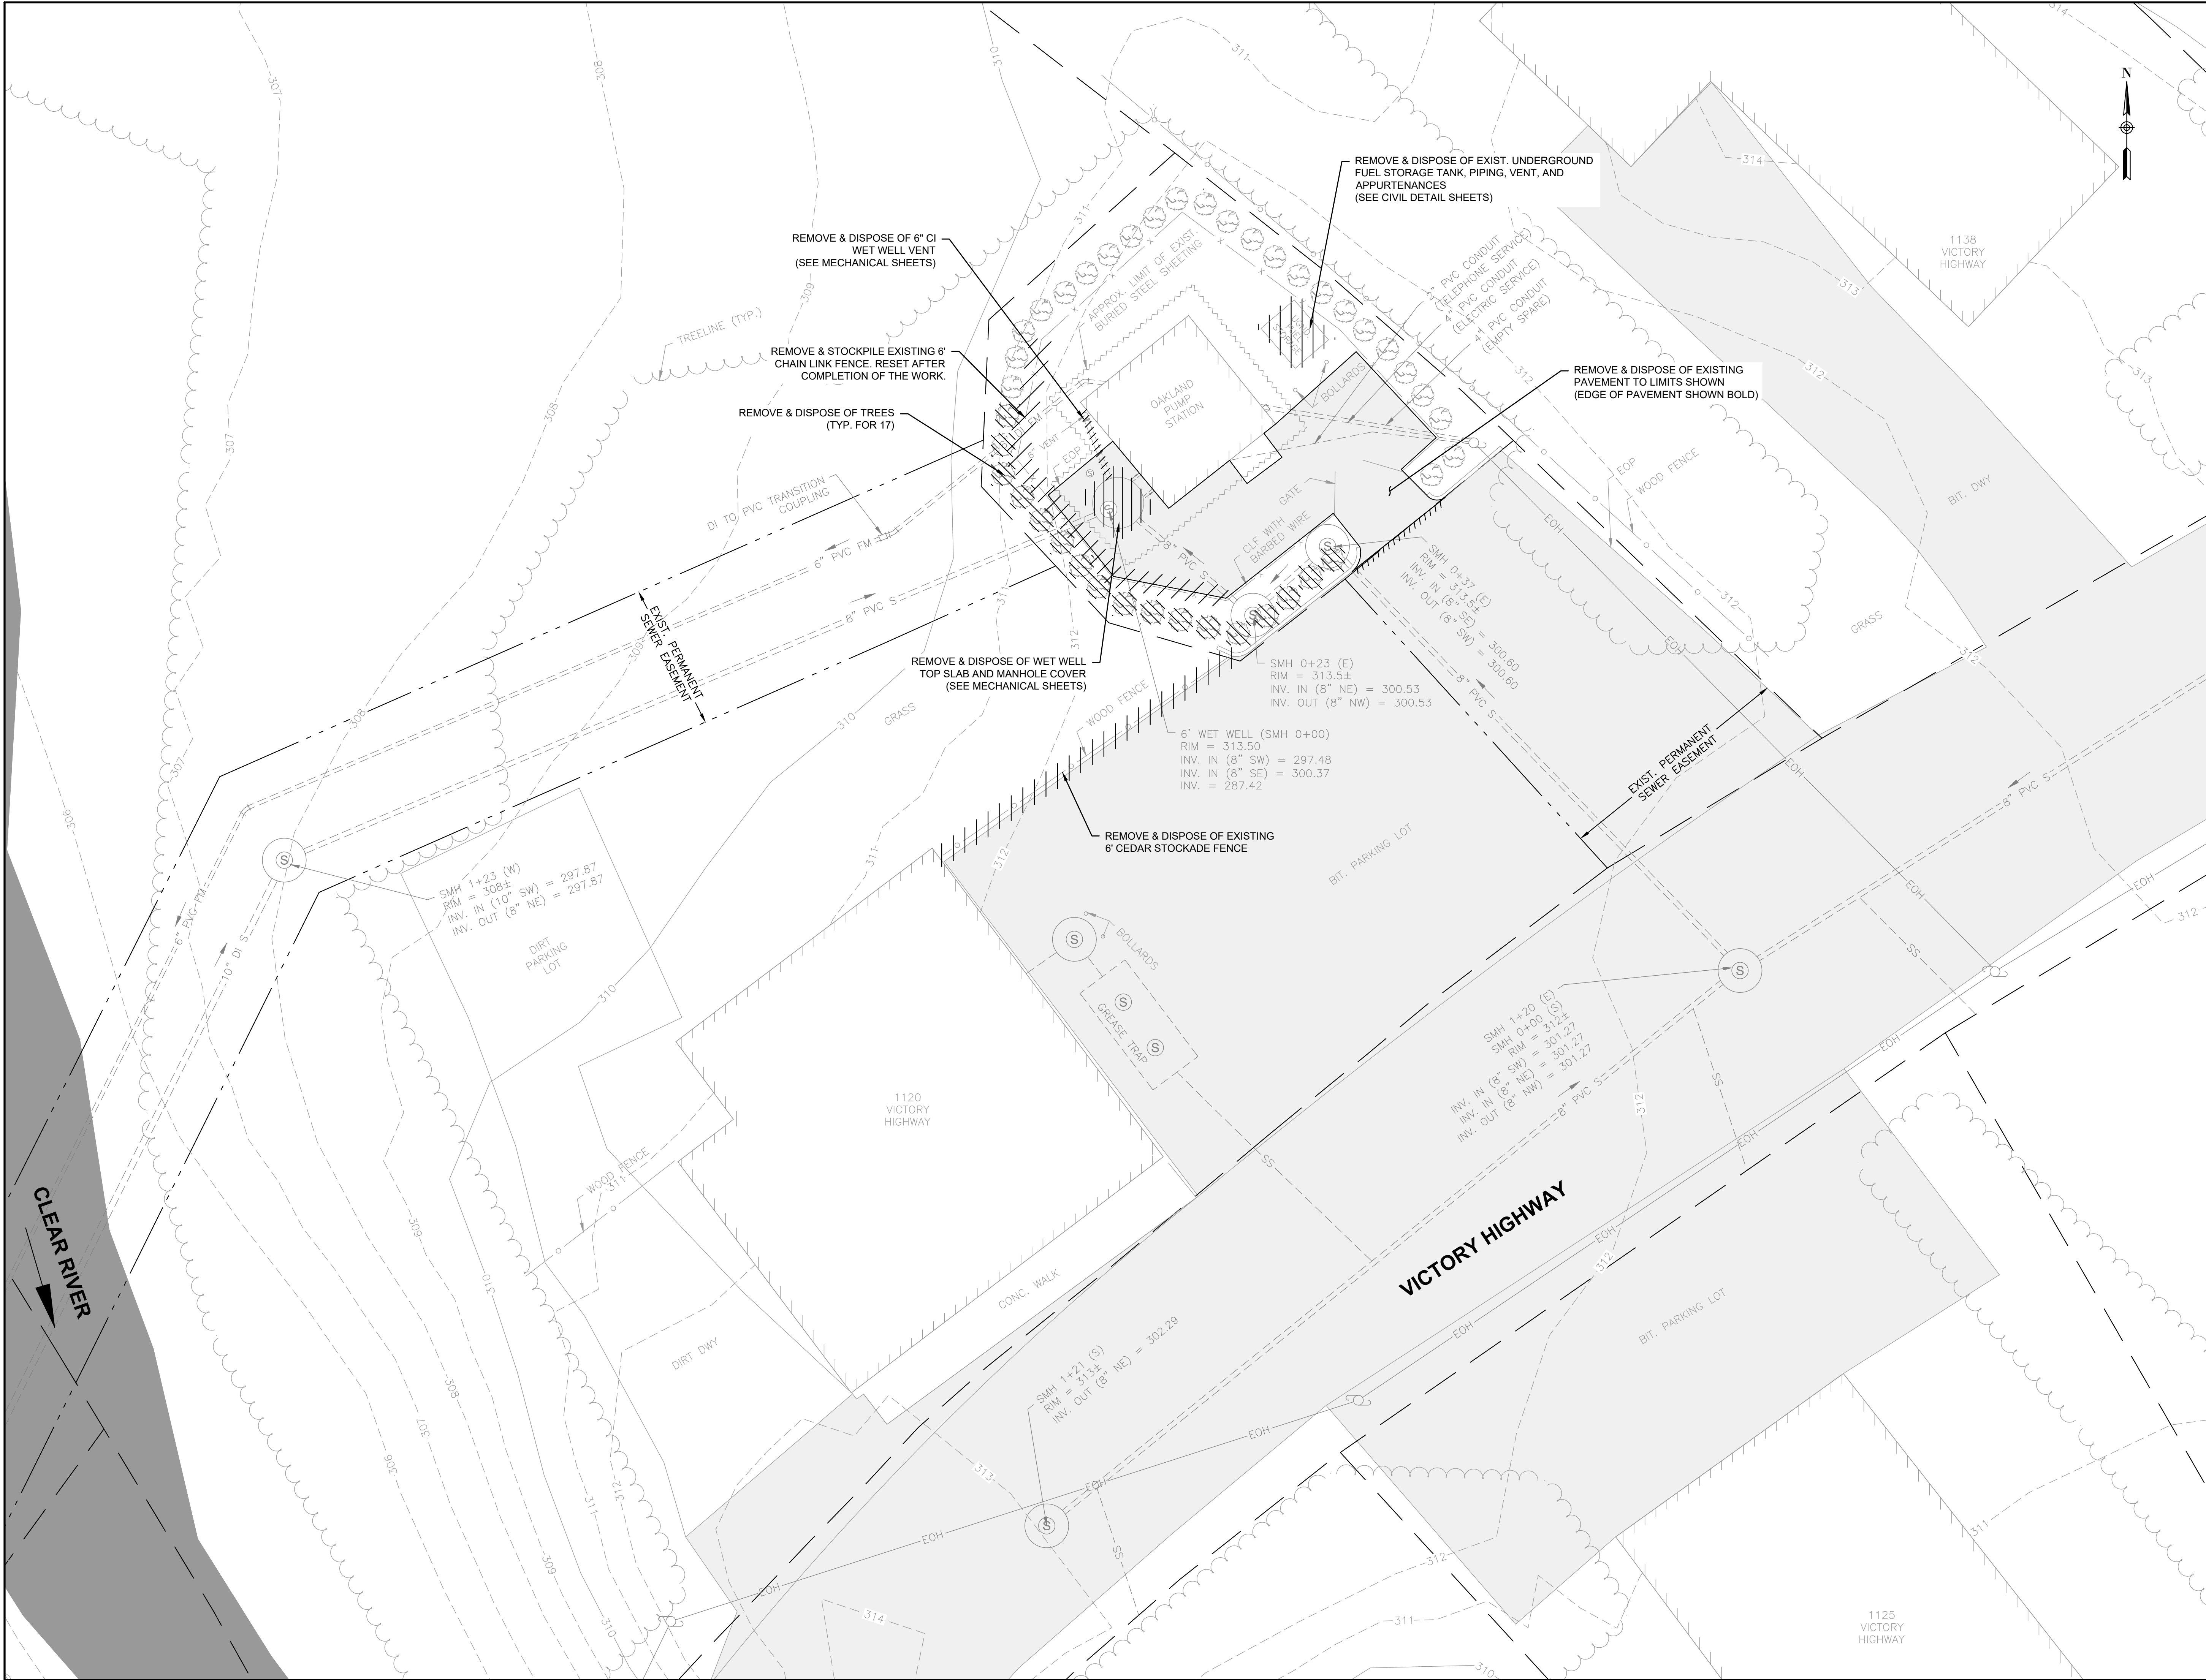
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5/16/2023



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CIVIL

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PROJECT
**BURRILLVILLE WWTF
HEADWORKS &
OAKLAND PUMP
STATION
IMPROVEMENTS**
BURRILLVILLE, RI




TITLE
**OAKLAND PS -
DEMOLITION
SITE PLAN**

NO.	REVISIONS	DATE

DRAWN BY: CJM
DESIGNED BY: AJG
CHECKED BY: JRD
ISSUE DATE: MAY 2023
BETA JOB NO.: 6861-105

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SCALE IN FEET: 1"=10'

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- BYPASS NOTES:**
- VOLUME OF EXISTING 6" FORCE MAIN IS APPROXIMATELY 2,200 GALLONS.
 - GRAVITY SANITARY SEWER PIPING AND FITTINGS SHALL BE EPOXY COATED WITH PROTECTO 401 BY INDURALL.

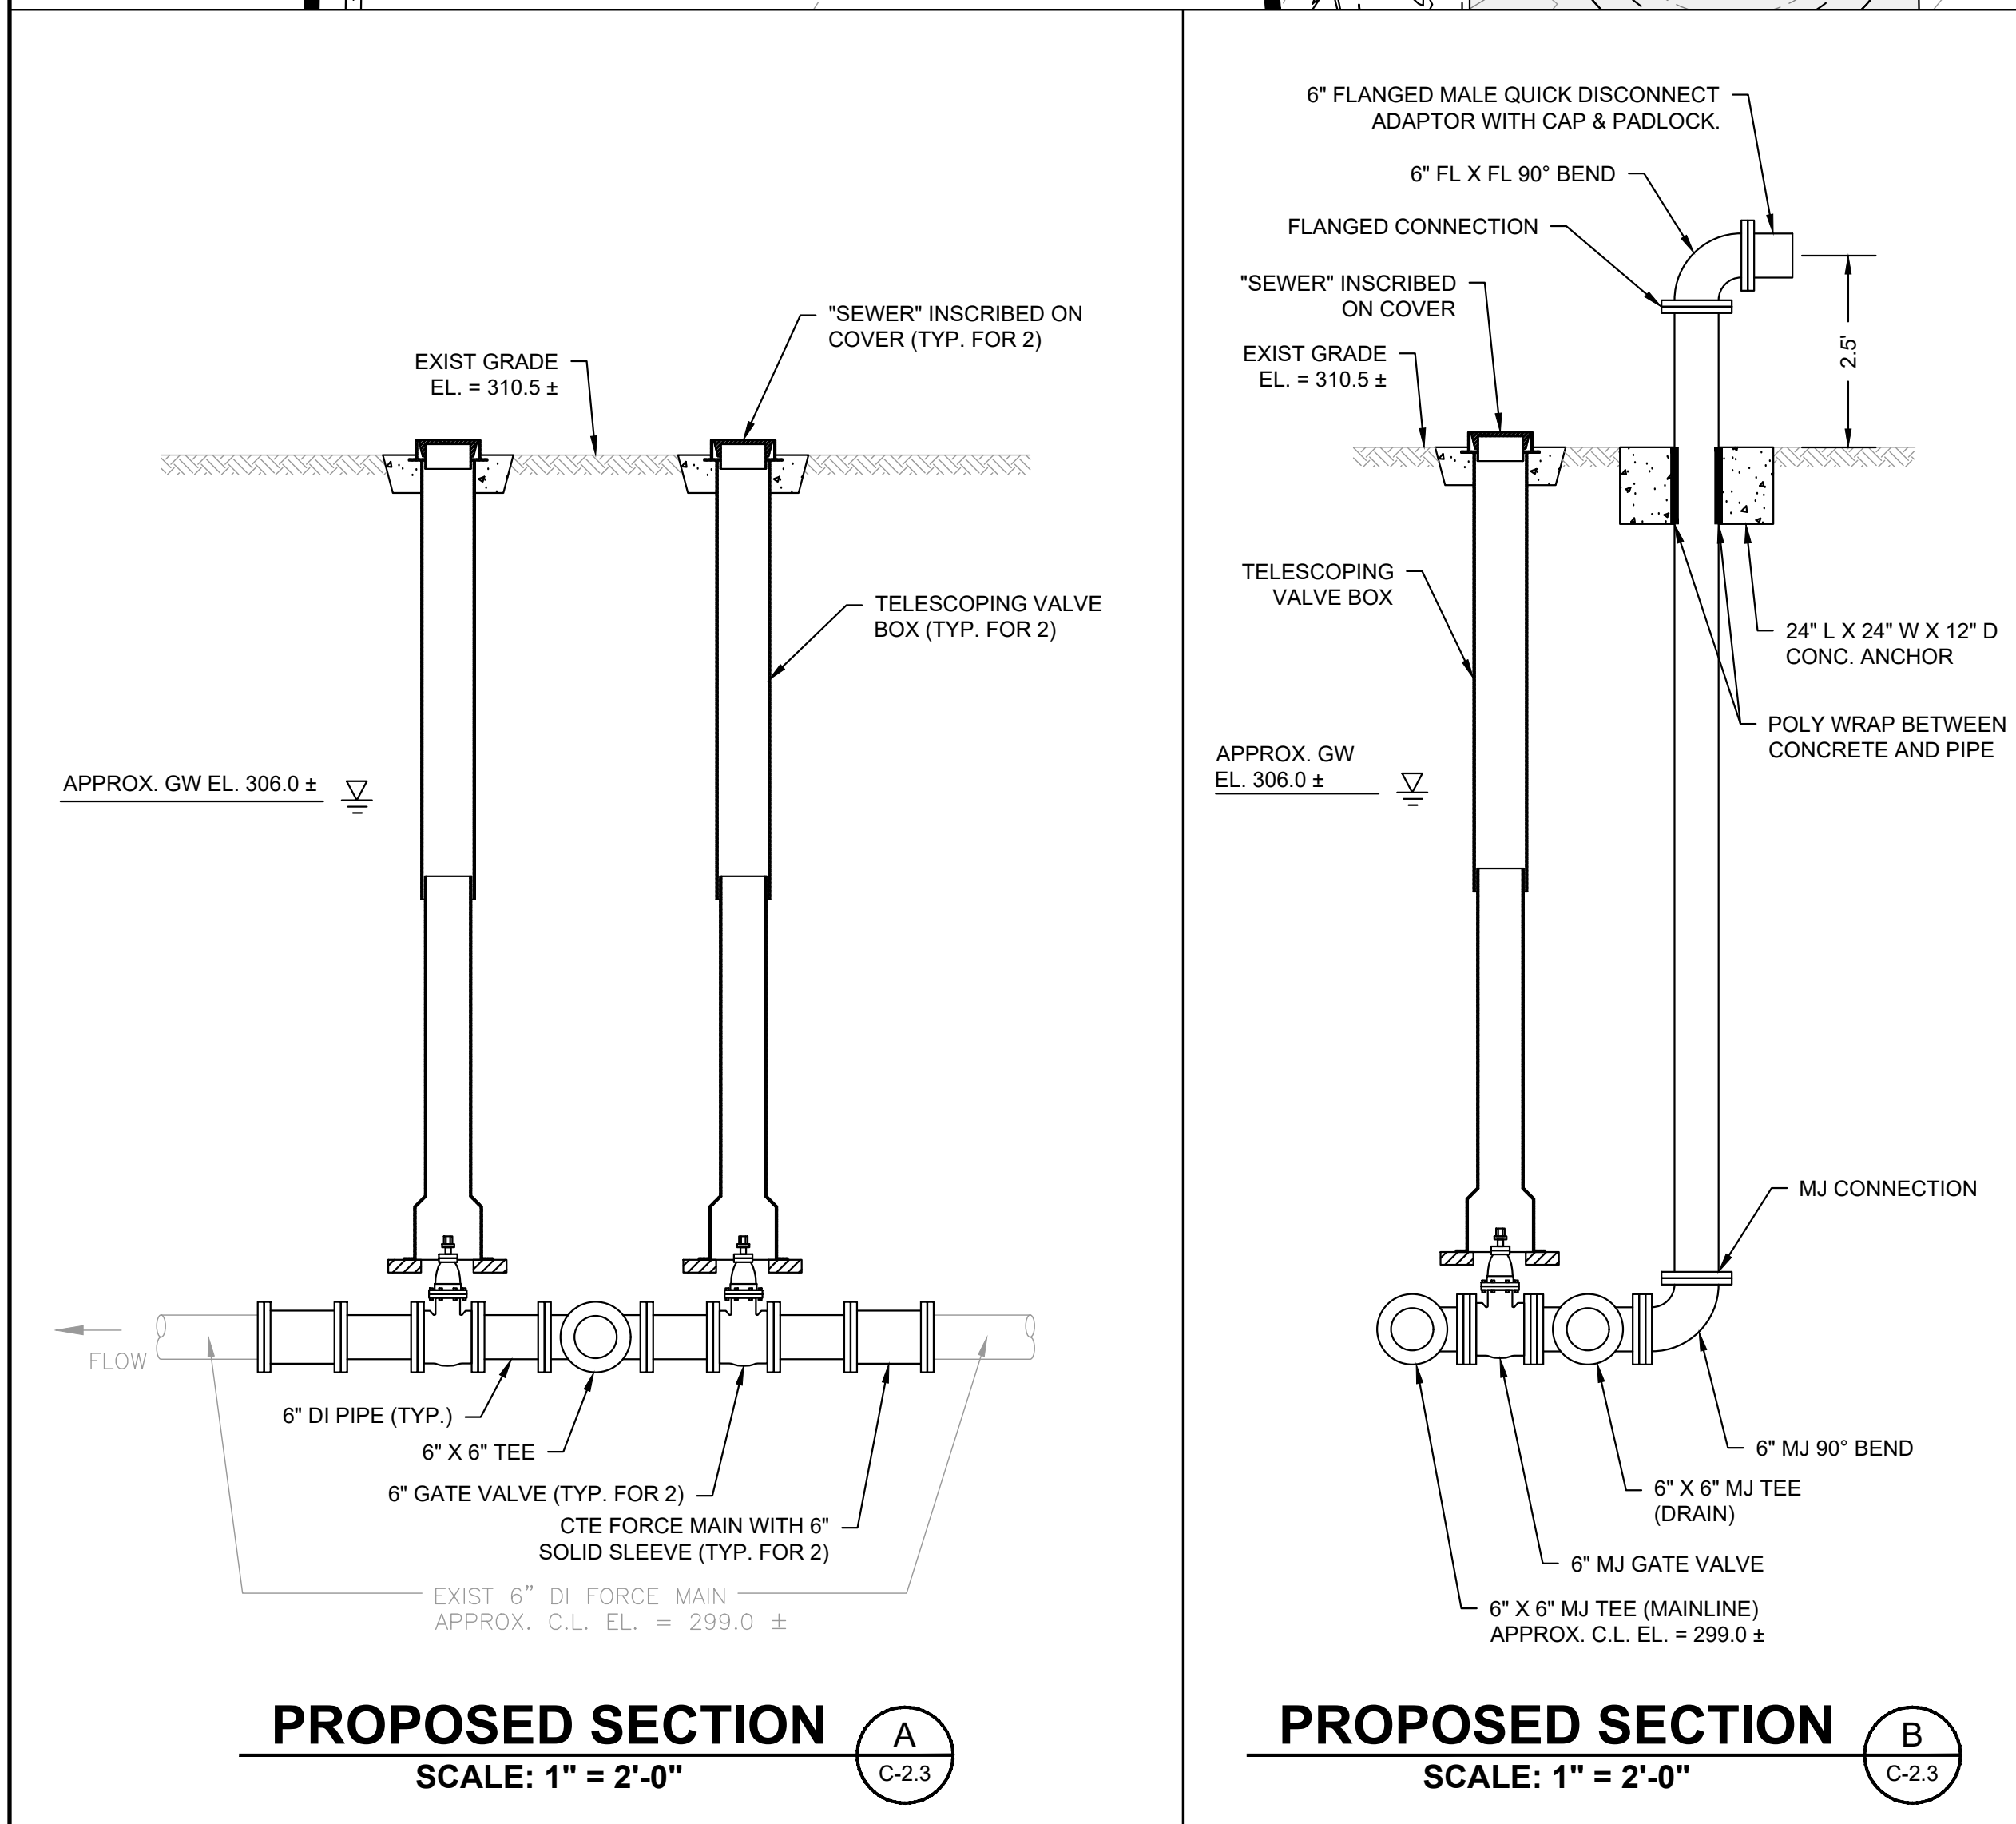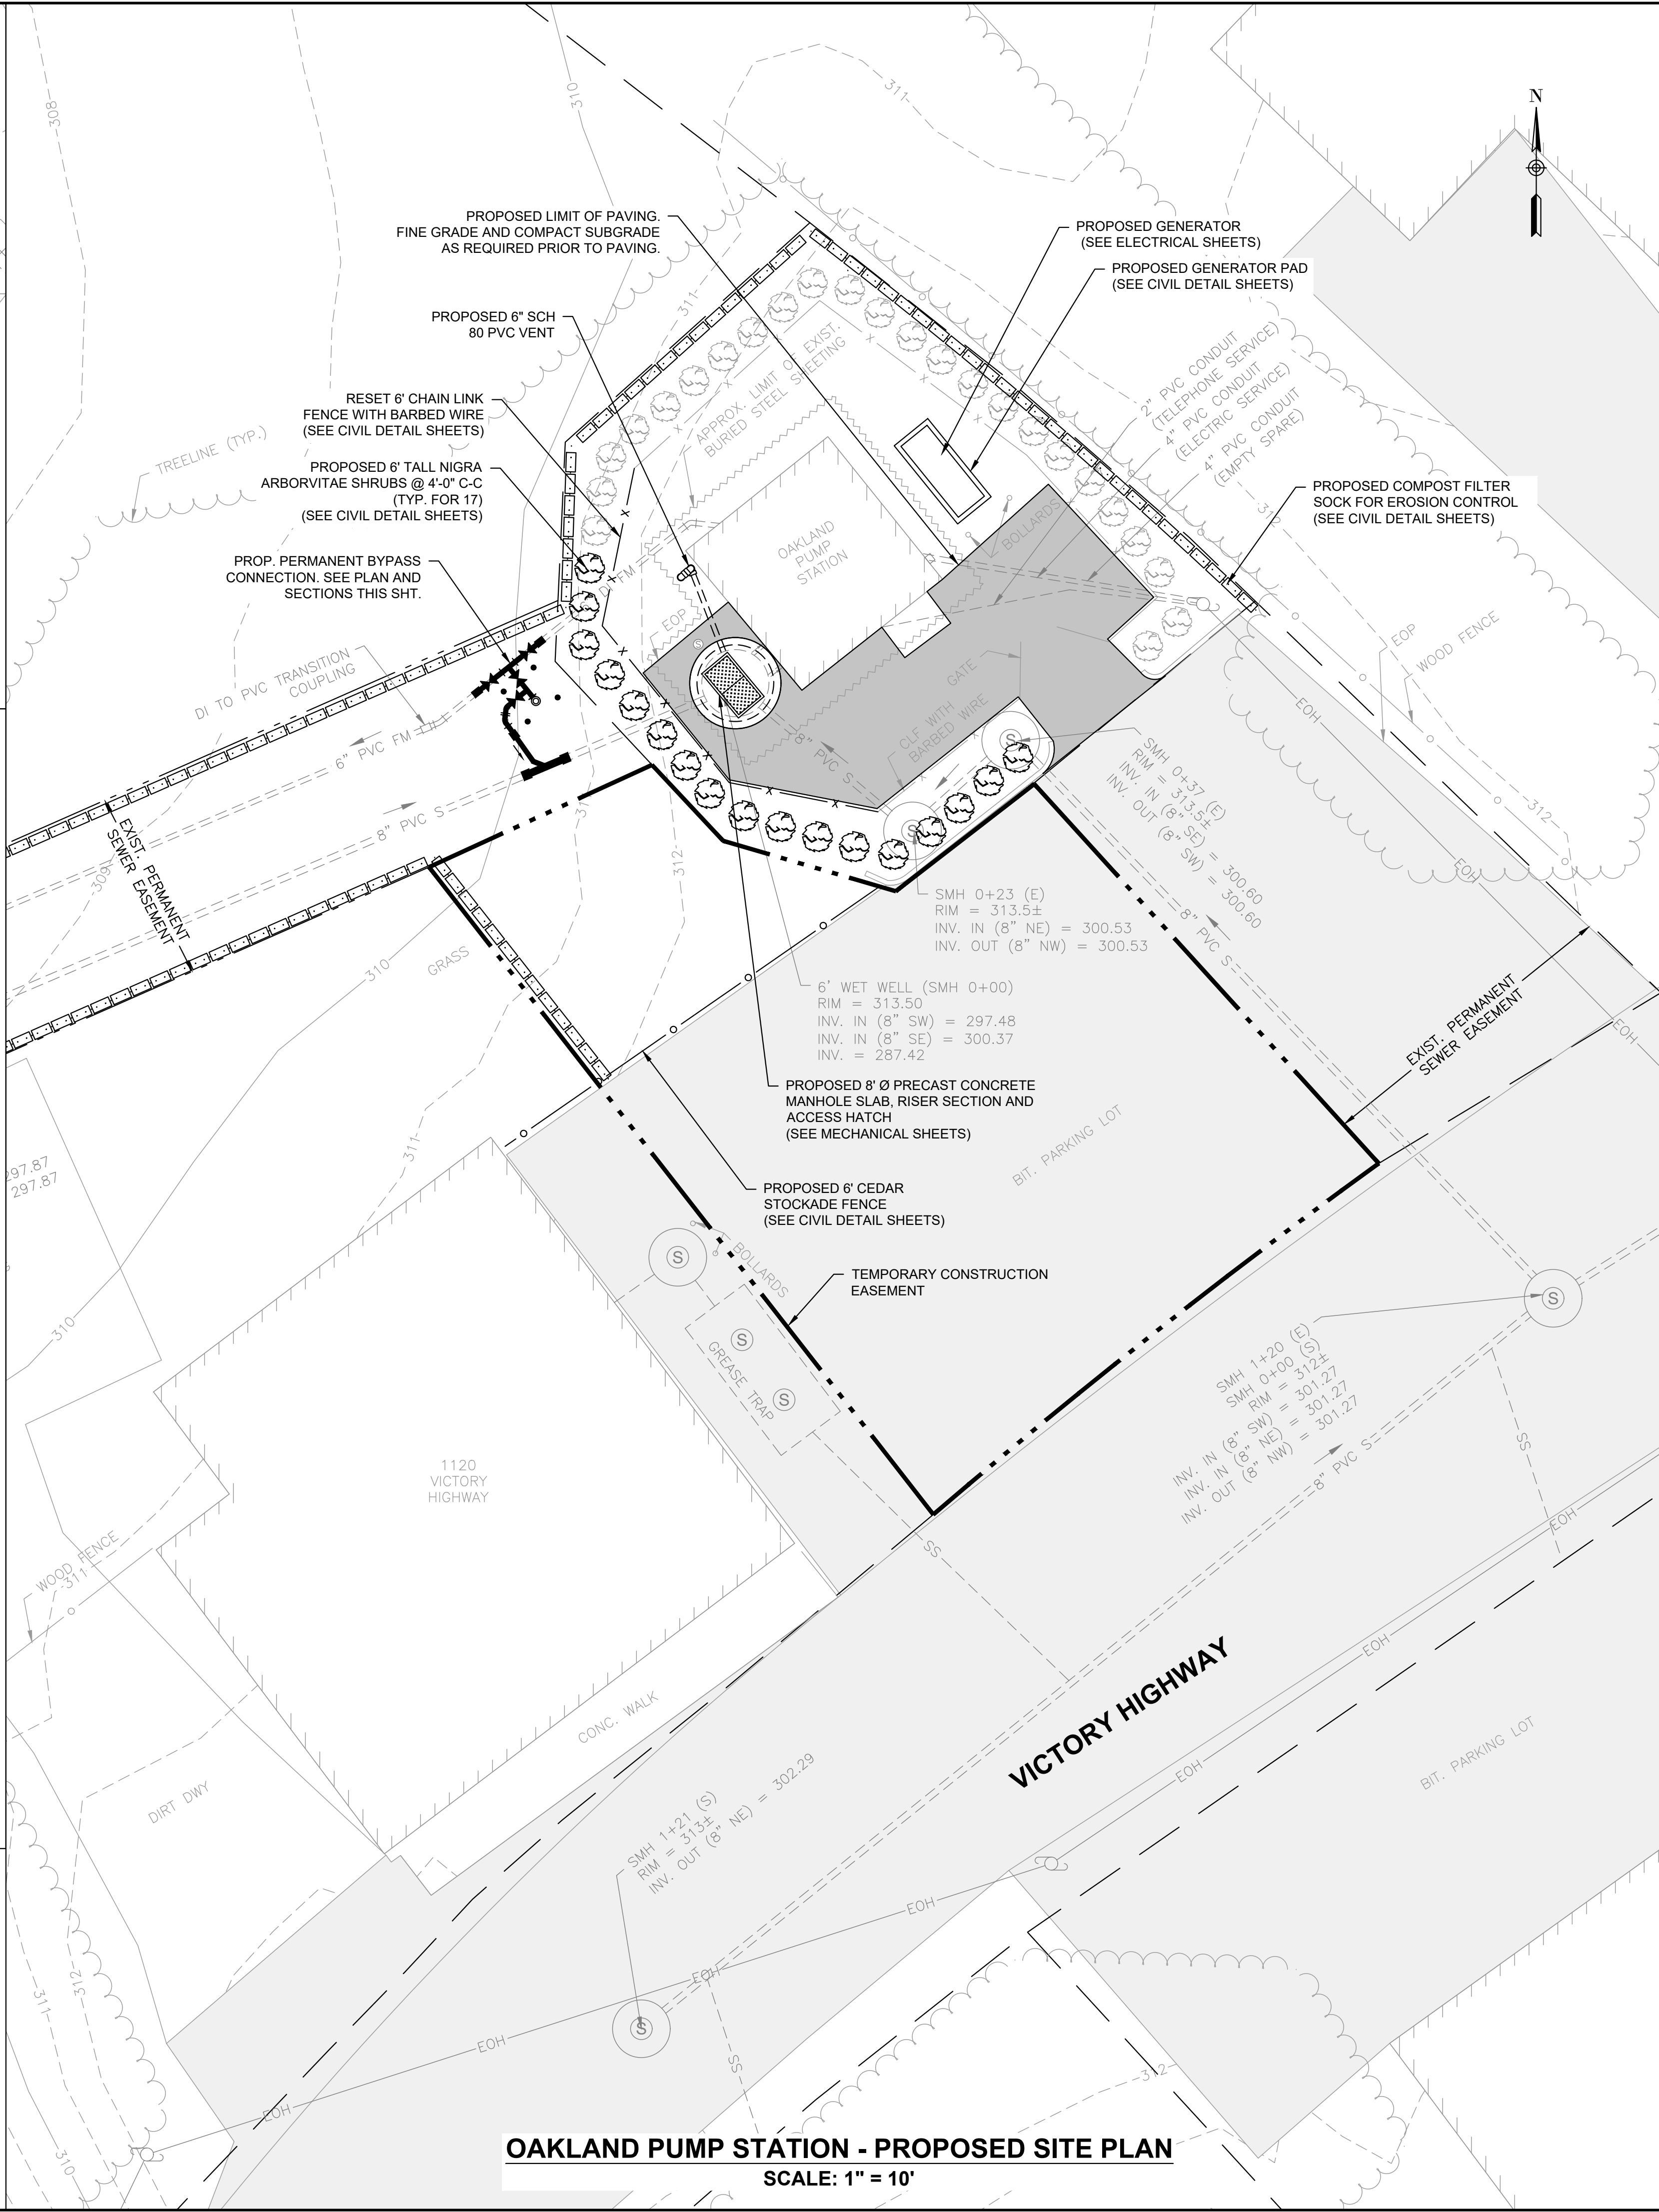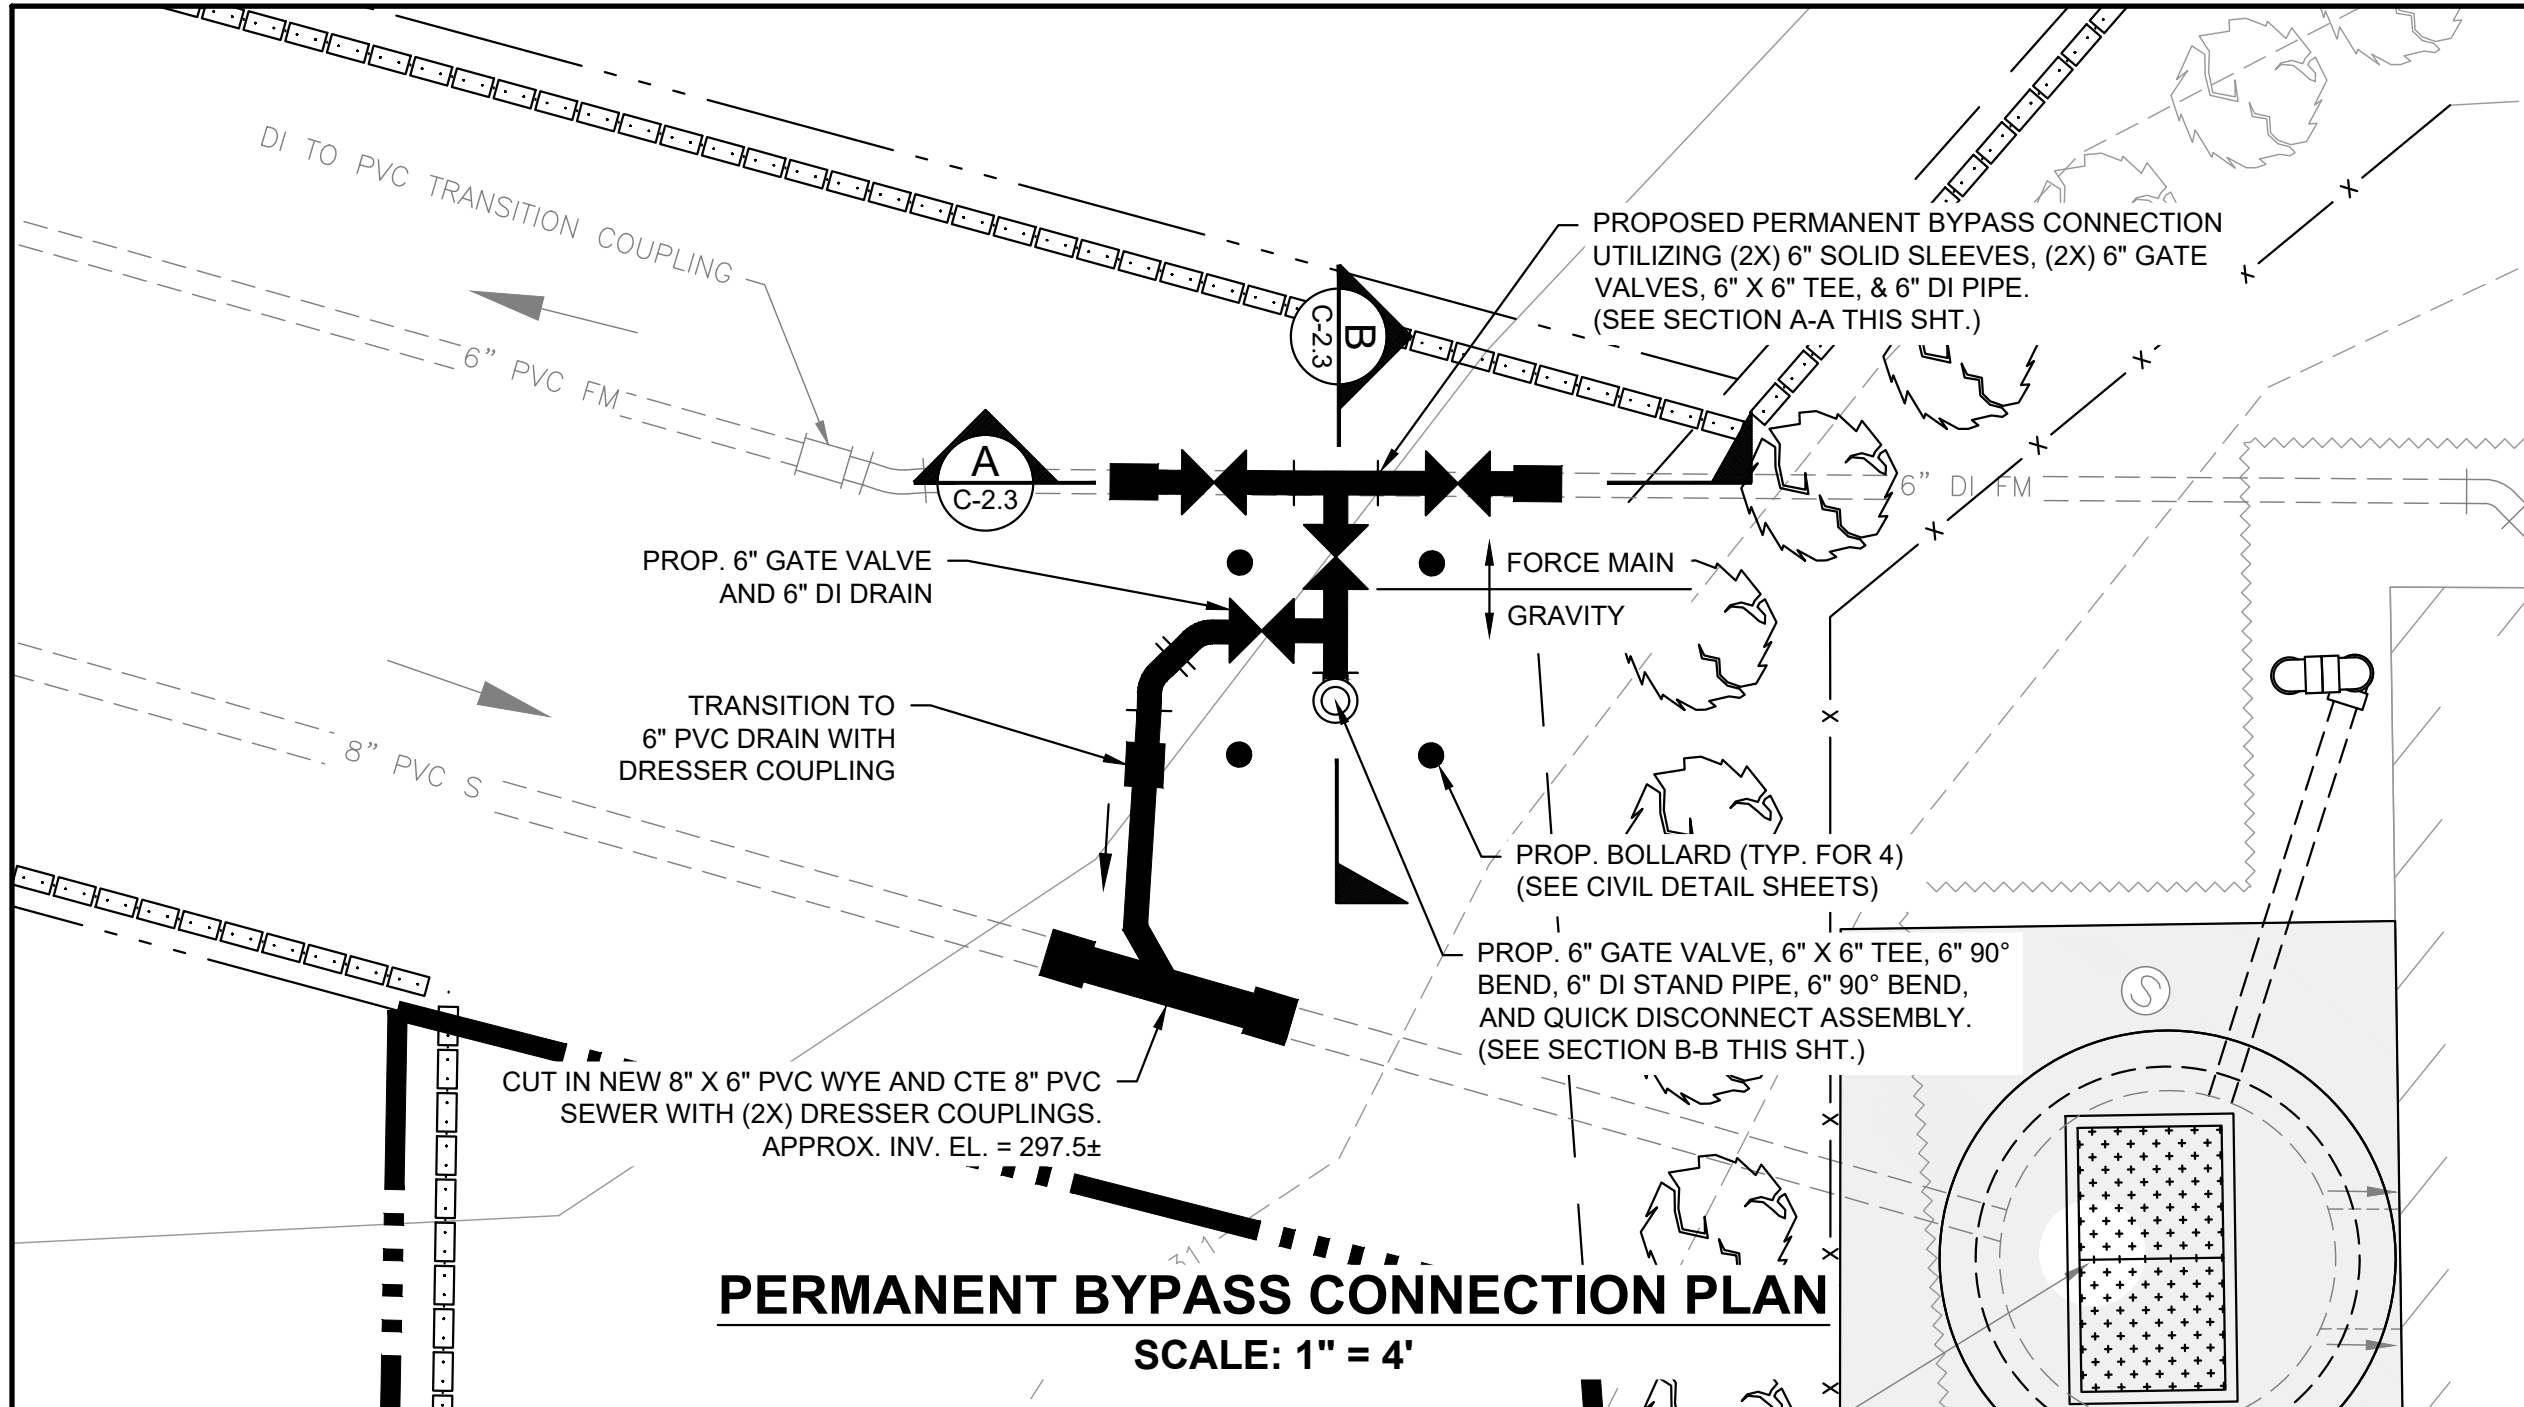PREPARED BY
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PROJECT
BURRILLVILLE WWTF HEADWORKS & OAKLAND PUMP STATION IMPROVEMENTS
BURRILLVILLE, RI

TITLE
OAKLAND PS - PROPOSED SITE PLAN


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BETA JOB NO.: 6861-105


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SCALE IN FEET: 1"=10'

UNLESS OTHERWISE NOTED OR CHANGED BY REPRODUCTION
For Review Only


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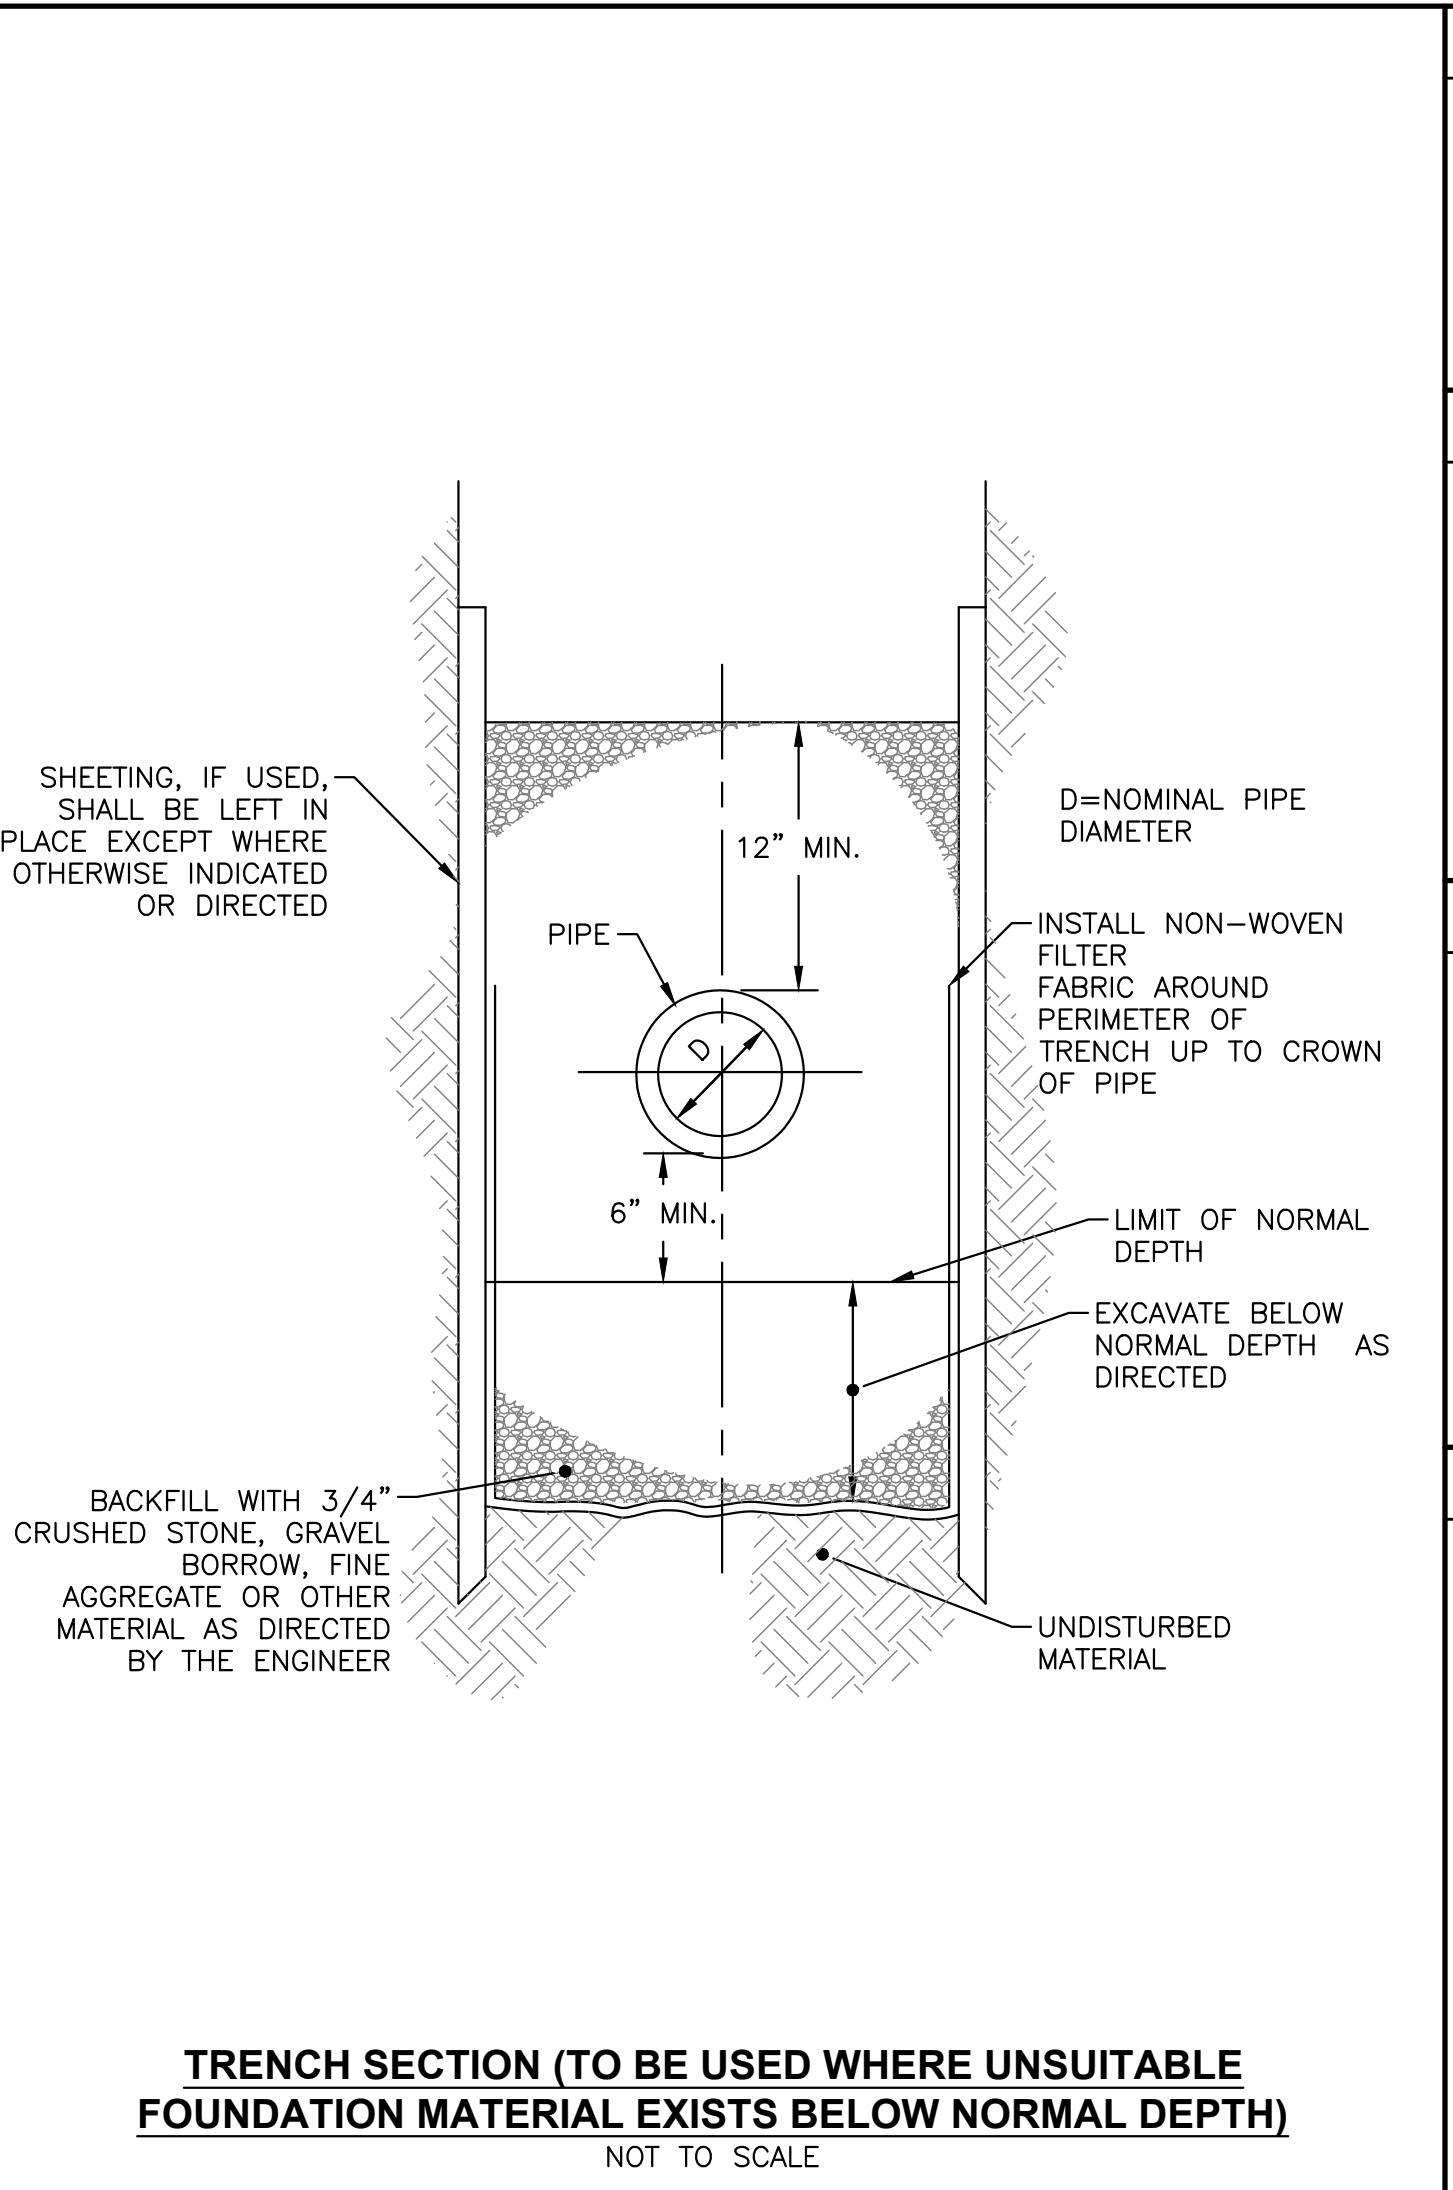
WOOD FENCE DETAIL
NOT TO SCALE

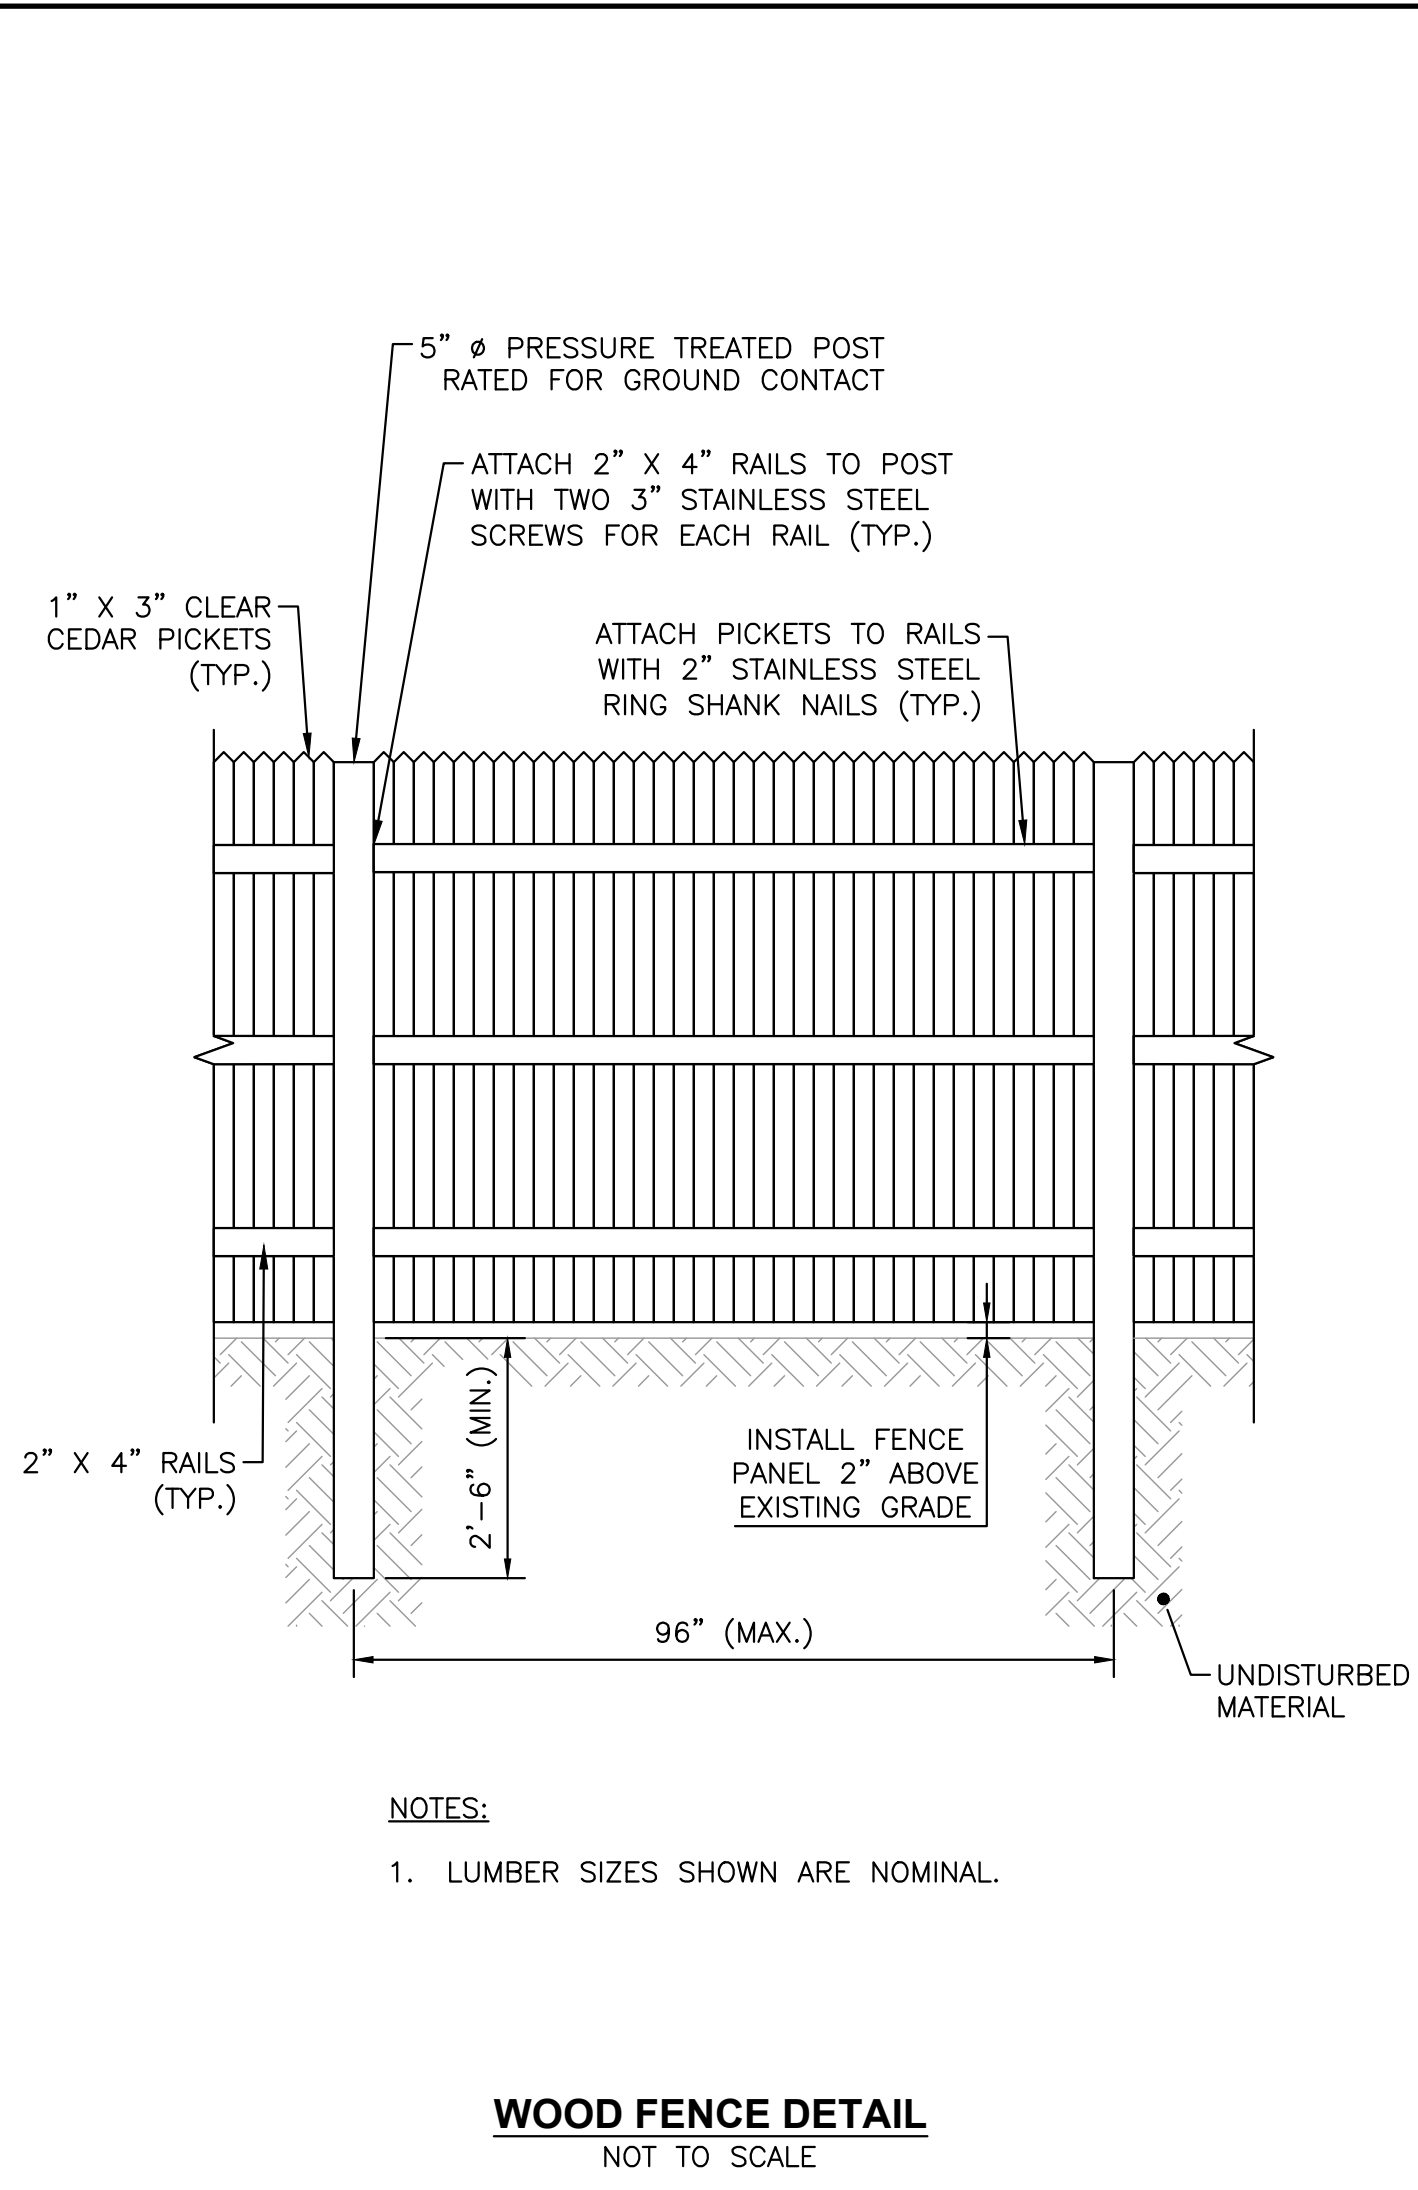


FORCE MAIN TRENCH SECTION
NOT TO SCALE

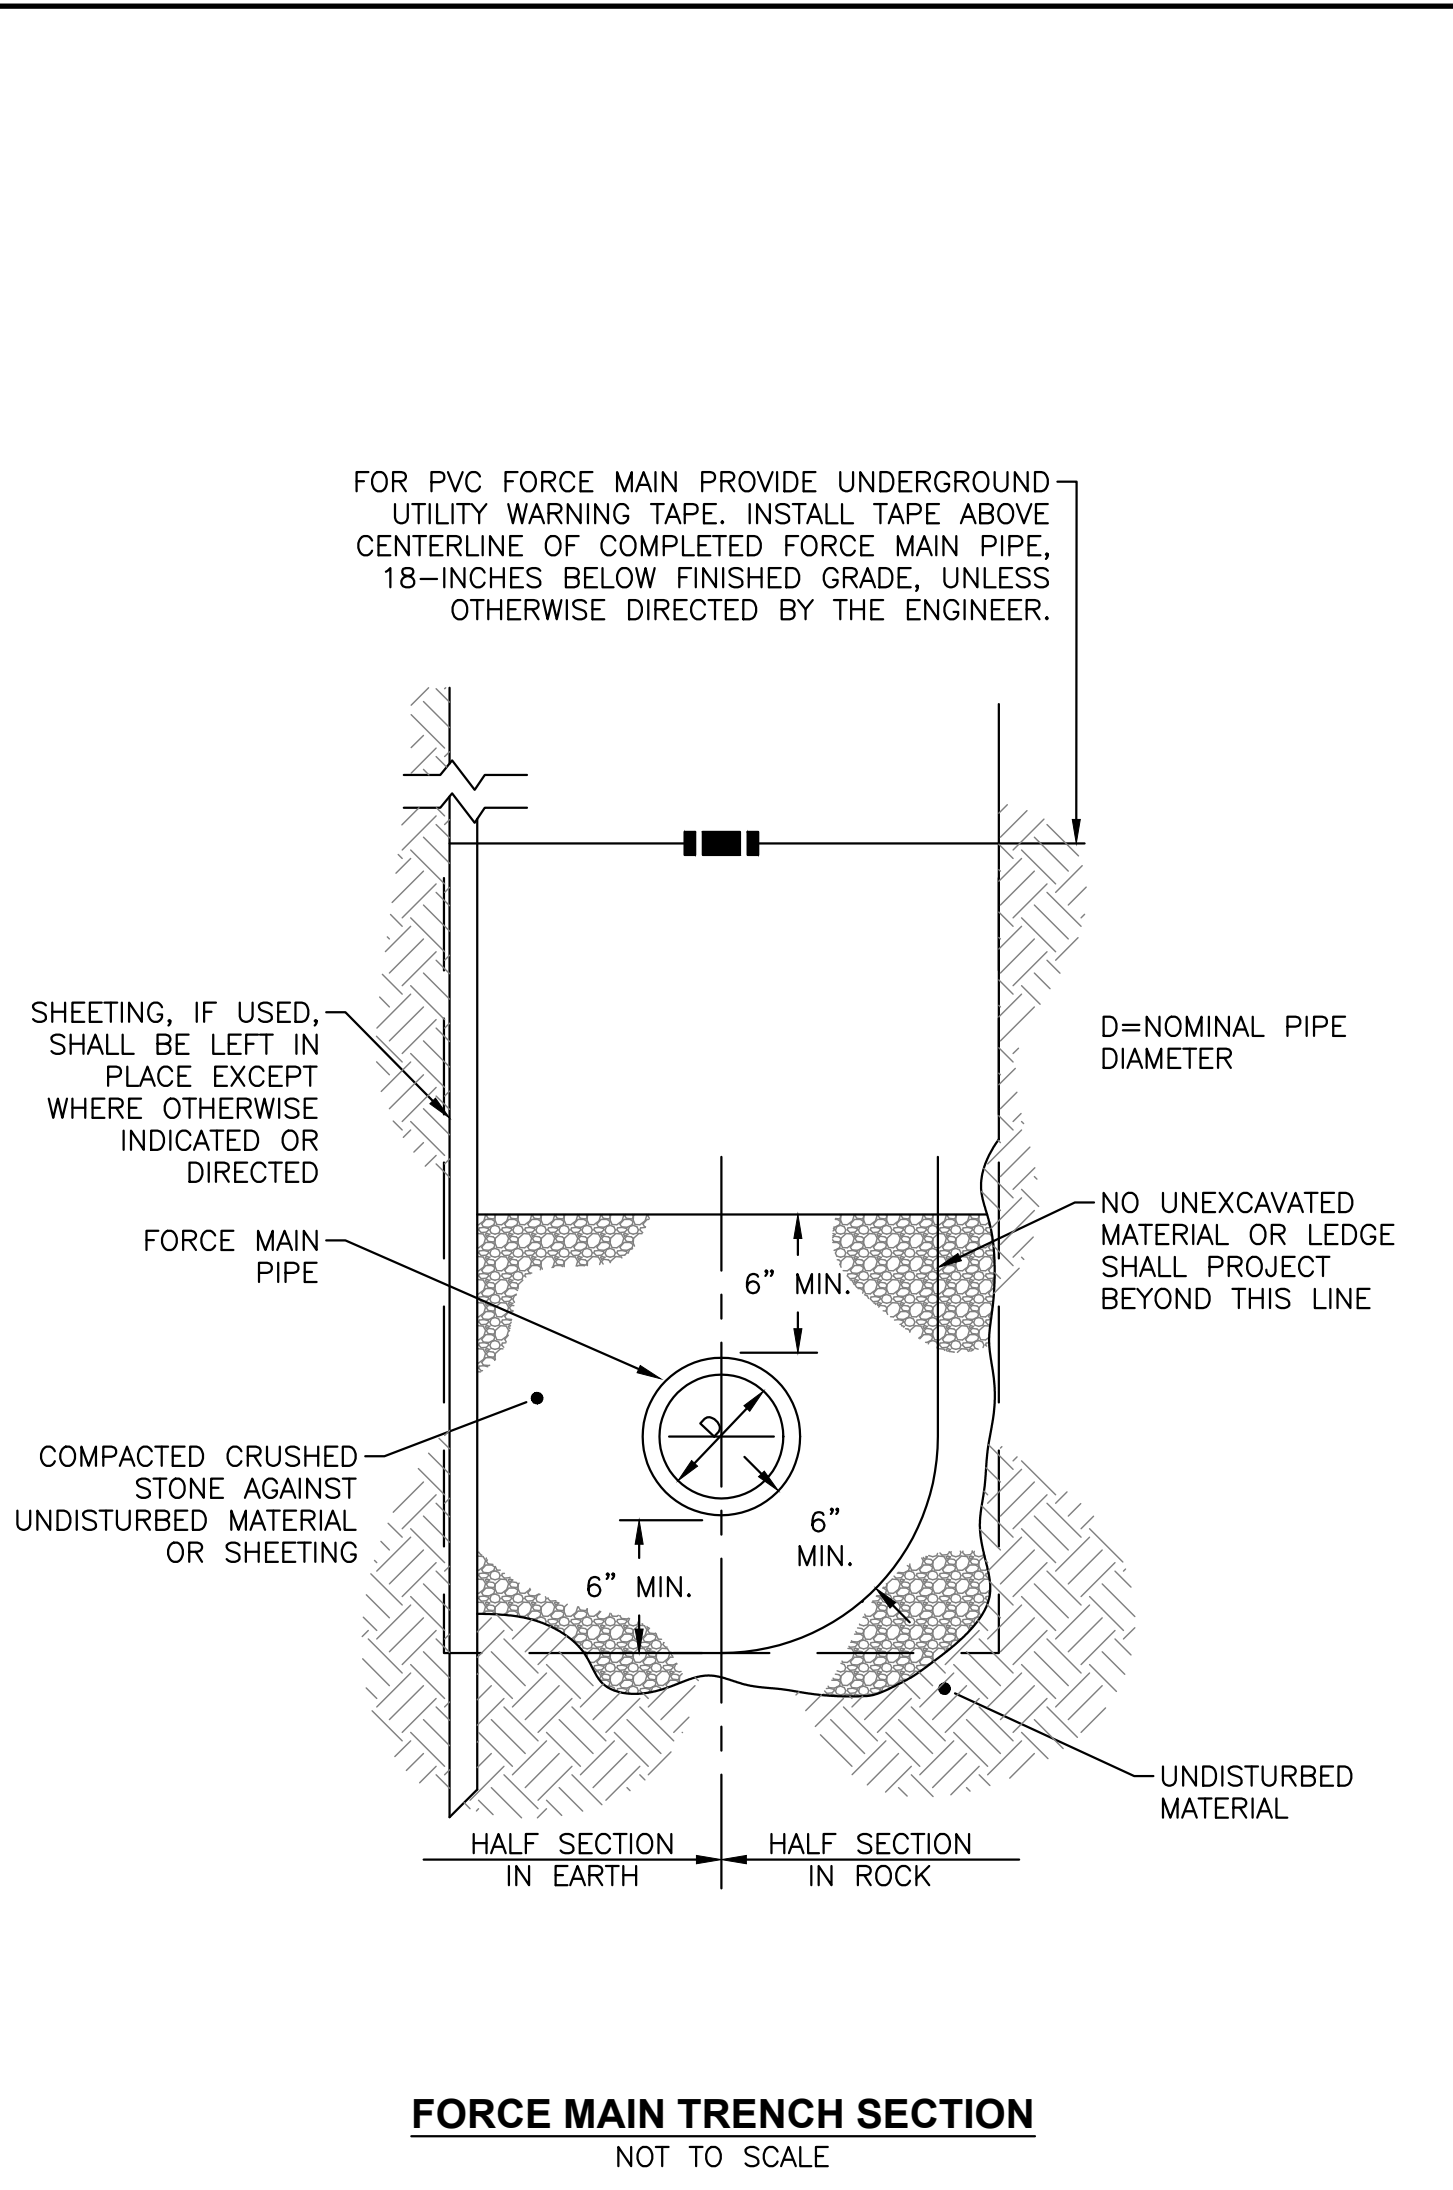


GRAVITY SEWER TRENCH SECTION FOR 4" DIA. OR GREATER PVC PIPE
NOT TO SCALE

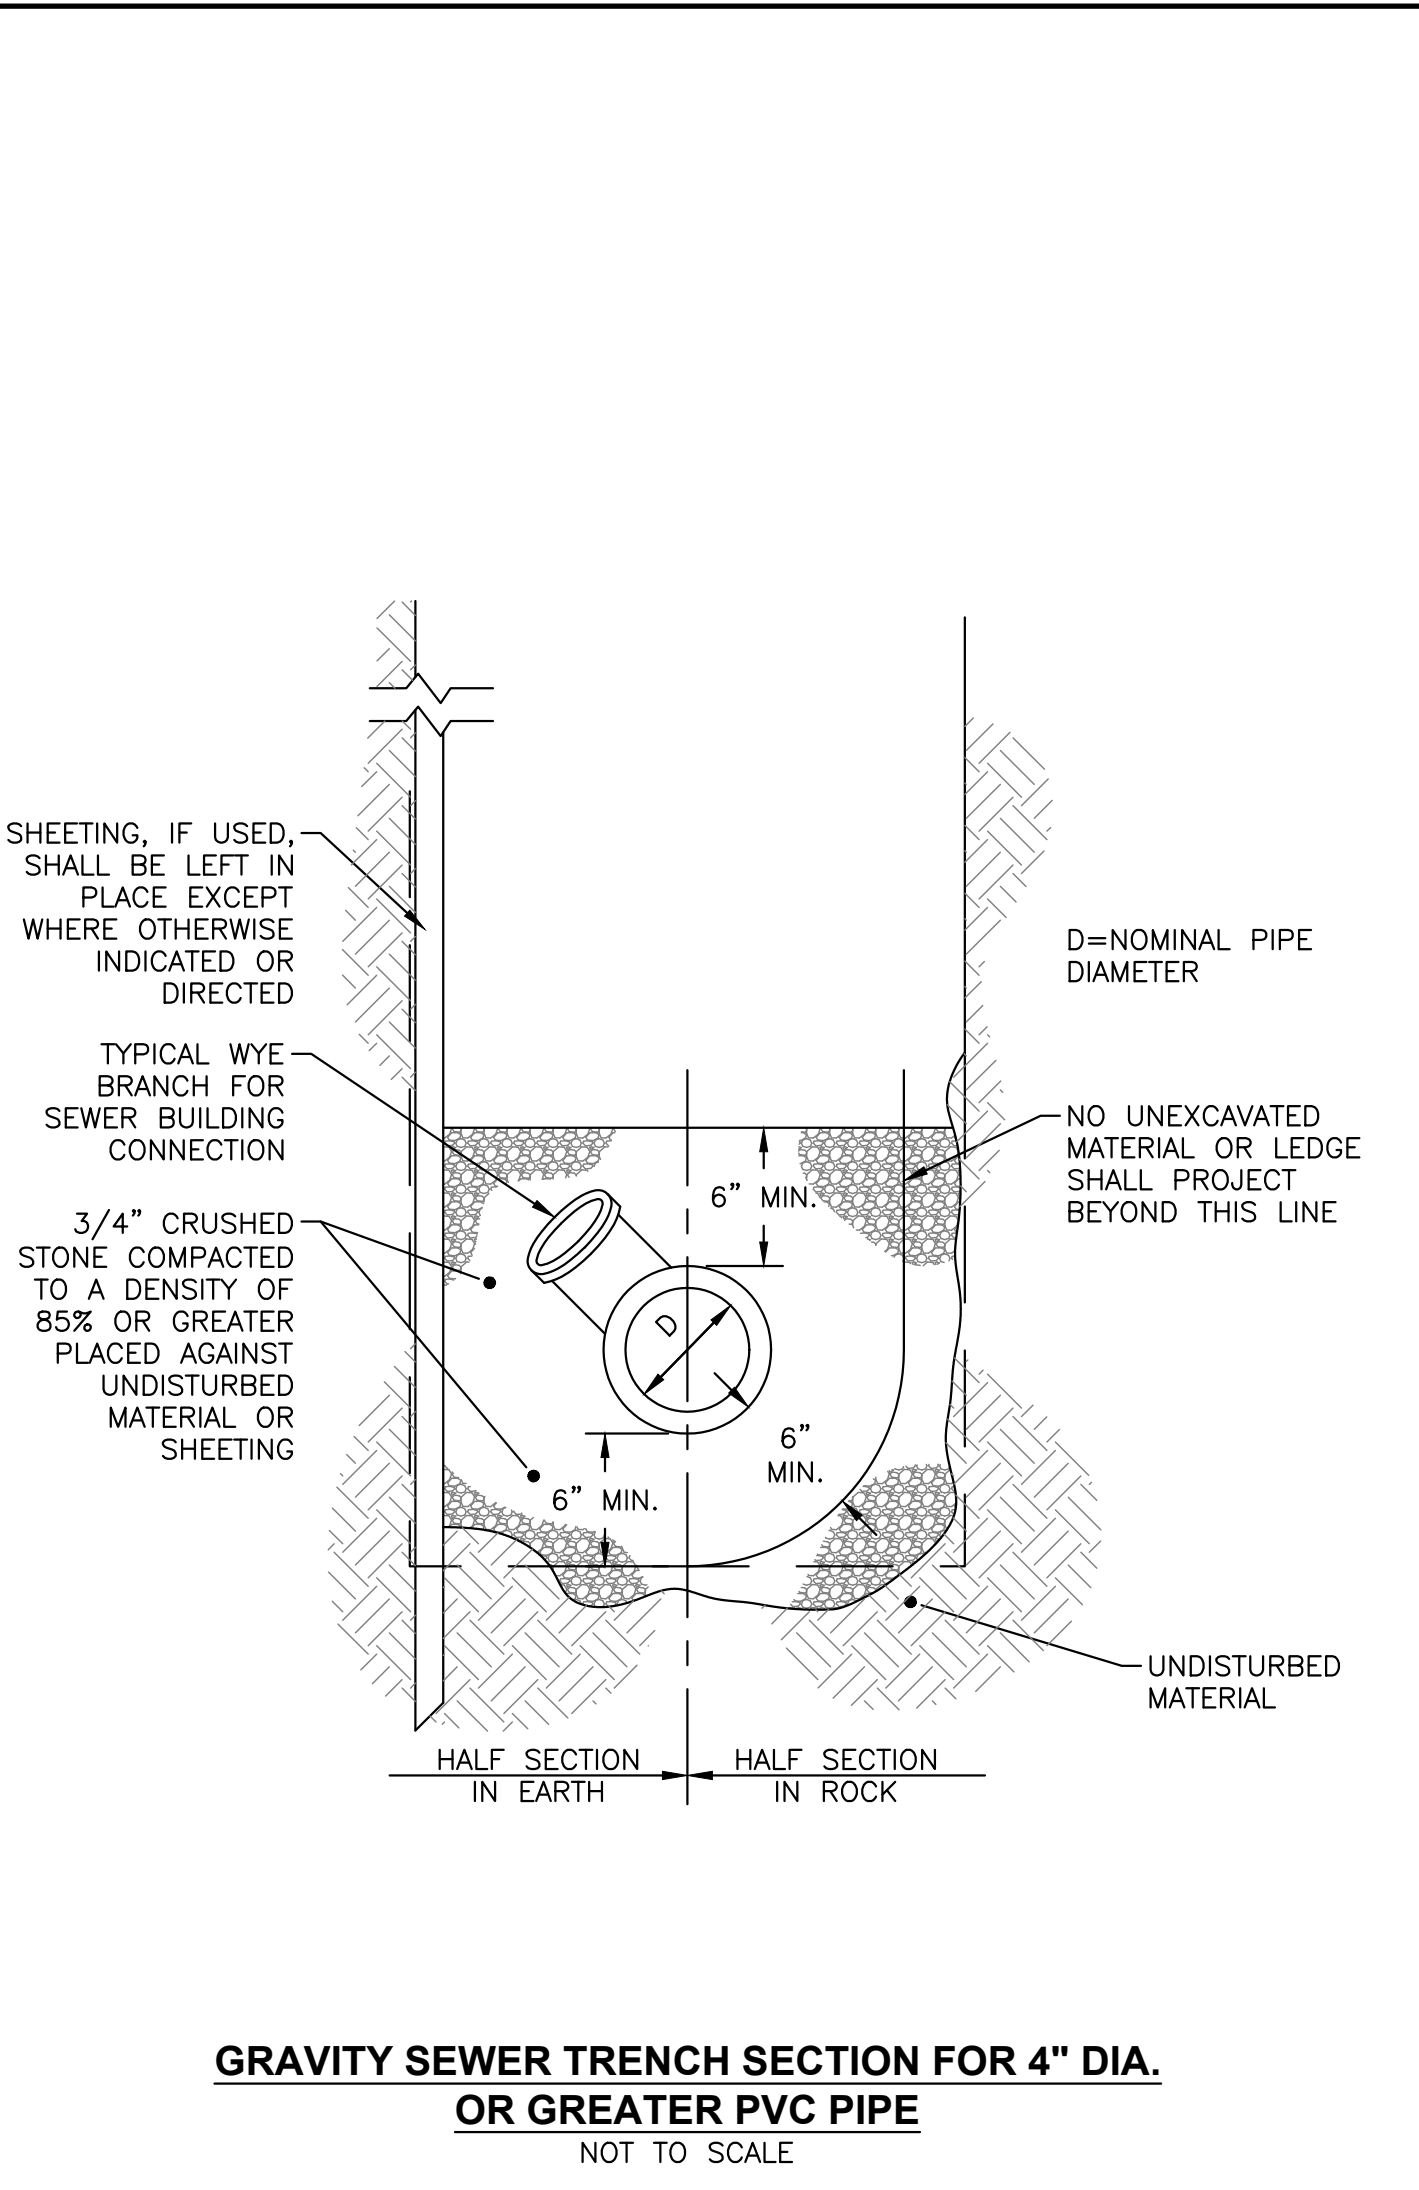

TRENCH SECTION (TO BE USED WHERE UNSUITABLE FOUNDATION MATERIAL EXISTS BELOW NORMAL DEPTH)
NOT TO SCALE

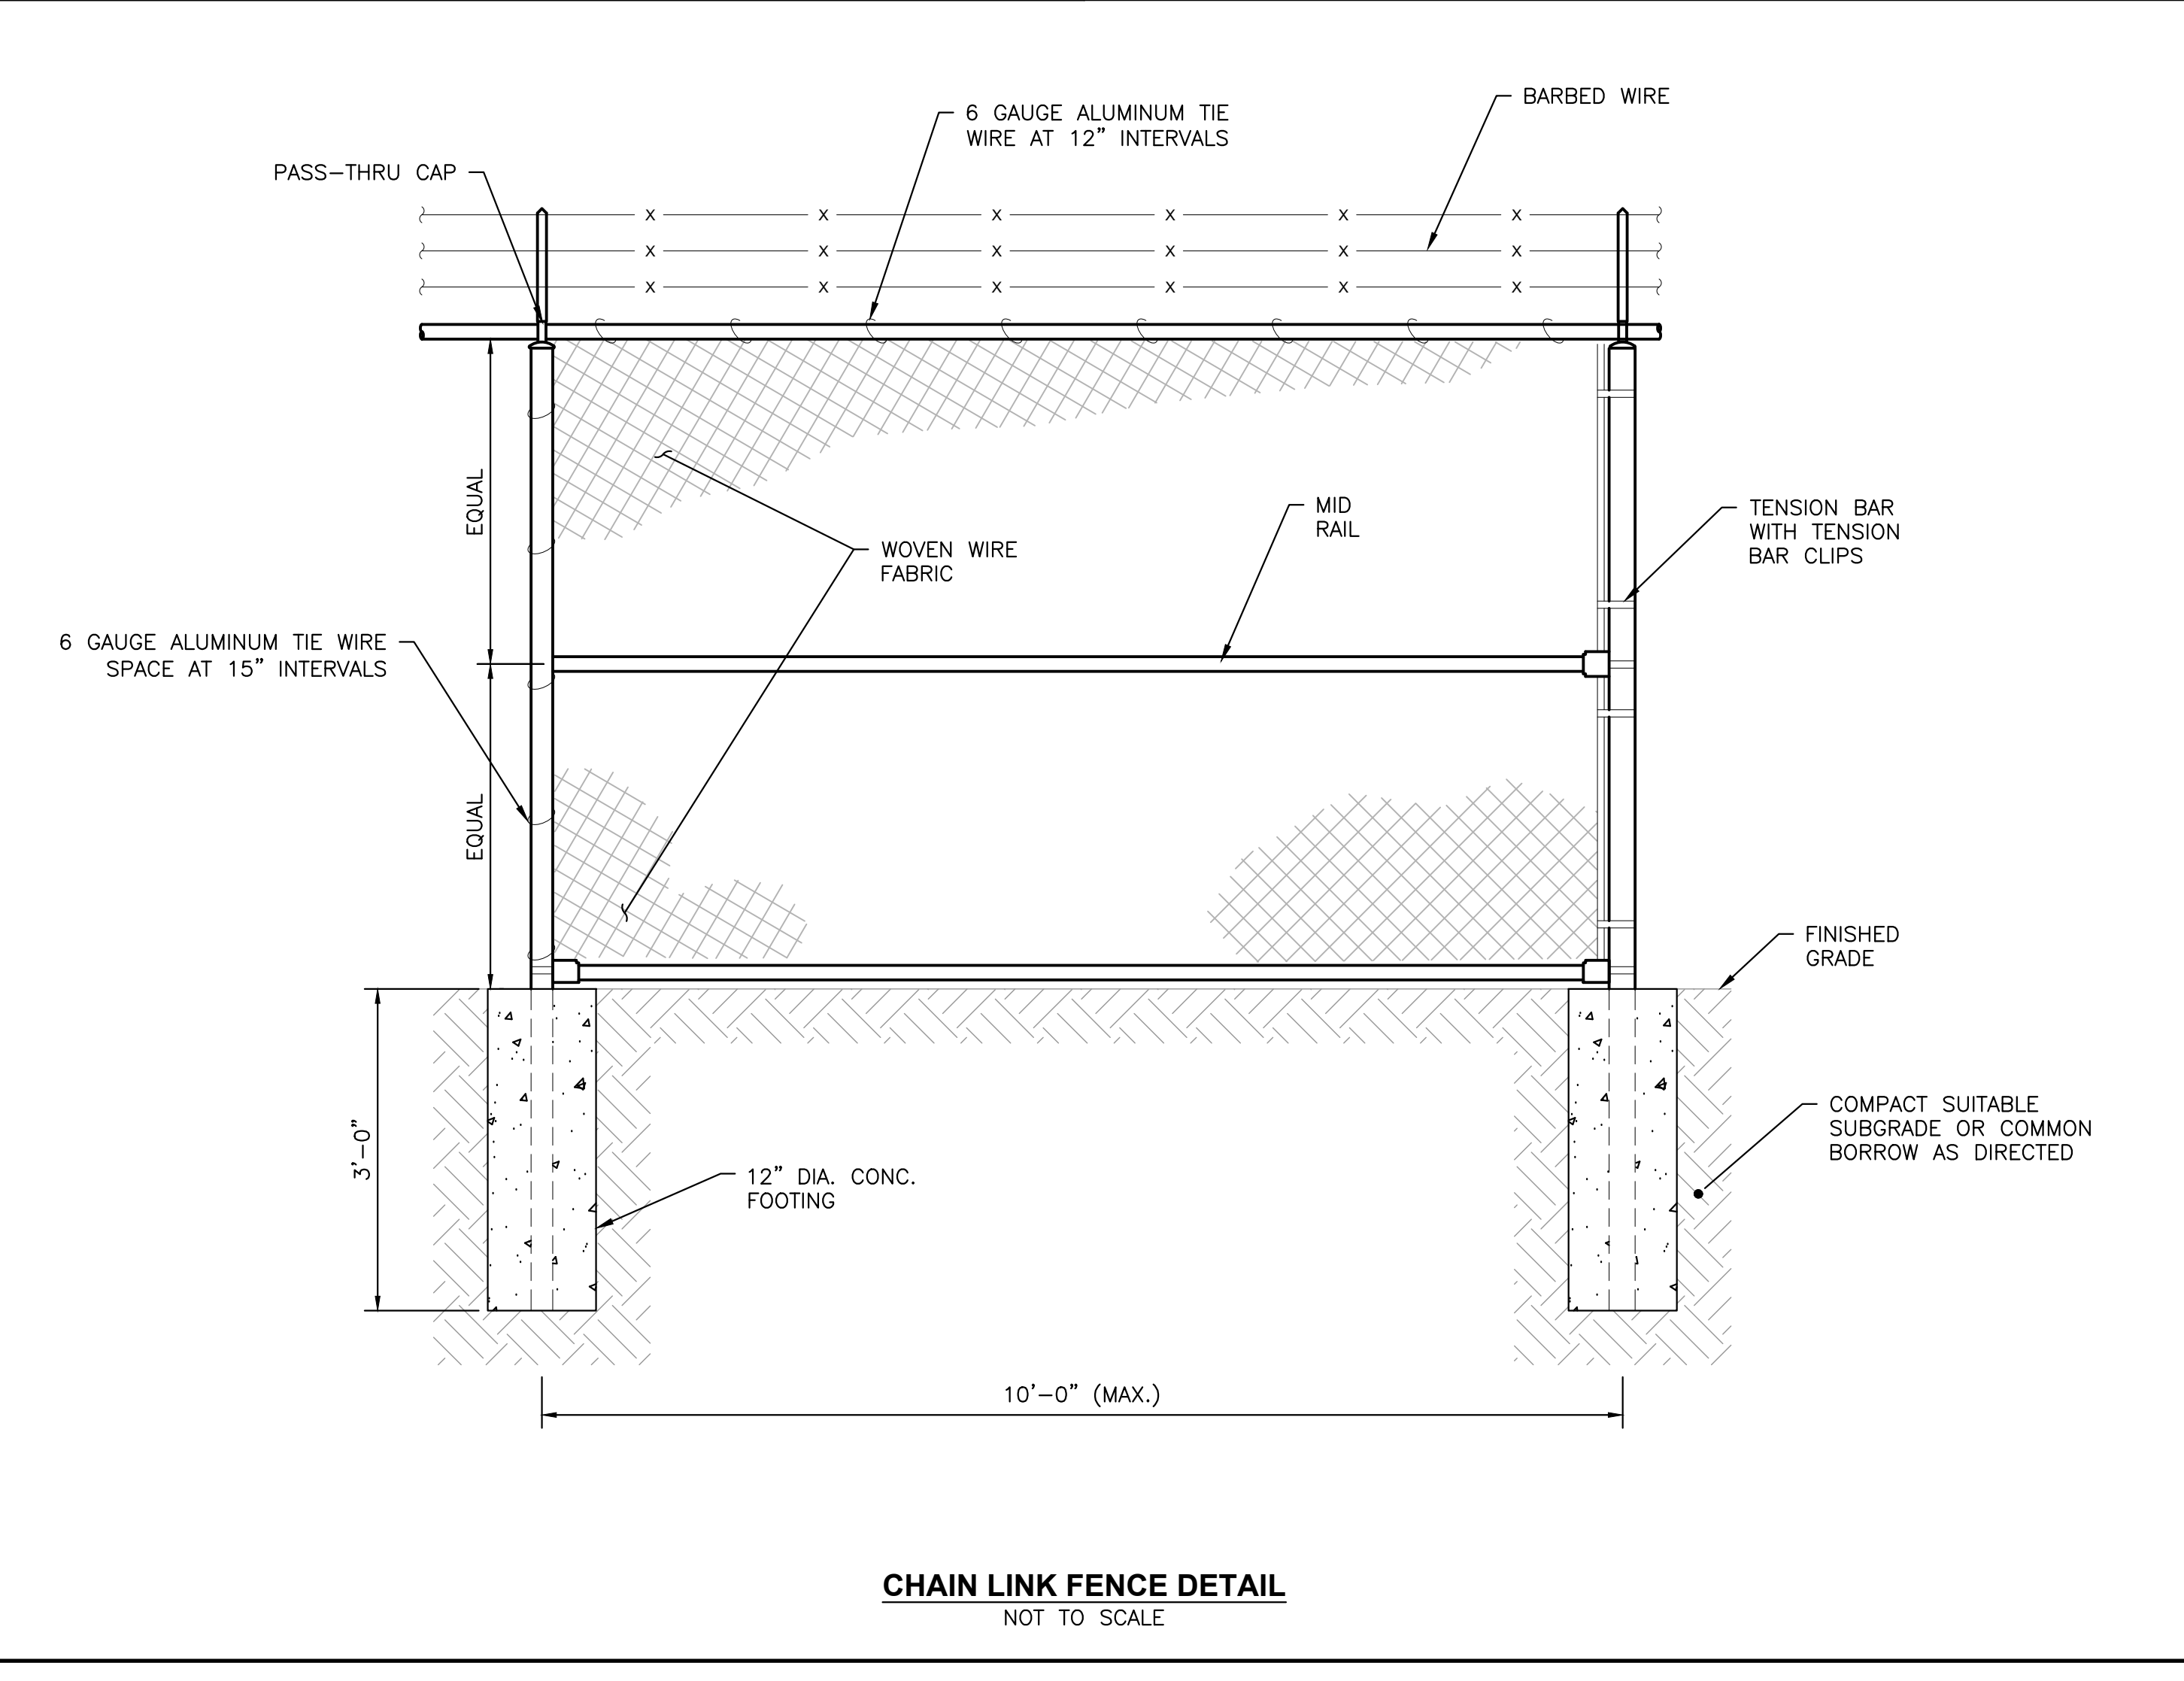


CHAIN LINK FENCE DETAIL
NOT TO SCALE

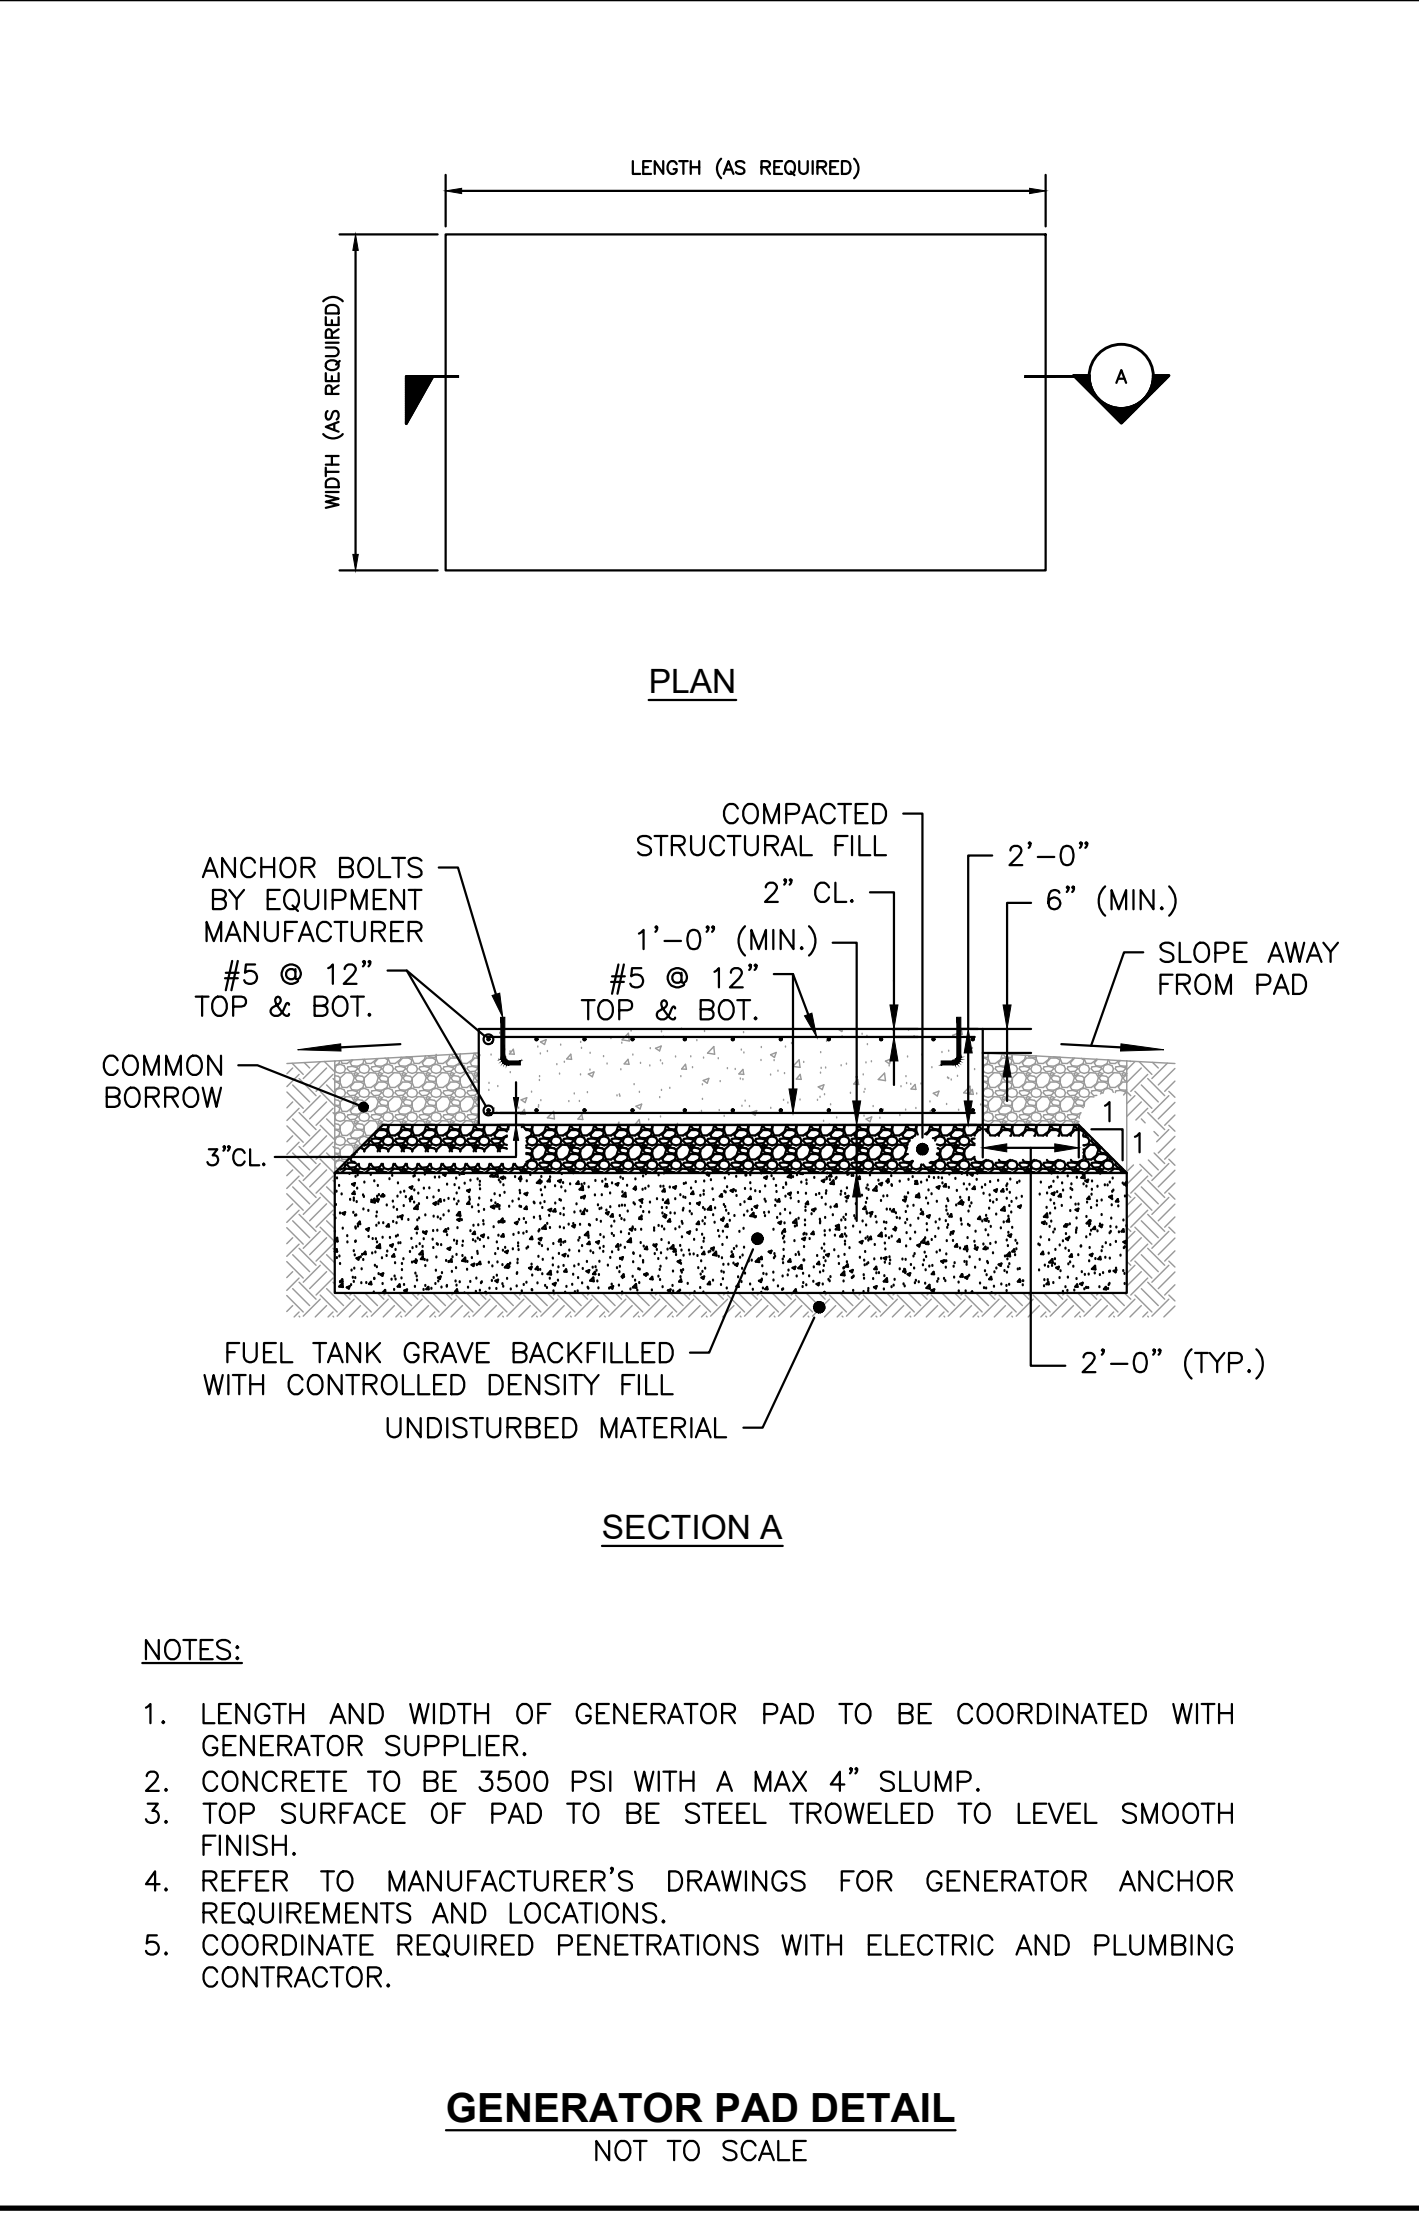


- NOTES:
1. LENGTH AND WIDTH OF GENERATOR PAD TO BE COORDINATED WITH GENERATOR SUPPLIER.
 2. CONCRETE TO BE 3500 PSI WITH A MAX 4" SLUMP.
 3. TOP SURFACE OF PAD TO BE STEEL TROWELED TO LEVEL SMOOTH FINISH.
 4. REFER TO MANUFACTURER'S DRAWINGS FOR GENERATOR ANCHOR REQUIREMENTS AND LOCATIONS.
 5. COORDINATE REQUIRED PENETRATIONS WITH ELECTRIC AND PLUMBING CONTRACTOR.

GENERATOR PAD DETAIL
NOT TO SCALE

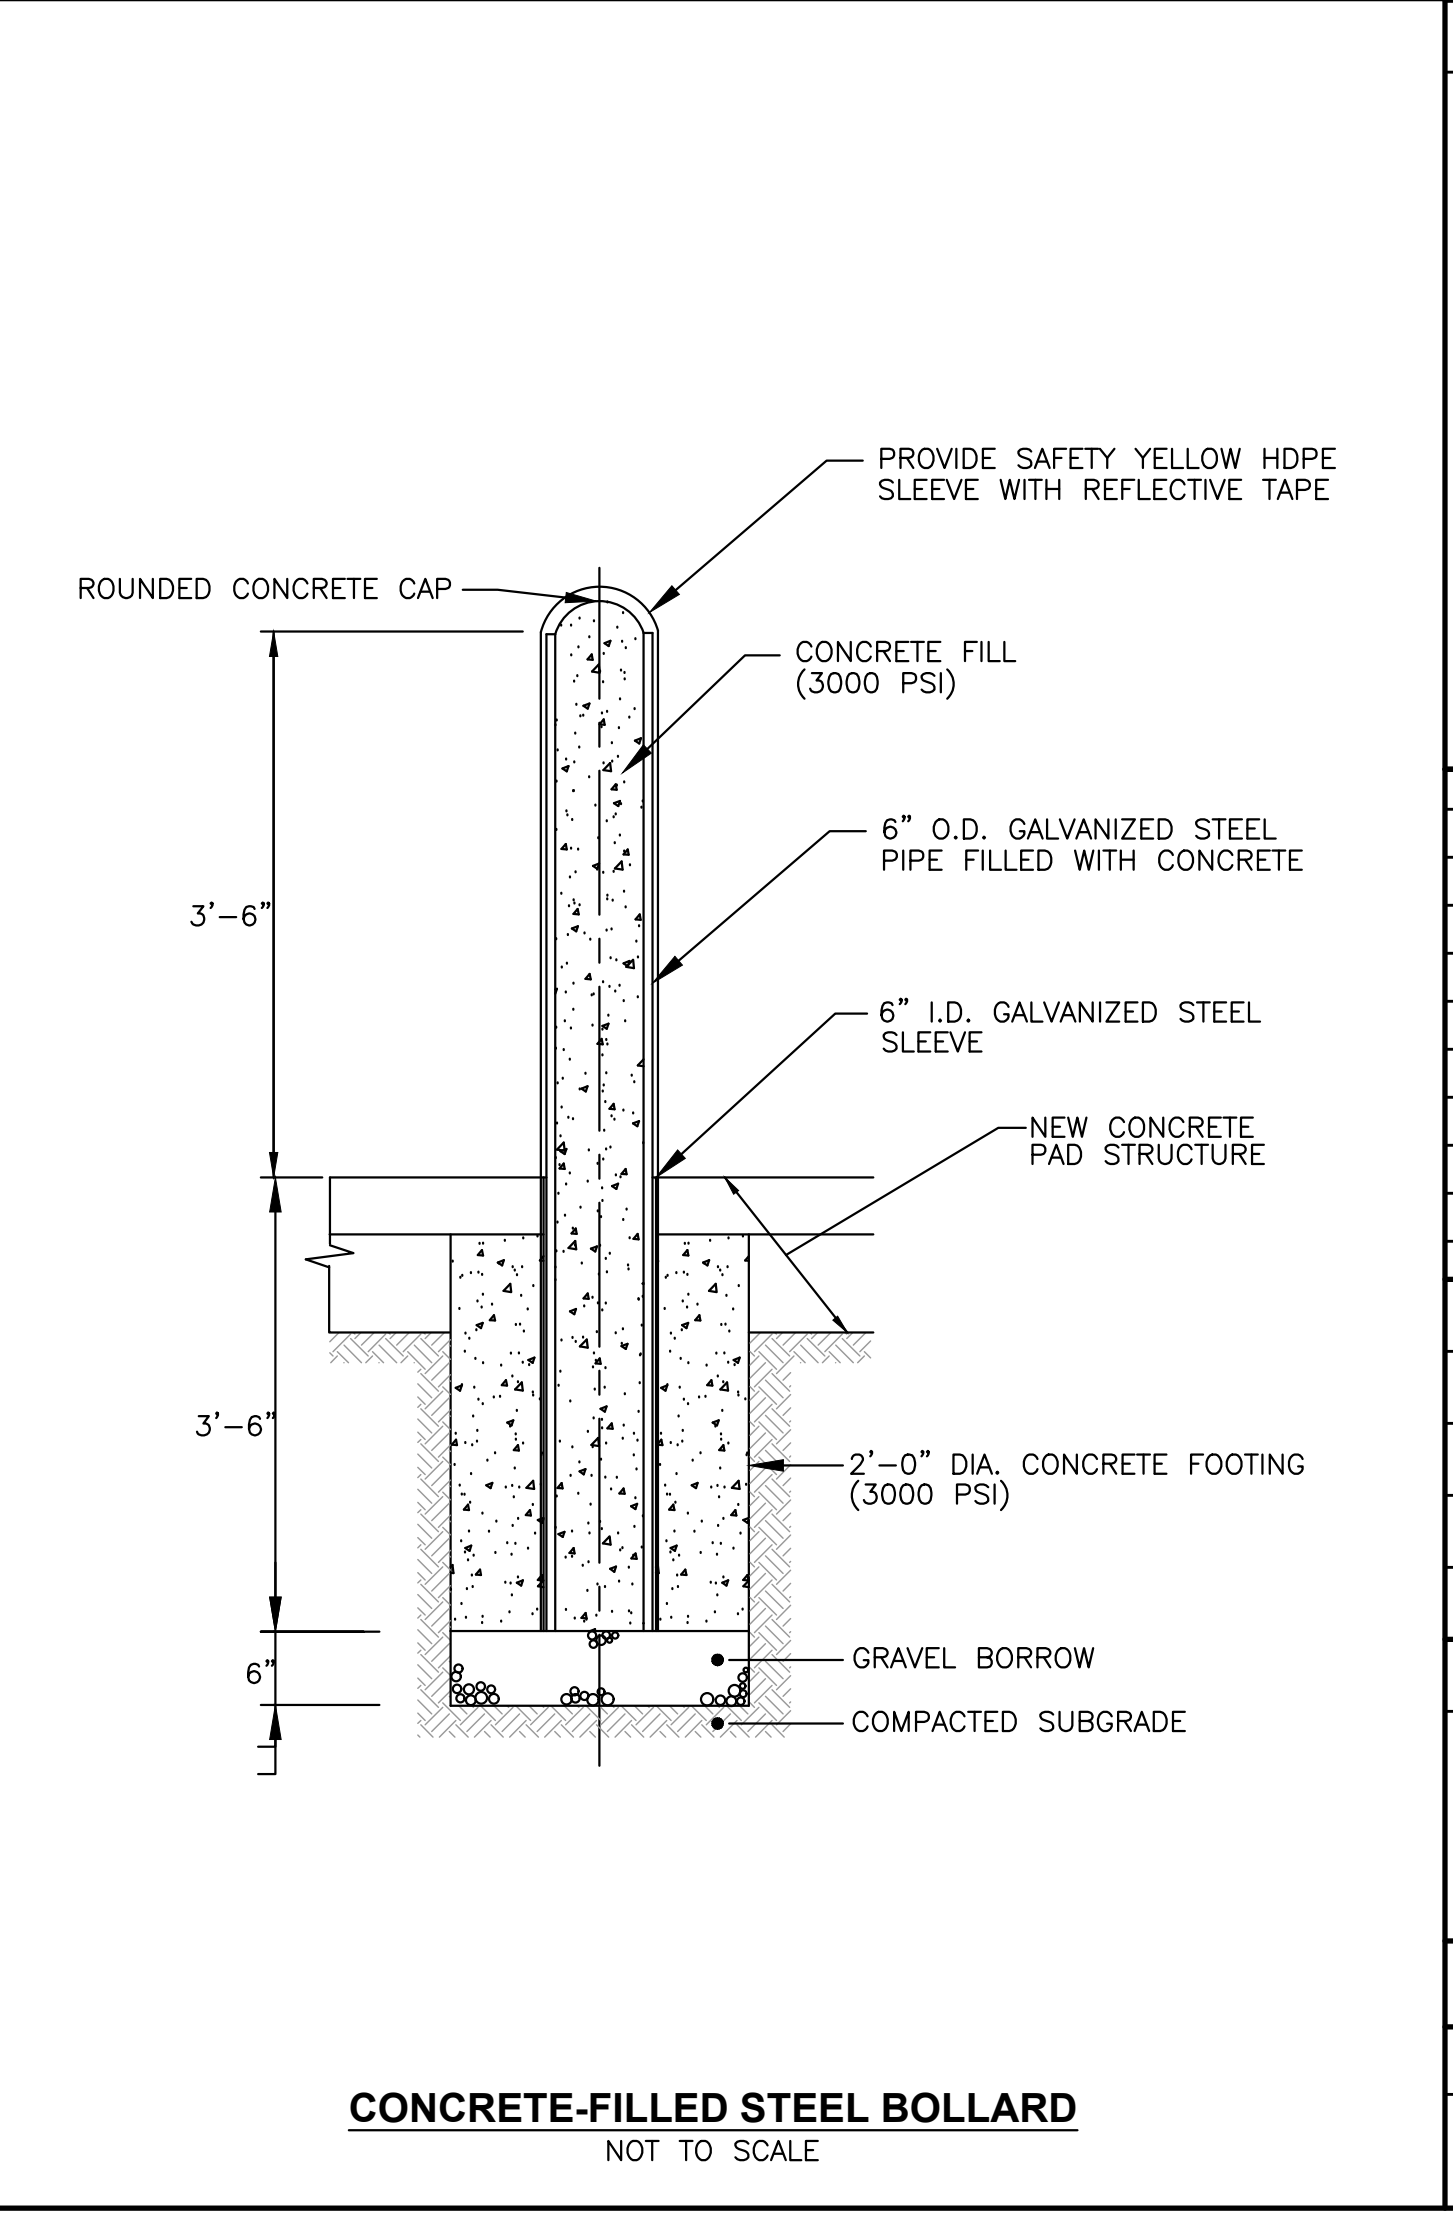

CONCRETE-FILLED STEEL BOLLARD
NOT TO SCALE

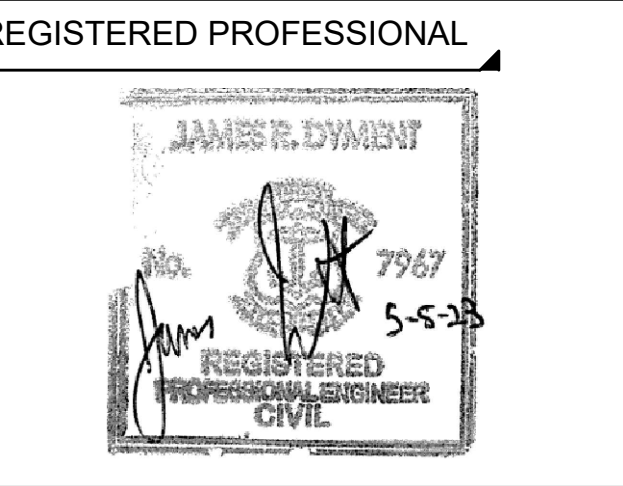

SUBCONSULTANT

PROJECT

BURRILLVILLE WWTF HEADWORKS & OAKLAND PUMP STATION IMPROVEMENTS

BURRILLVILLE, RI

TITLE

CIVIL DETAILS - I

NO.	REVISIONS	DATE

DRAWN BY: CJM

DESIGNED BY: AJG

CHECKED BY: JRD

ISSUE DATE: MAY 2023

BETA JOB NO.: 6861-105

SCALE

AS SHOWN

UNLESS OTHERWISE NOTED OR CHANGED BY REPRODUCTION



For Review Only

SHEET NO.

CD-1


J:\BURRILLVILLE\WWTF-HEADWORKS IMPROVEMENTS\CAD\DRAWING\FILES\PLANS\SET\CIVIL-DETAILS.DWG

5/16/2023

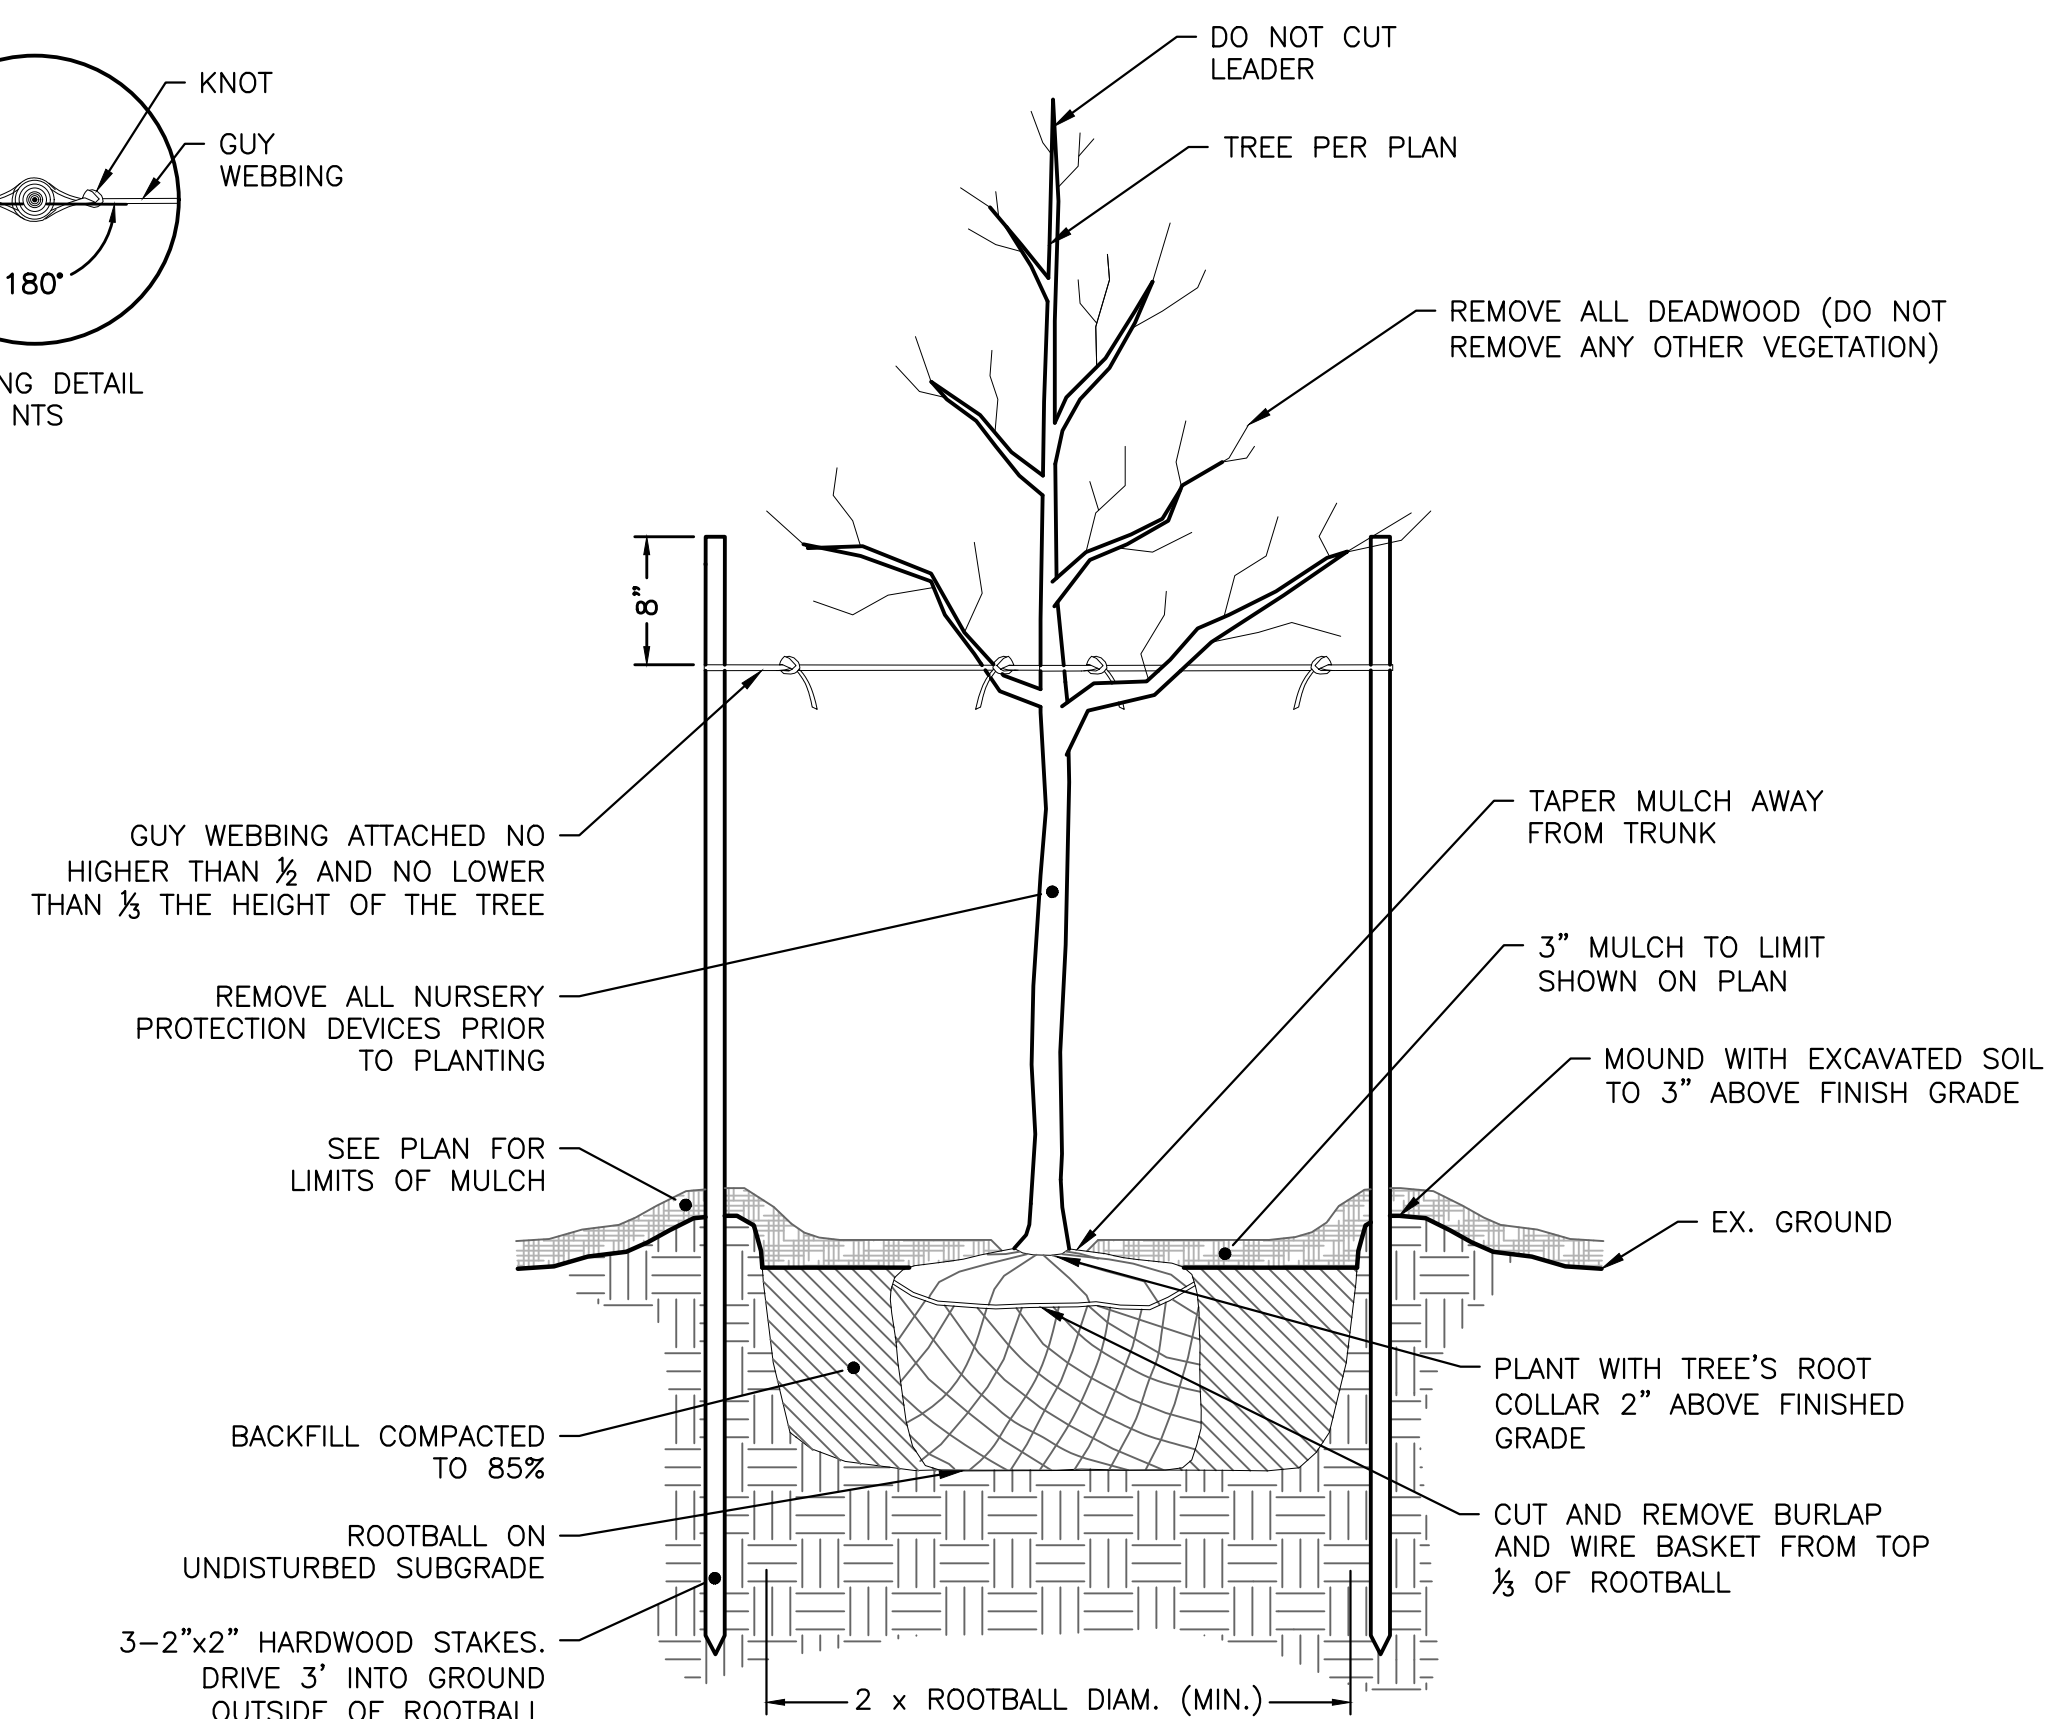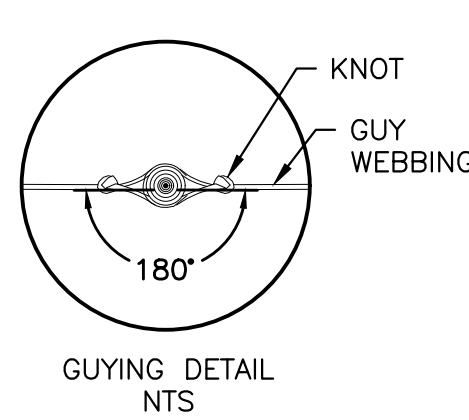


DECIDUOUS TREE STAKING & PLANTING
NOT TO SCALE

- NOTES:
- AFTER THE GUARANTEE PERIOD, THE CONTRACTOR WILL BE RESPONSIBLE FOR THE REMOVAL OF STAKES AND GUY WEBBING.

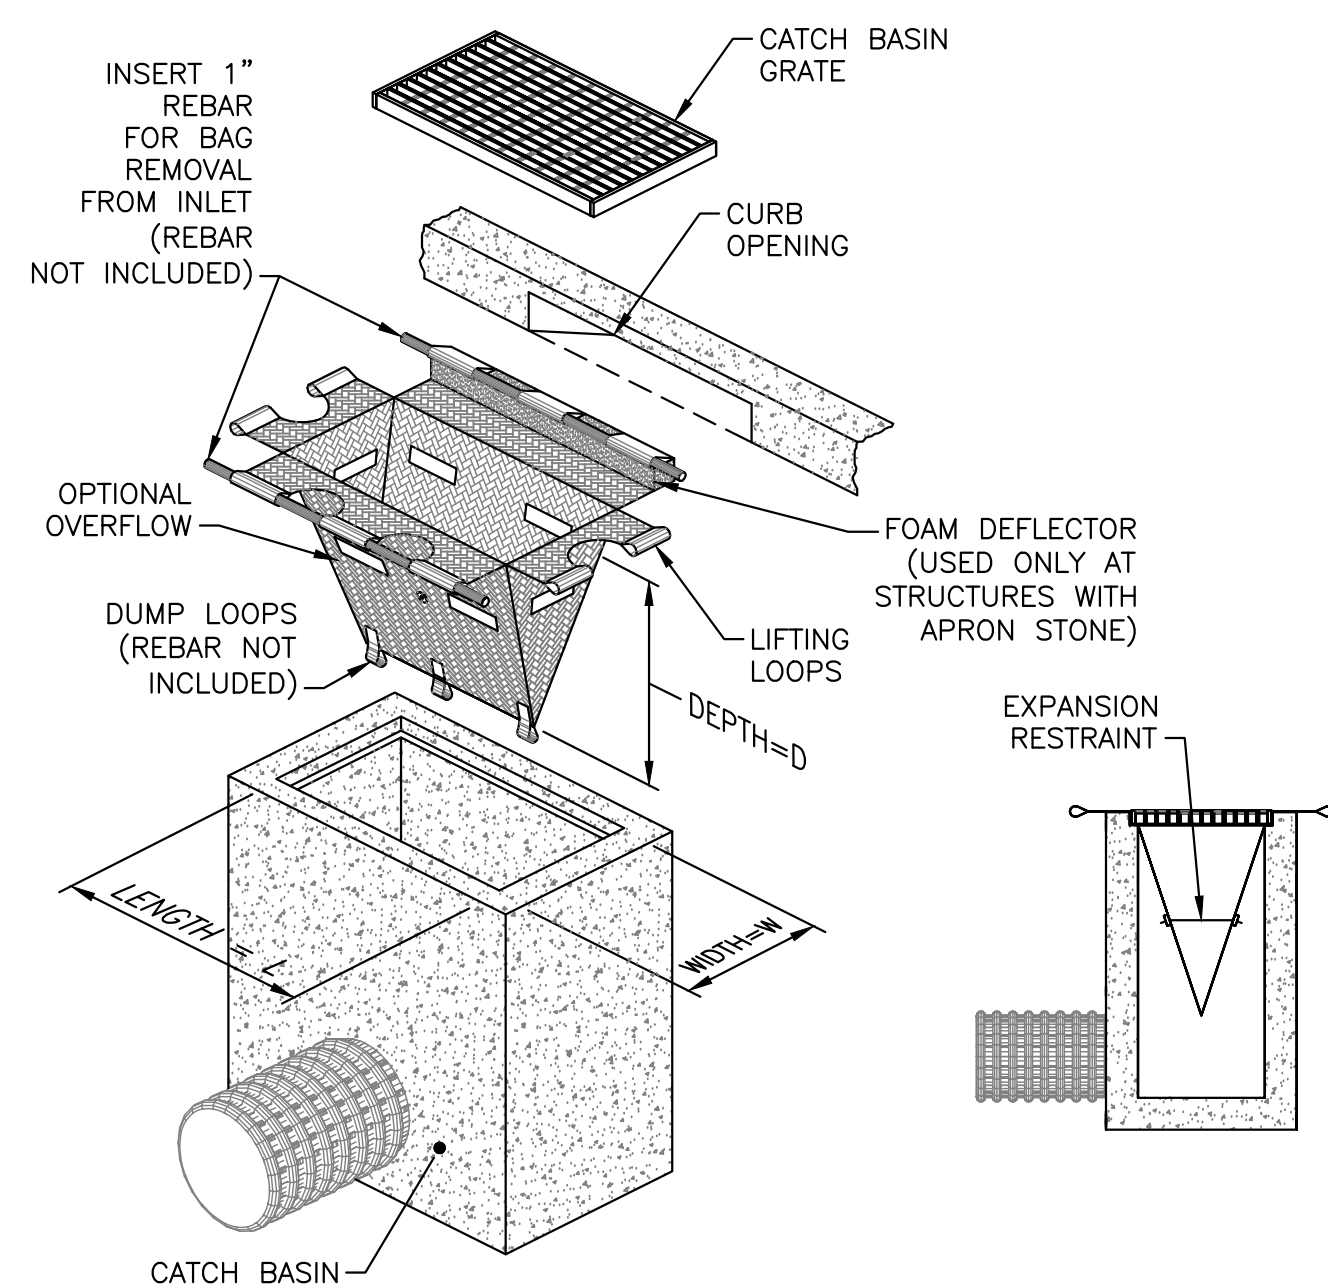


- NOTES:
- CONTRACTOR SHALL MAINTAIN ALL SILT SACK SEDIMENT CONTROL DEVICE INSTALLATIONS AND REPLACE WHEN SATURATED WITH SEDIMENT BASED ON MANUFACTURER RECOMMENDATIONS. SILT SACK SHALL BE INSPECTED AFTER EVERY RAIN EVENT BUT NO LONGER THAN EVERY TWO WEEKS.
 - SILT SACK SHALL BE DOUBLE NEEDLE SEWN POLYPROPYLENE GEOTEXTILE FABRIC AND RATED FOR HIGH FLOW UNLESS OTHERWISE DIRECTED.
 - CONTRACTOR SHALL PROVIDE CURB OPENING DEFLECTOR AT ALL CATCH BASINS AS NECESSARY.

INLET SEDIMENT CONTROL DEVICE (SILT SACK)
(WITH OPTIONAL CURB DEFLECTOR)
NOT TO SCALE

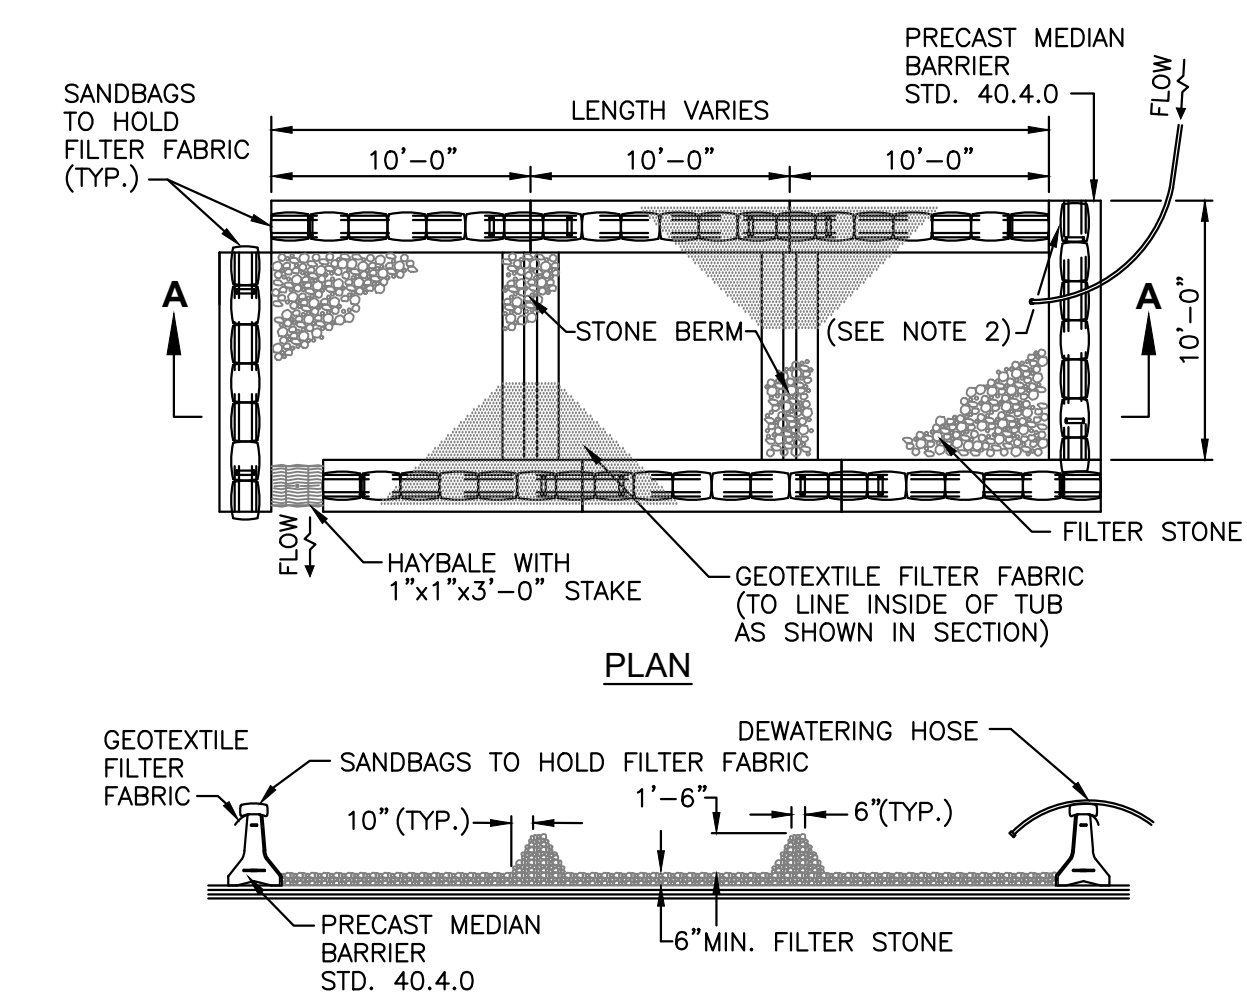

- NOTES:
- SHALL BE IN ACCORDANCE WITH SECTION 208 OF THE R.I. STANDARD SPECIFICATIONS.
 - PROVIDE ADDITIONAL SAND BAGS AS REQUIRED TO FILL SPACE BETWEEN ADJACENT BARRIERS.

DEWATERING BASIN
NOT TO SCALE

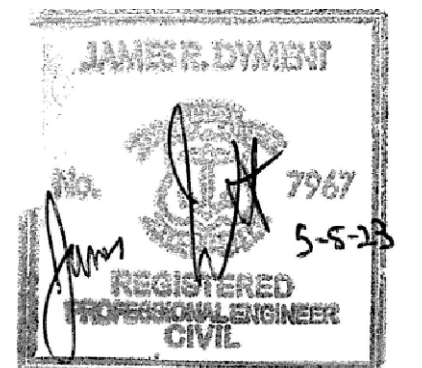

NO.	REVISIONS	DATE


DRAWN BY: CJM
DESIGNED BY: AJG
CHECKED BY: JRD
ISSUE DATE: MAY 2023
BETA JOB NO.: 6861-105

SCALE


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For Review Only


SHEET NO.
CD-3

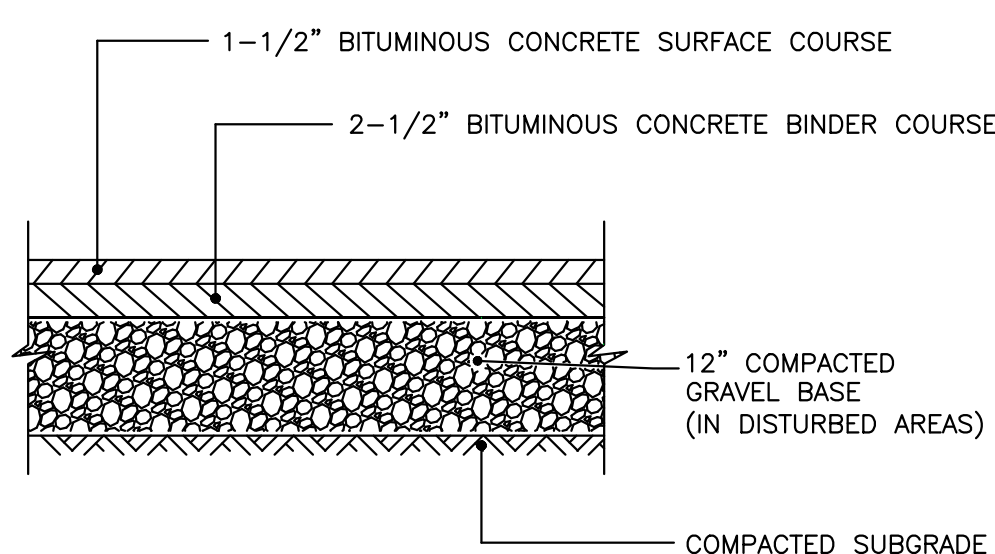


TYPICAL PAVEMENT DETAIL
NOT TO SCALE

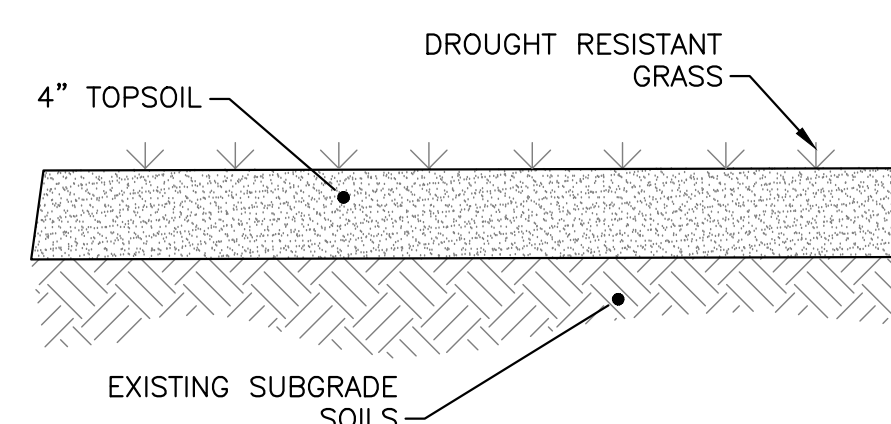


GROUND COVER DETAIL
NOT TO SCALE

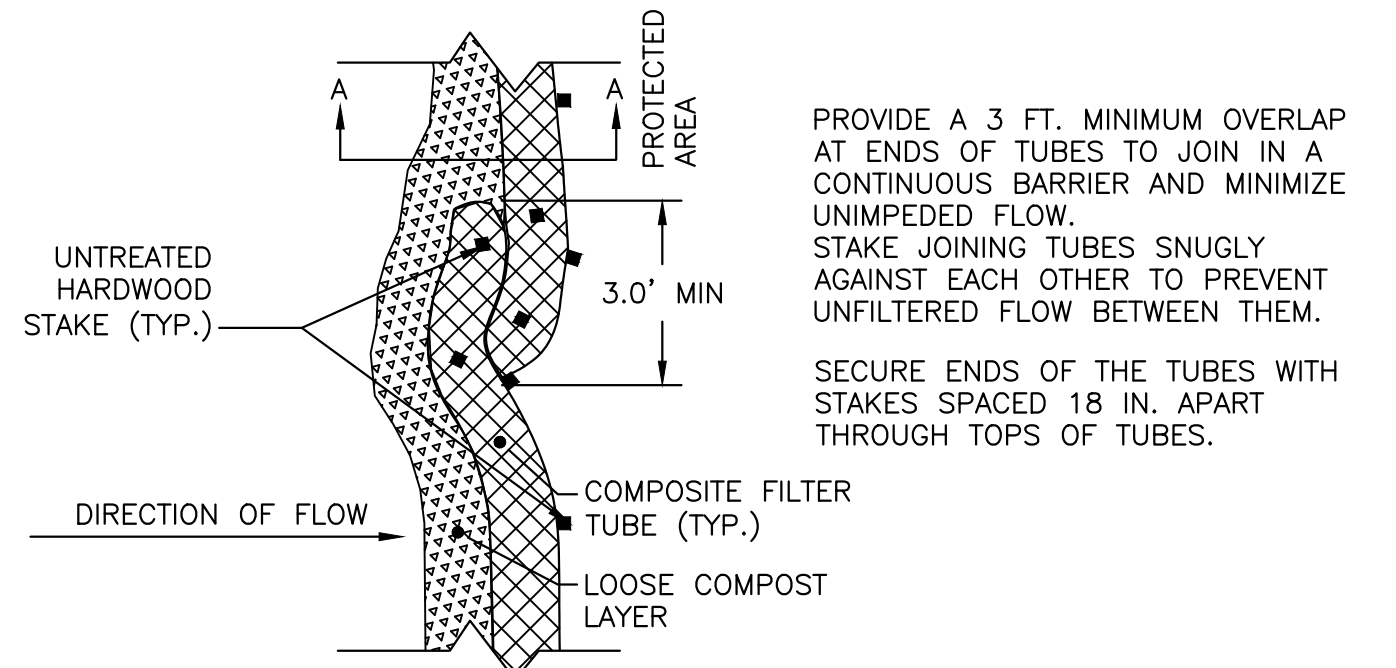


PLAN VIEW - JOIN DETAIL

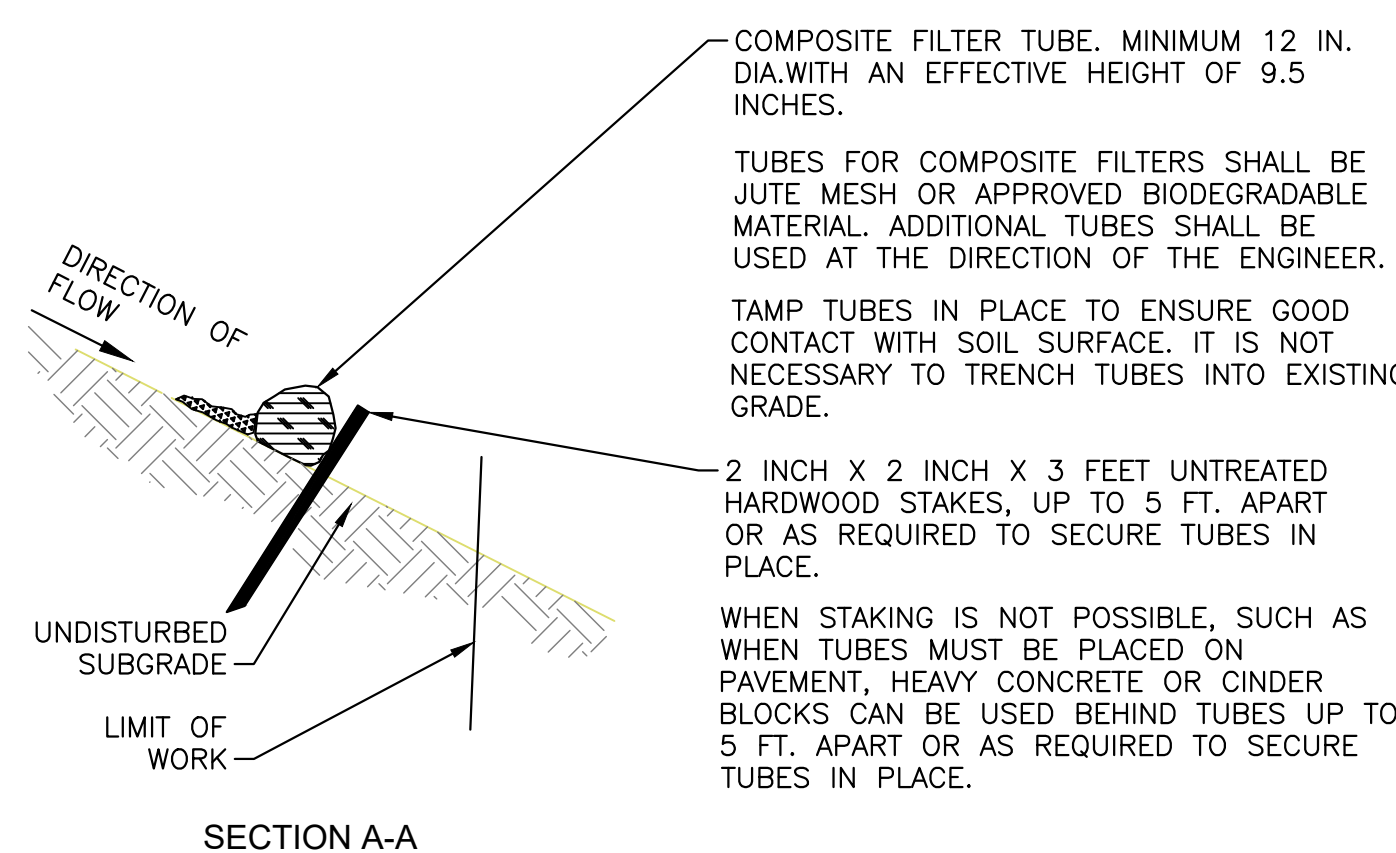

COMPOST FILTER TUBE - FOR EROSION CONTROL
NOT TO SCALE

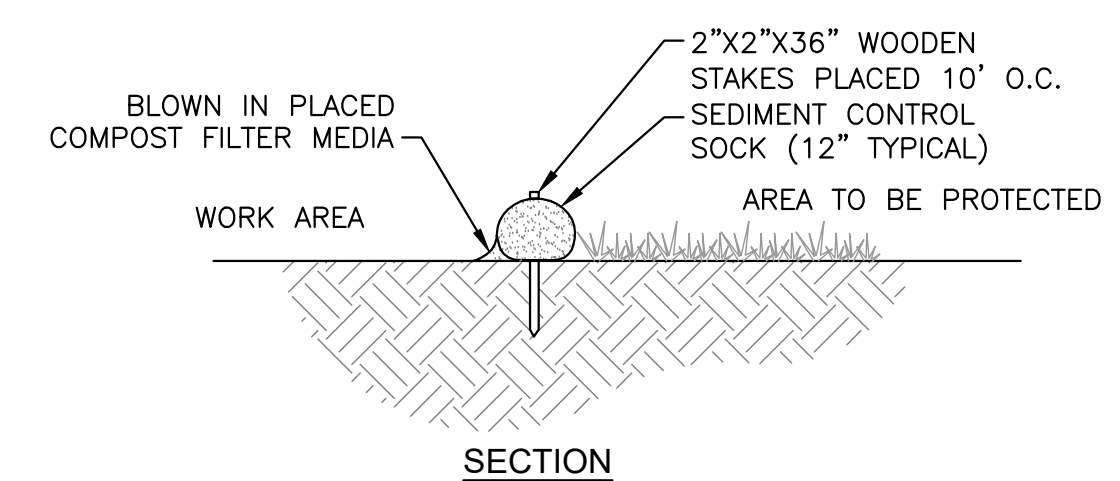

SECTION

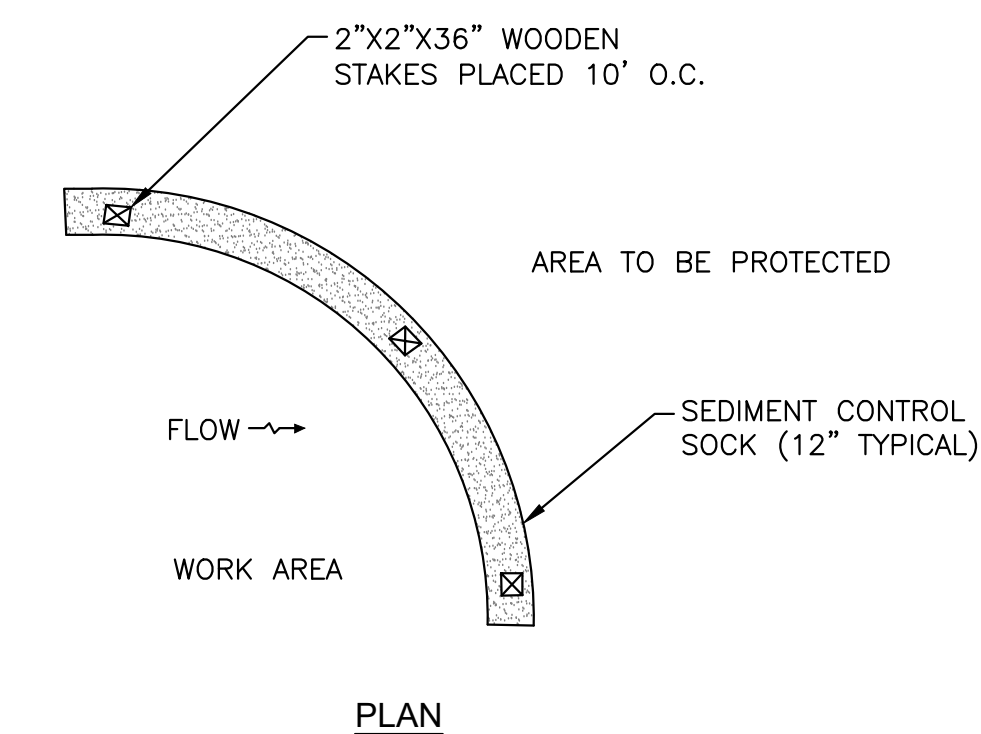


PLAN


- NOTES:
- SOCKS SHALL BE PLACED IN A ROW WITH ENDS OVERLAPPING THE ADJACENT SOCK.
 - SOCKS SHALL BE SECURELY ANCHORED IN PLACE BY STAKES DRIVEN THROUGH THE SOCKS.
 - INSPECTION SHALL BE FREQUENT AND REPAIR OR REPLACEMENT SHALL BE MADE PROMPTLY AS NEEDED.
 - SOCKS SHALL BE REMOVED WHEN WORK IS COMPLETE AN THE AREA HAS STABILIZED.

SEDIMENT CONTROL "COMPOST SOCK"
NOT TO SCALE


\\BETA-INC.COM\RIEN\FROMBURRILLVILLE\WWTF - HEADWORKS IMPROVEMENTS\CADD\DRAWING\FILES\PLANS\STRUCTURAL\DETAILS.DWG 5/15/2023

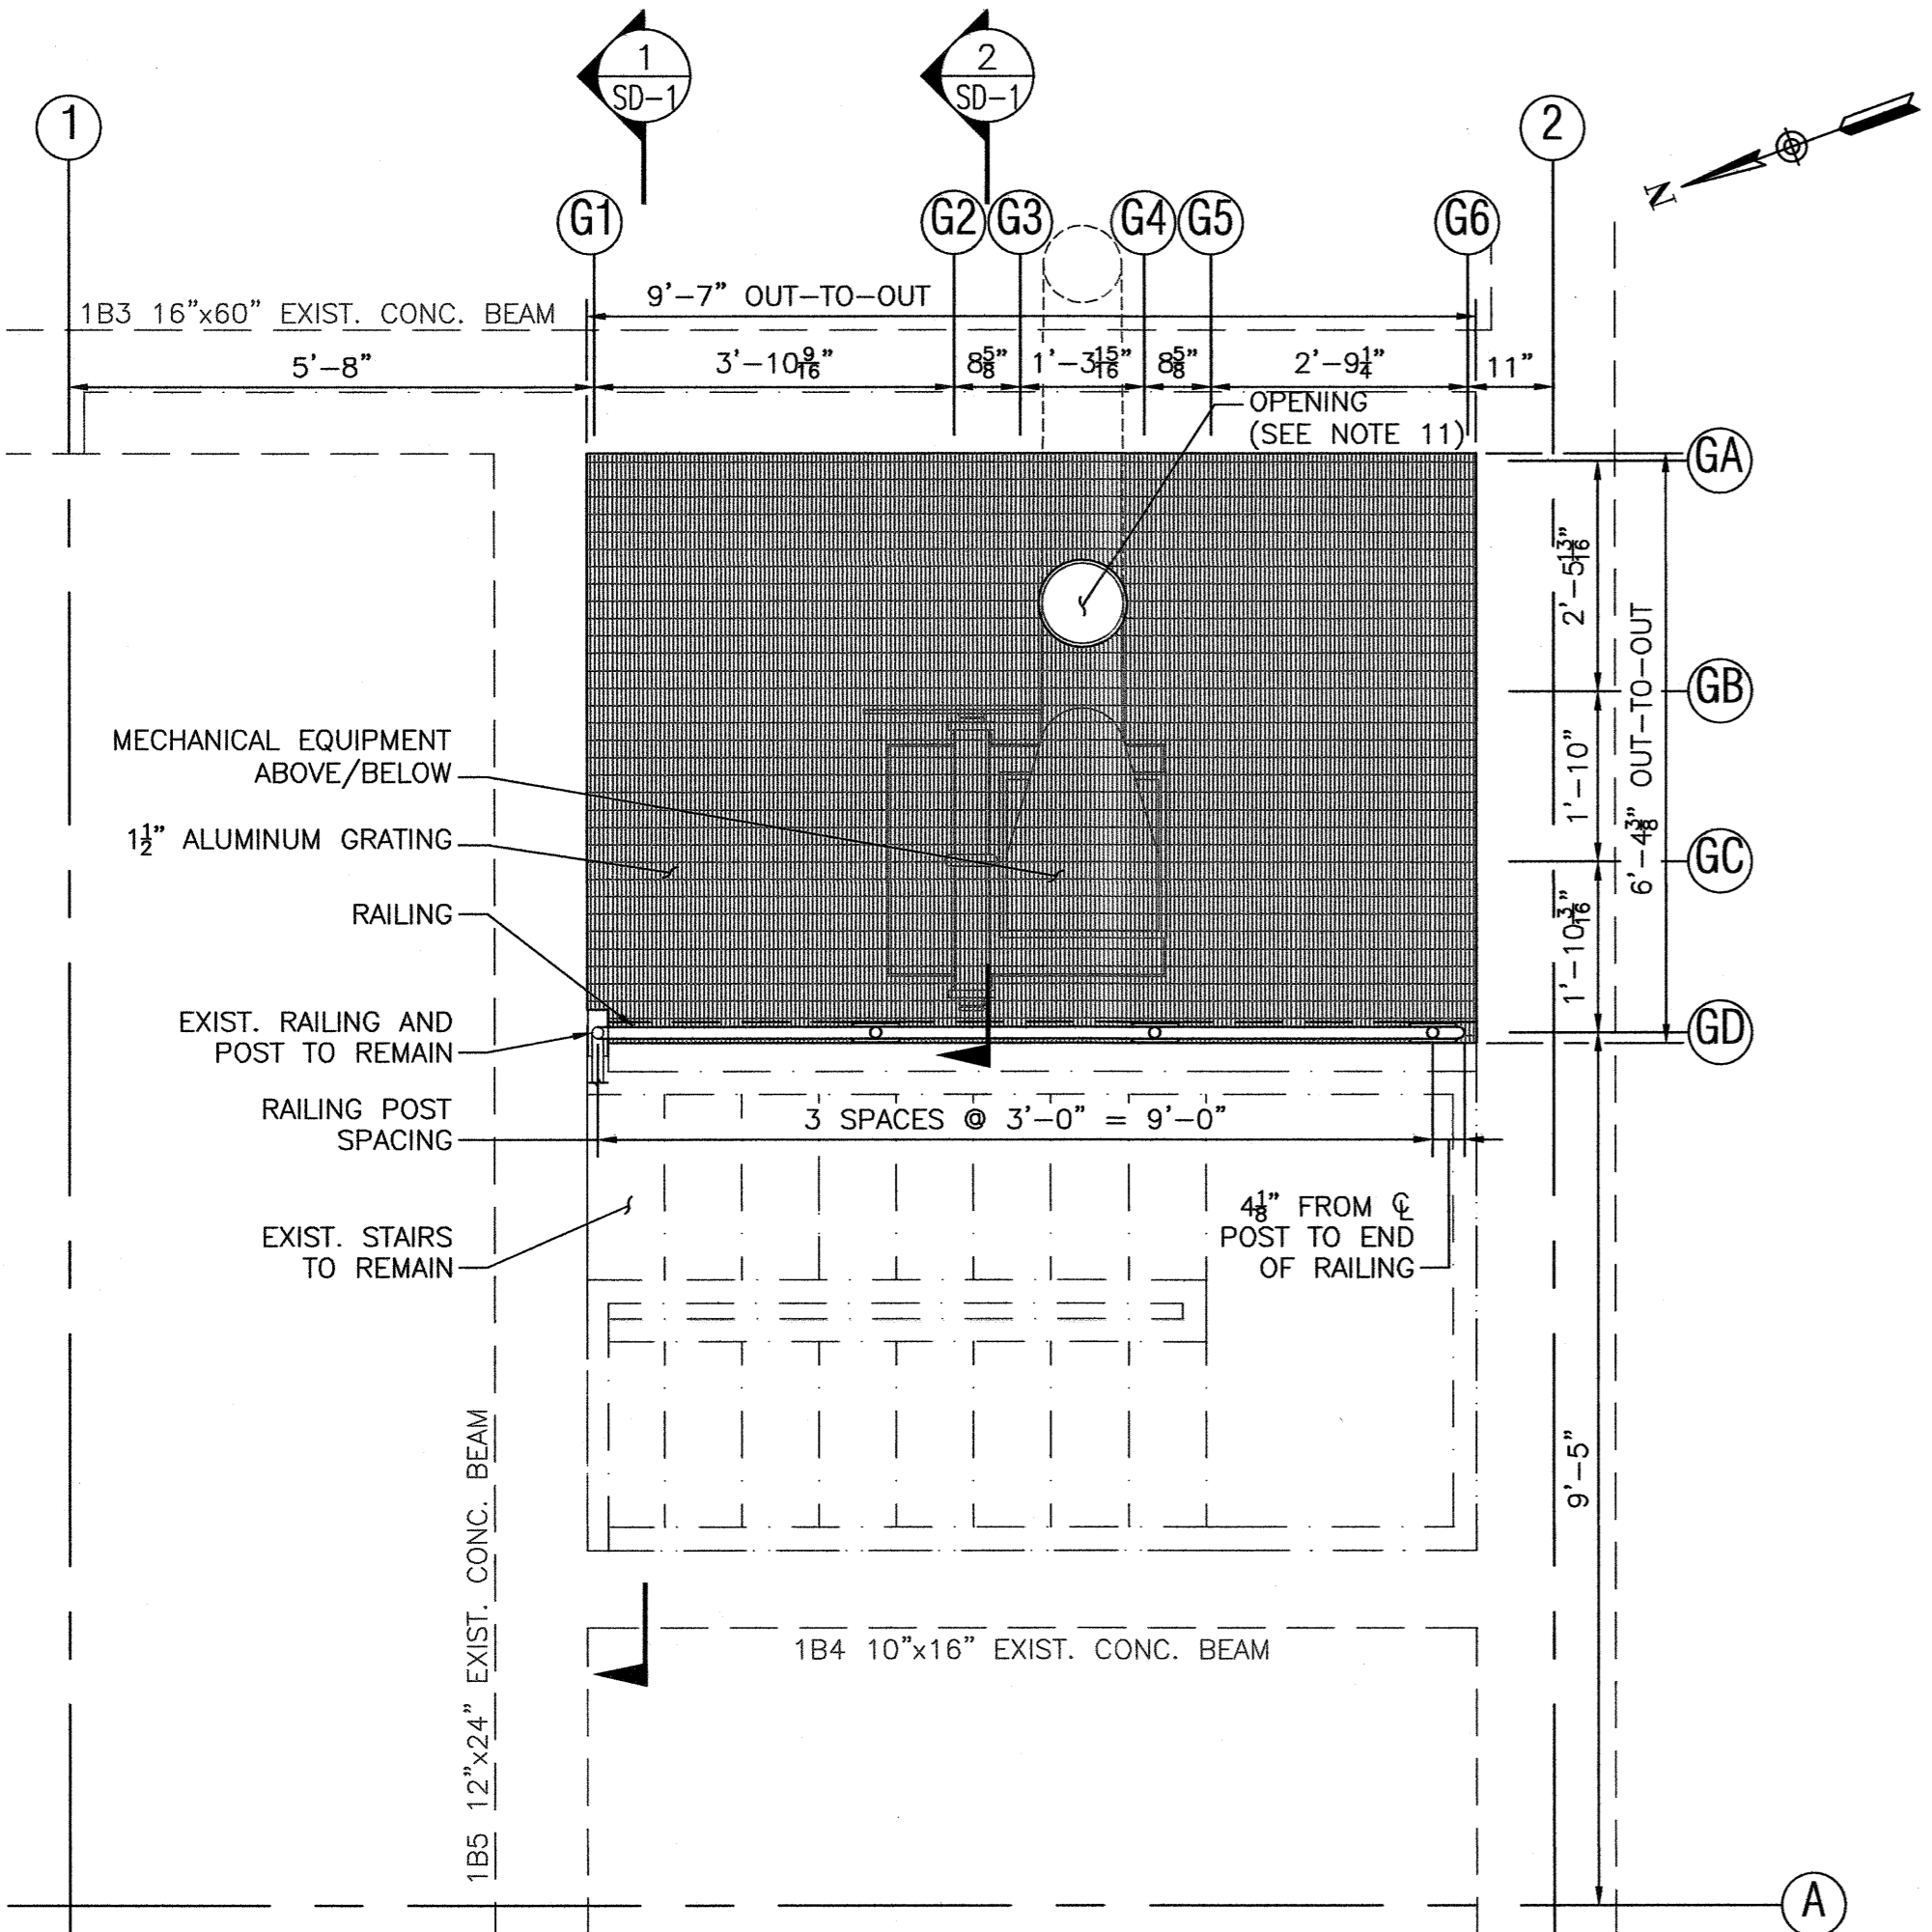


[ADD/ALT. 1B]
ELEVATED PLATFORM GRATING PLAN
SCALE: 1/2" = 1'-0"

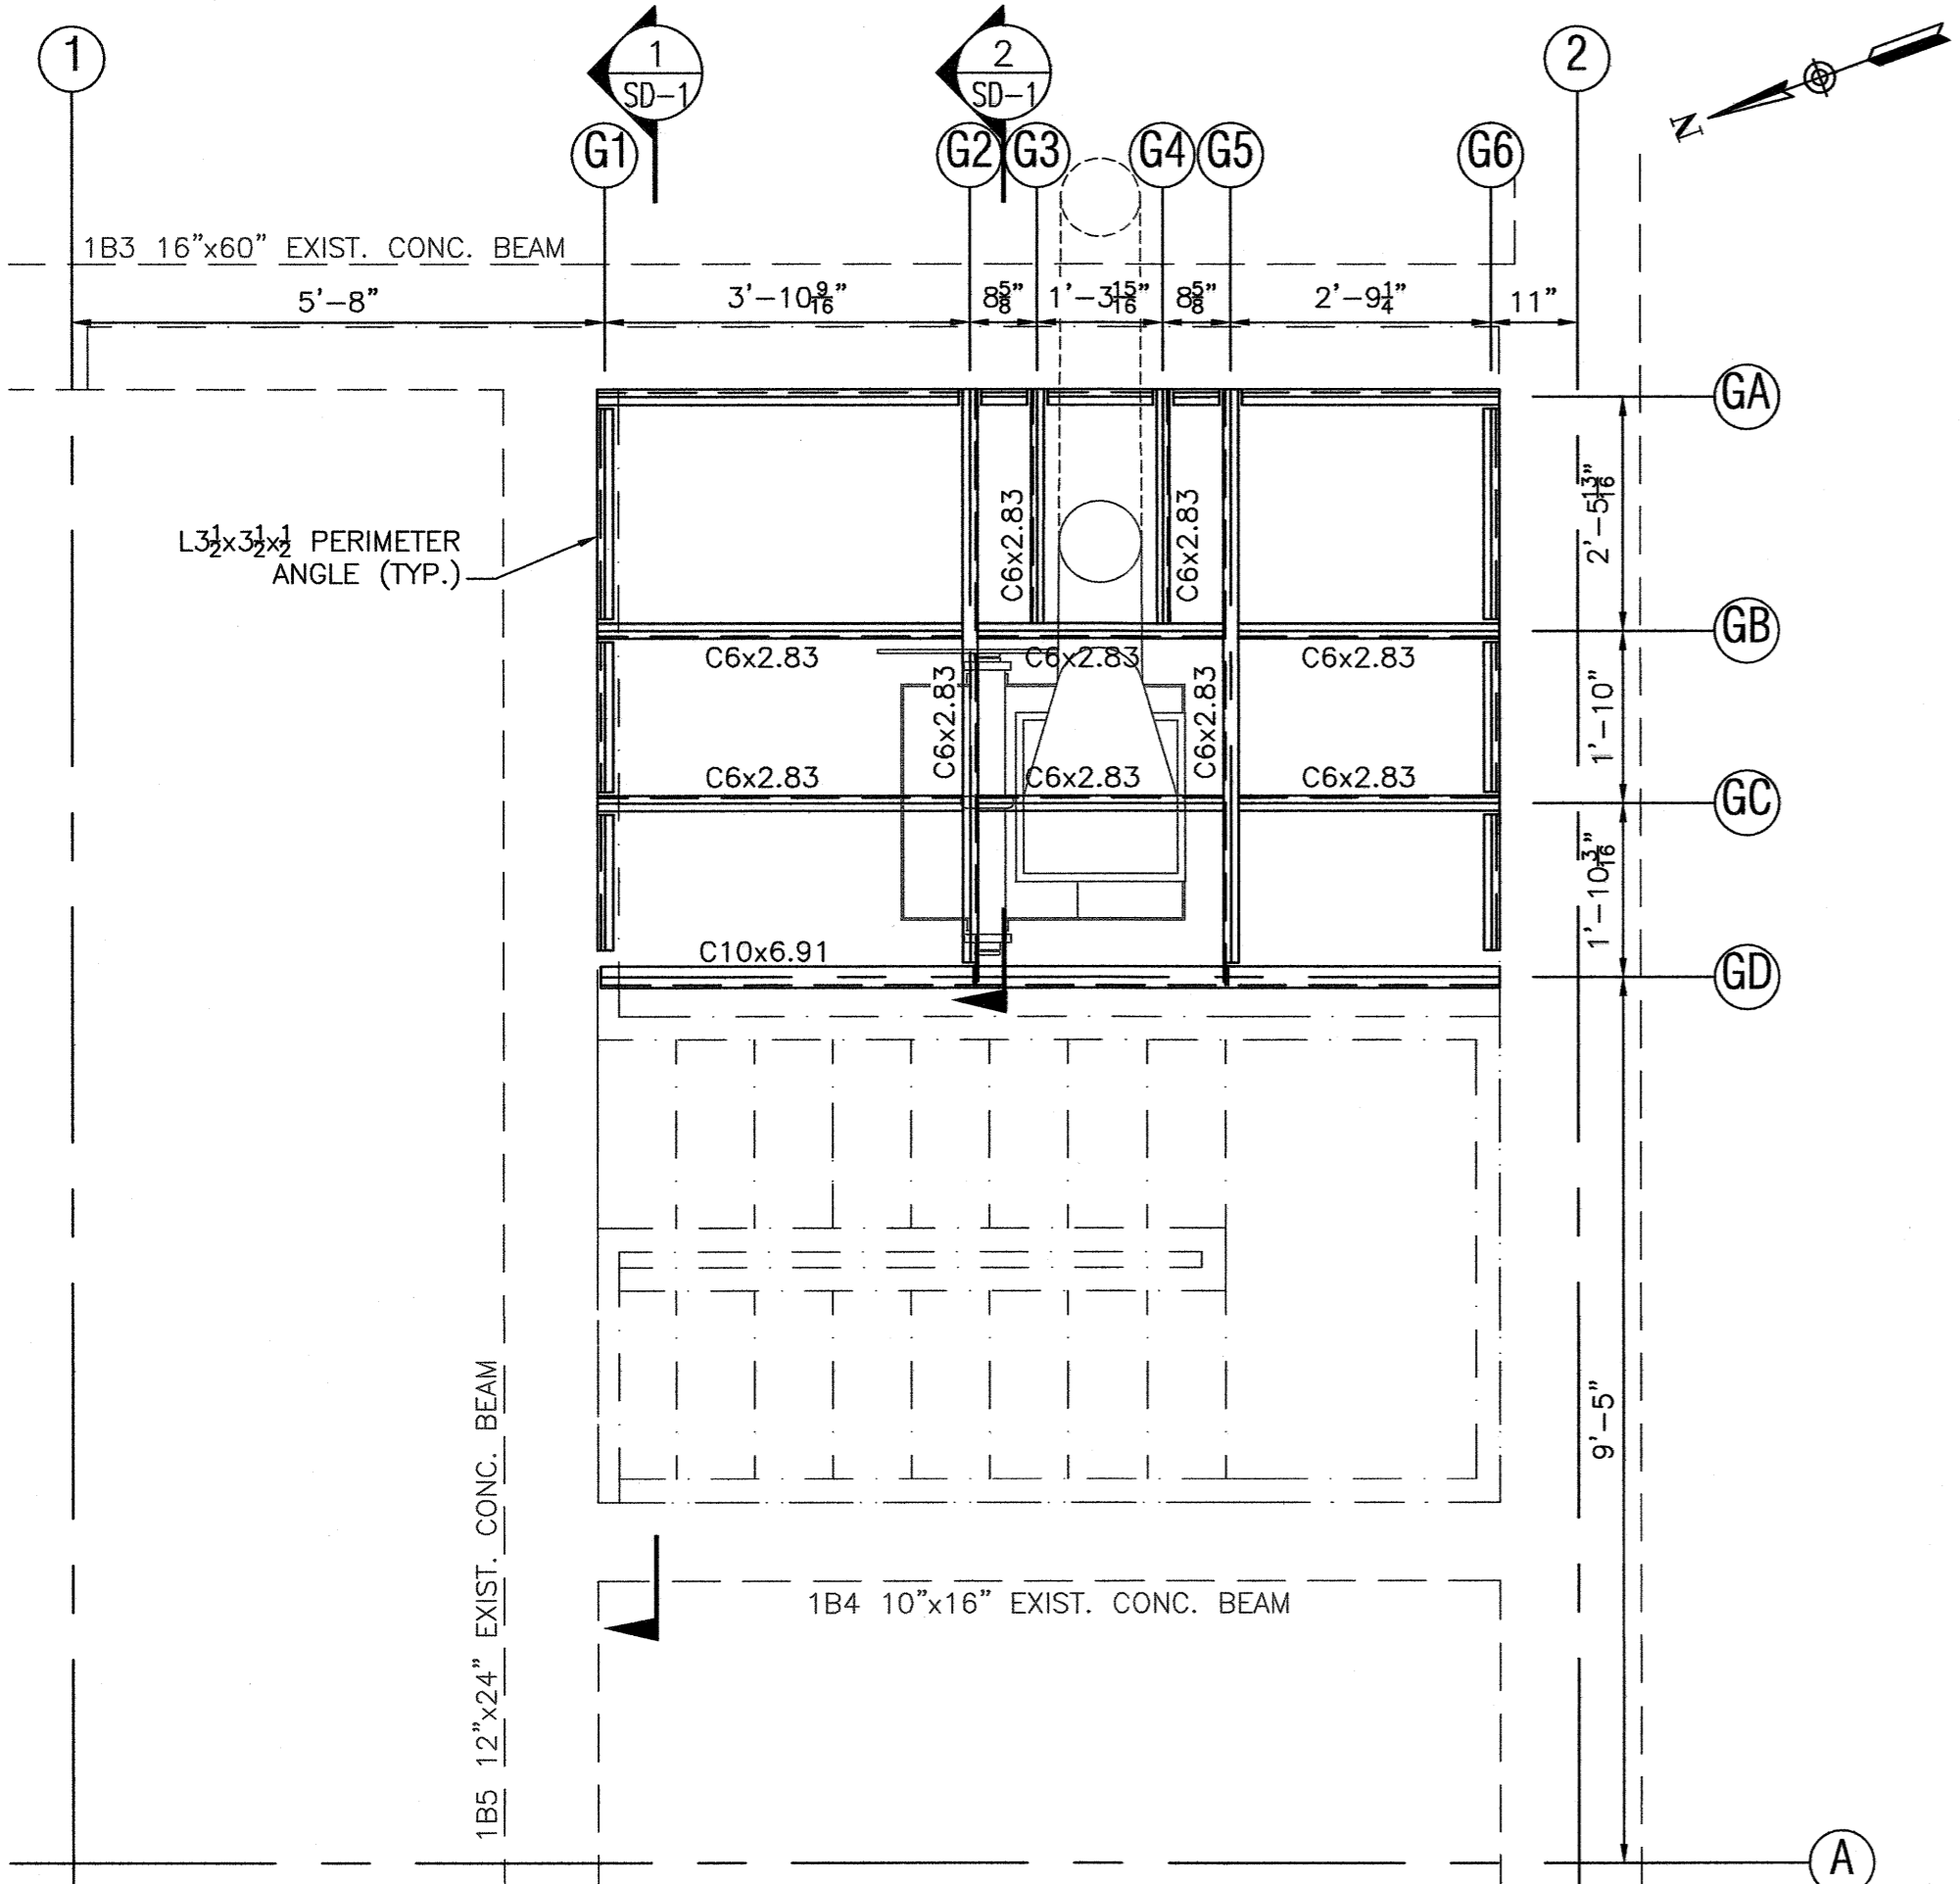


[ADD/ALT. 1B]
ELEVATED PLATFORM FRAMING PLAN
SCALE: 1/2" = 1'-0"

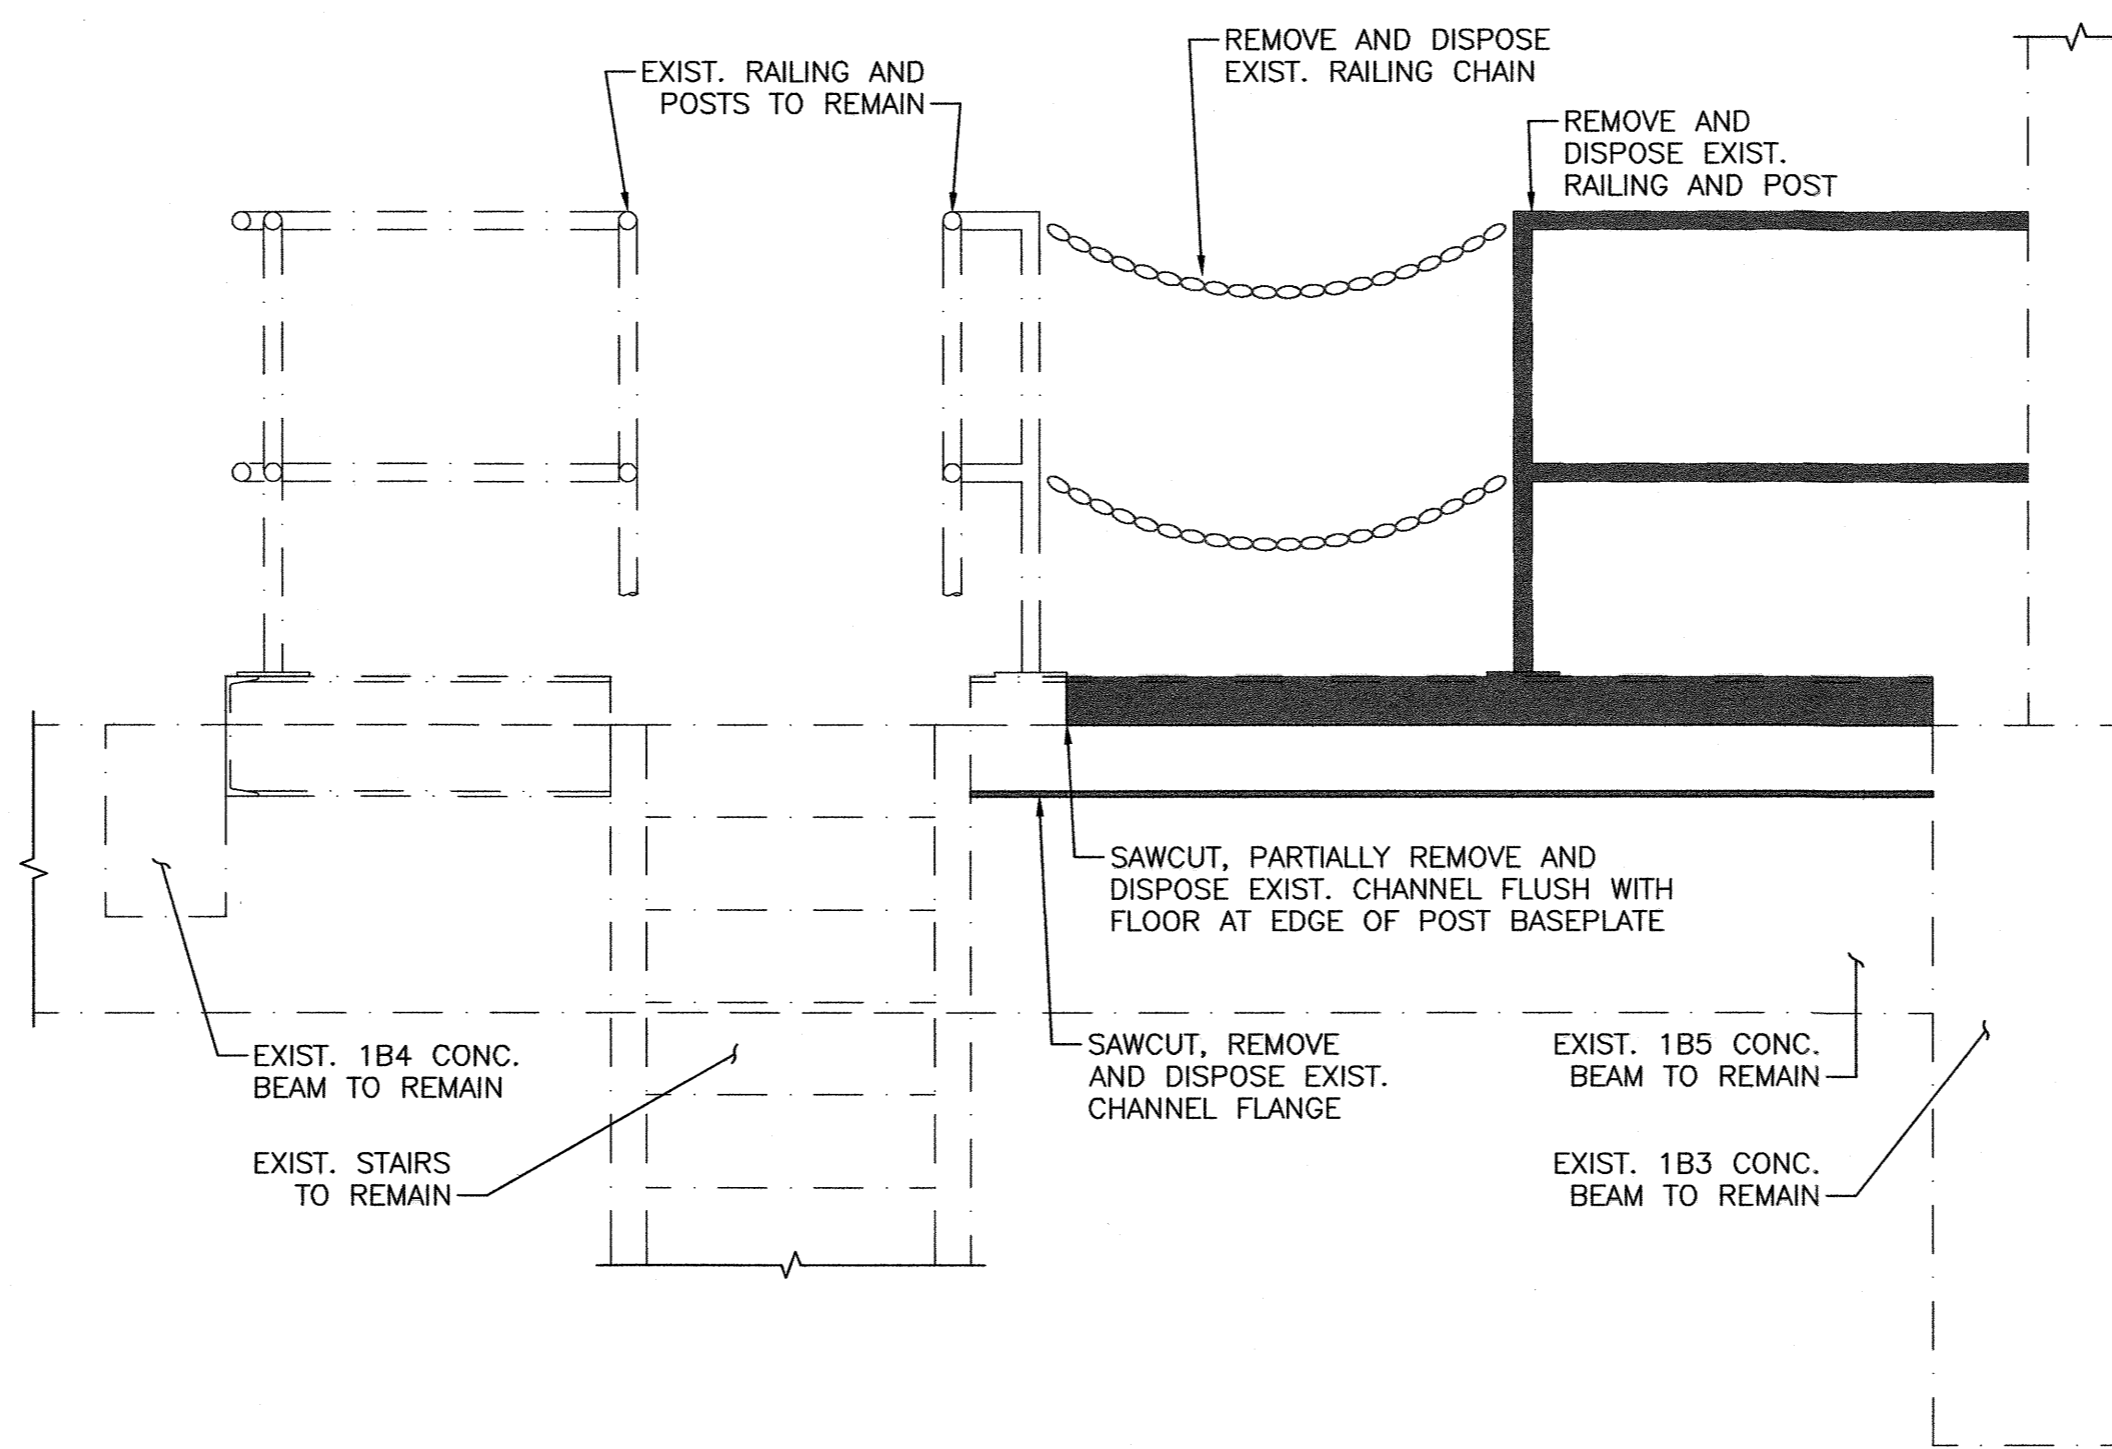

SECTION 1 - DEMOLITION
SCALE: 3/4" = 1'-0"

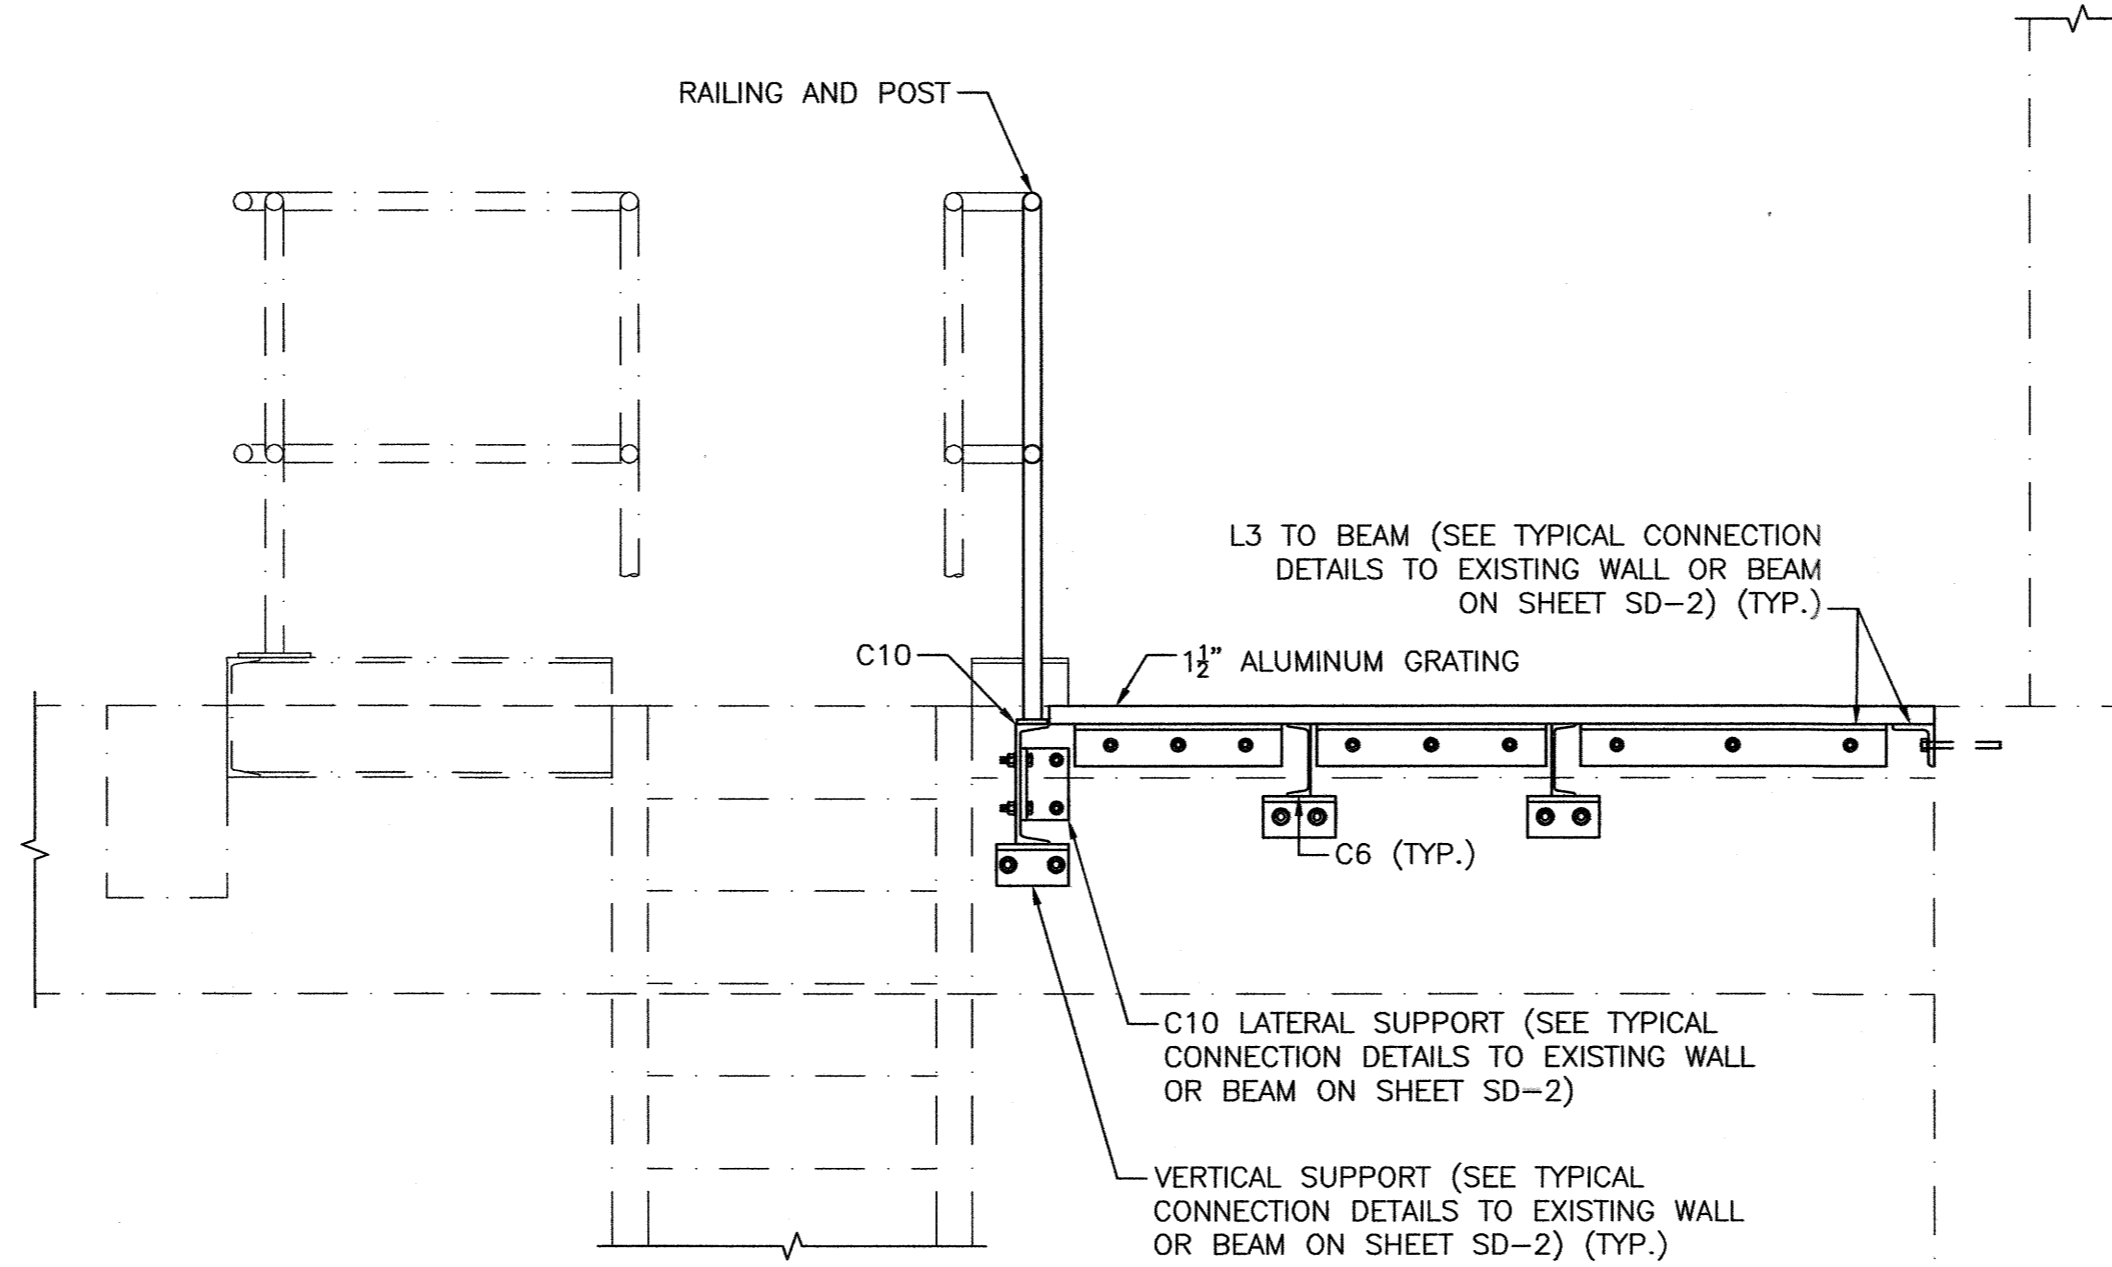

SECTION 1
SCALE: 3/4" = 1'-0"

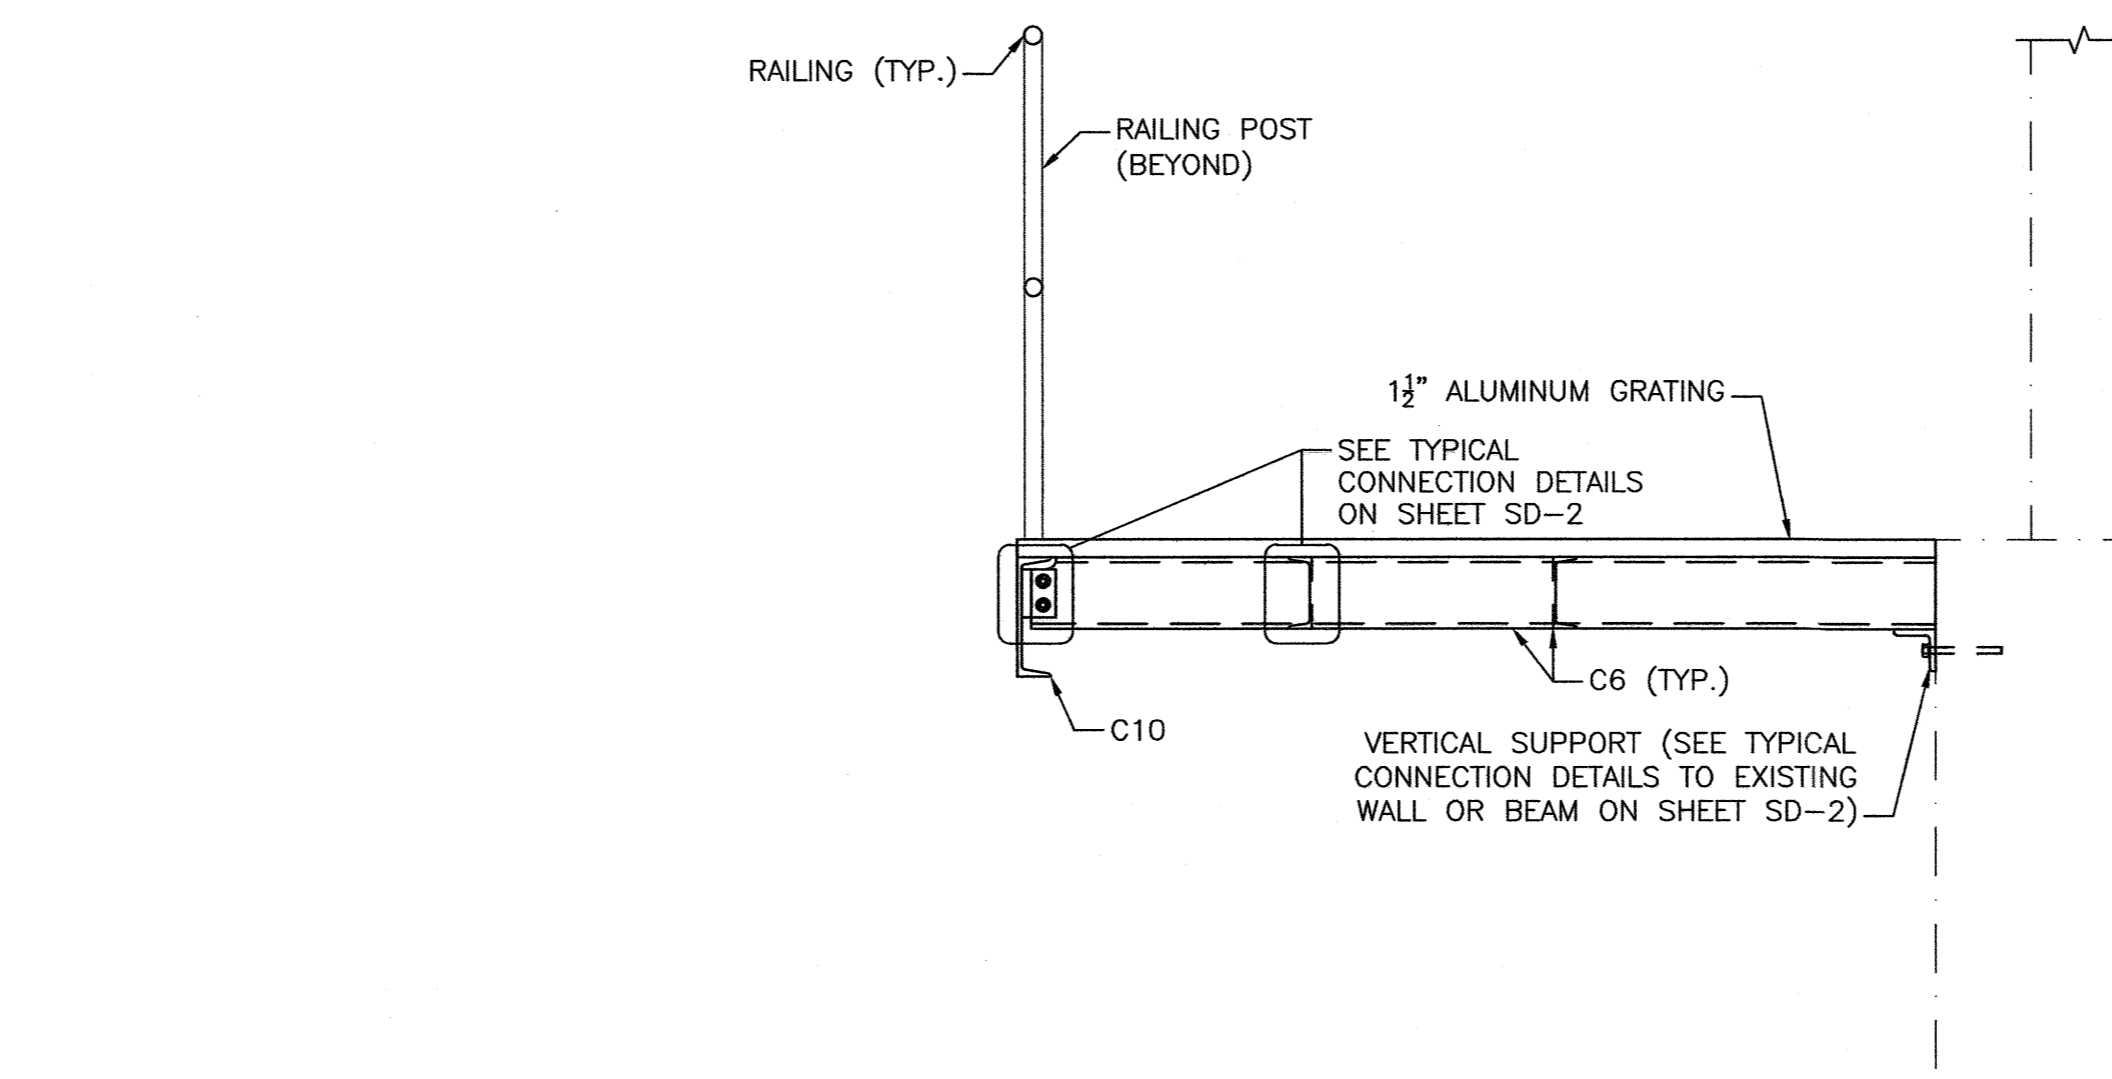

SECTION 2
SCALE: 3/4" = 1'-0"

GENERAL NOTES:

- CONTRACTOR TO FIELD VERIFY ALL DIMENSIONS PRIOR TO THE START OF CONSTRUCTION.
 - LOAD CRITERIA:
UNIFORM LIVE LOAD = 150 PSF
- METAL GRATING NOTES:**
- GRATING, COVER PLATES, ANGLE FRAMES AND SUPPORTS SHALL BE ALL ALUMINIUM CONSTRUCTION UNLESS OTHERWISE NOTED. COVER PLATES SHALL BE DIAMOND PLATE ALUMINIUM ALLOY 6061-T6. GRATING SHALL BE ALUMINIUM ALLOY 6063-T6.
 - FASTENERS, ANCHORS, BOLTS, NUTS AND WASHERS FOR GRATING, COVER PLATES AND SUPPORTS SHALL BE TYPE 316 STAINLESS STEEL.
 - FIELD VERIFY GRATING SUPPORT LOCATIONS BEFORE FABRICATING GRATING, AT TRENCHES 12" OR LESS PROVIDE 1"X3" GRATING WITH SUPPORTS AT 3'-0" ON CENTER. PLATE SUPPORTS WITH EXTREME CARE TO PROVIDE TOLERANCES SHOWN OR SPECIFIED.
 - GRATING PANEL LAYOUT SHALL PROVIDE FOR THE REMOVAL OF GRATING AROUND PIPE AND OTHER GRATING PENETRATIONS.
 - BAND ALL GRATING ALONG EDGES AND AROUND OPENINGS WITH CONTINUOUS BAR SAME DEPTH & THICKNESS AS BEARING BARS.
 - ALL ANGLE FRAMES FOR GRATING AND COVER PLATES ARE TO BE MITERED AND WELDED AT CORNERS.
 - ALL GRATING IS TO BE SECURELY FASTENED TO SUPPORTS, UNLESS OTHERWISE NOTED.
 - ALL COVER PLATES SHALL BE SECURELY FASTENED TO SUPPORTS WITH 3/8" STAINLESS STEEL FLAT-HEAD MACHINE SCREWS AT 2'-0" ON CENTER, UNLESS OTHERWISE NOTED.
 - ANY ADDITIONAL GRATING SUPPORTS SHALL BE ALUMINIUM, DESIGNED BY THE CONTRACTOR AND SHOWN ON THE GRATING PANEL LAYOUT.
 - COAT ALL ALUMINIUM IN DIRECT CONTACT WITH CONCRETE WITH A BITUMASTIC COATING.
 - CONTRACTOR TO COORDINATE OPENINGS WITH THE EQUIPMENT MANUFACTURER.

ALUMINUM FRAMING NOTES:

- ALL ALUMINIUM STOCK SHALL BE 6061-T6.
- WELDS SHALL USE 5556 FILLER ALLOY.
- BOLTS, NUTS, AND WASHERS SHALL BE 316 STAINLESS STEEL.

PREPARED BY



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REGISTERED PROFESSIONAL

CHRISTOPHER W. JONES



REGISTERED PROFESSIONAL ENGINEER STRUCTURAL

SUBCONSULTANT

PROJECT

**BURRILLVILLE WWTF
HEADWORKS &
OAKLAND PUMP
STATION
IMPROVEMENTS**

BURRILLVILLE, RI

TITLE

**STRUCTURAL
DETAILS - I**

NO.	REVISIONS	DATE

DRAWN BY: DW

DESIGNED BY: PJK/DW

CHECKED BY: CWJ

ISSUE DATE: MAY 2023

BETA JOB NO.: 6861-105

SCALE


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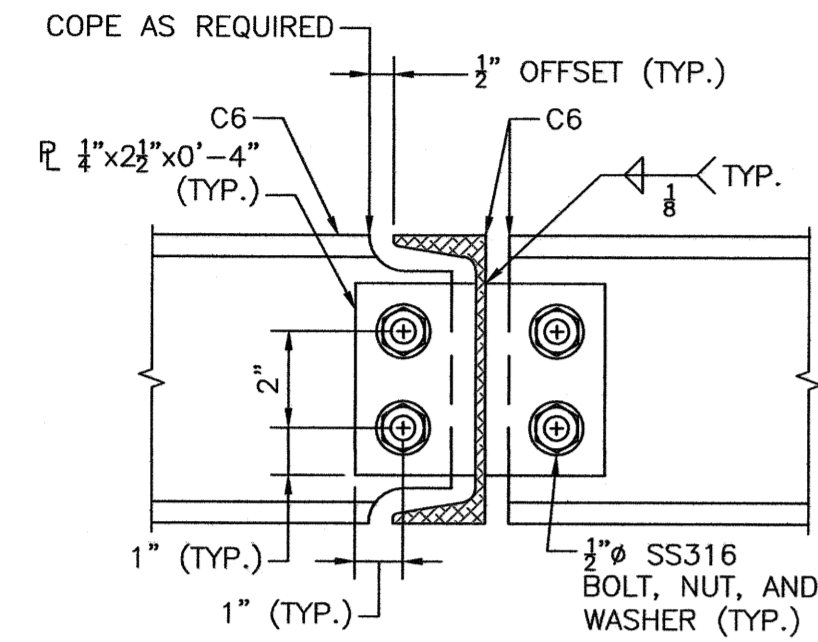
SD-1

\\BETA-INC.COM\BRIEVIEW\BURRILLVILLE\WTF - HEADWORKS IMPROVEMENTS\CADD\DRAWING\FILES\PLANS\STRUCTURAL-DETAILS.DWG 5/15/2023




NOTE: CROSS MEMBERS SCREENED FOR CLARITY.

TOP VIEW

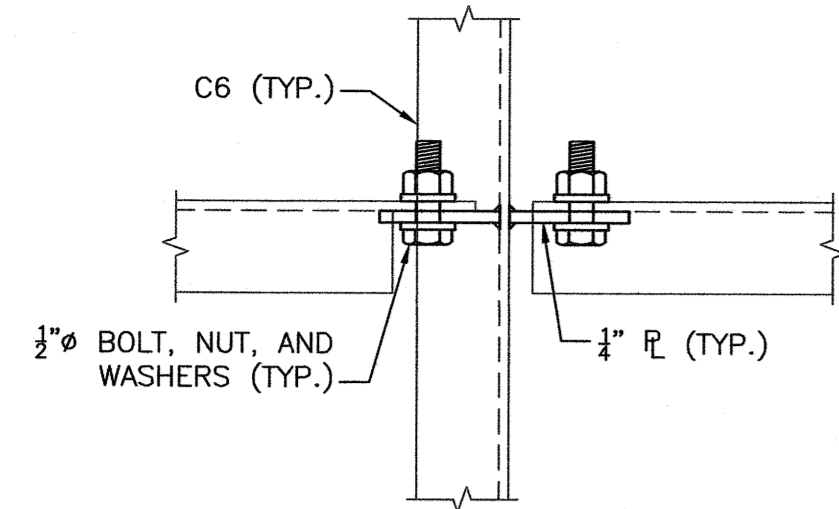


SIDE VIEW
[C6 TO C6]

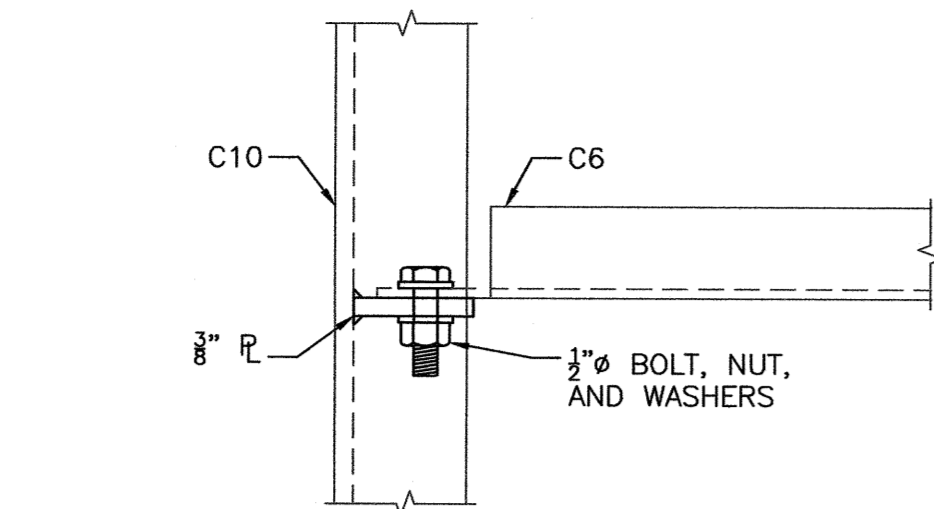

NOTE: CROSS MEMBERS SCREENED FOR CLARITY.


TOP VIEW

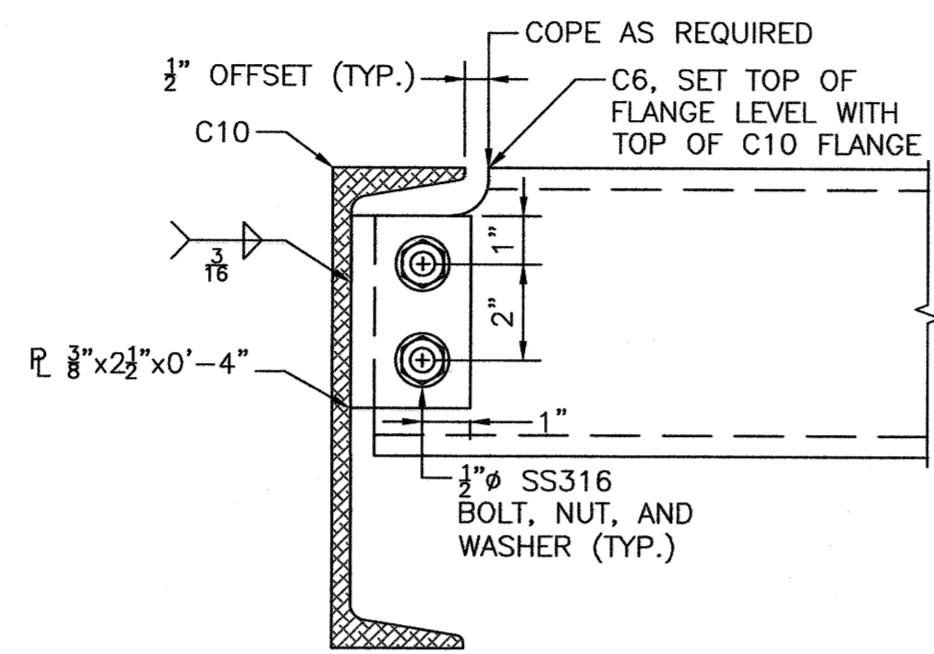


SIDE VIEW
[C6 TO C10]

TYPICAL CONNECTION DETAILS


SCALE: 3" = 1'-0"

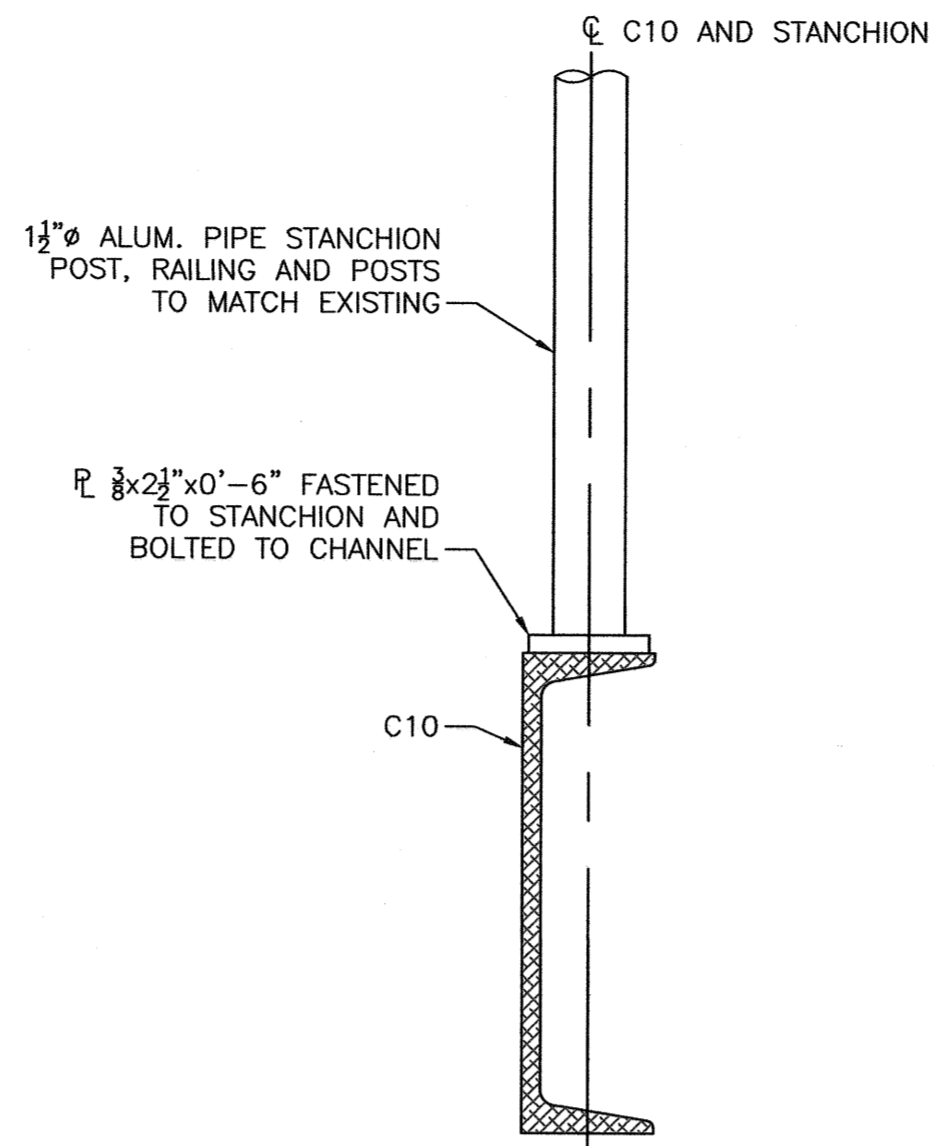

SIDE VIEW
[RAILING POST TO C10]

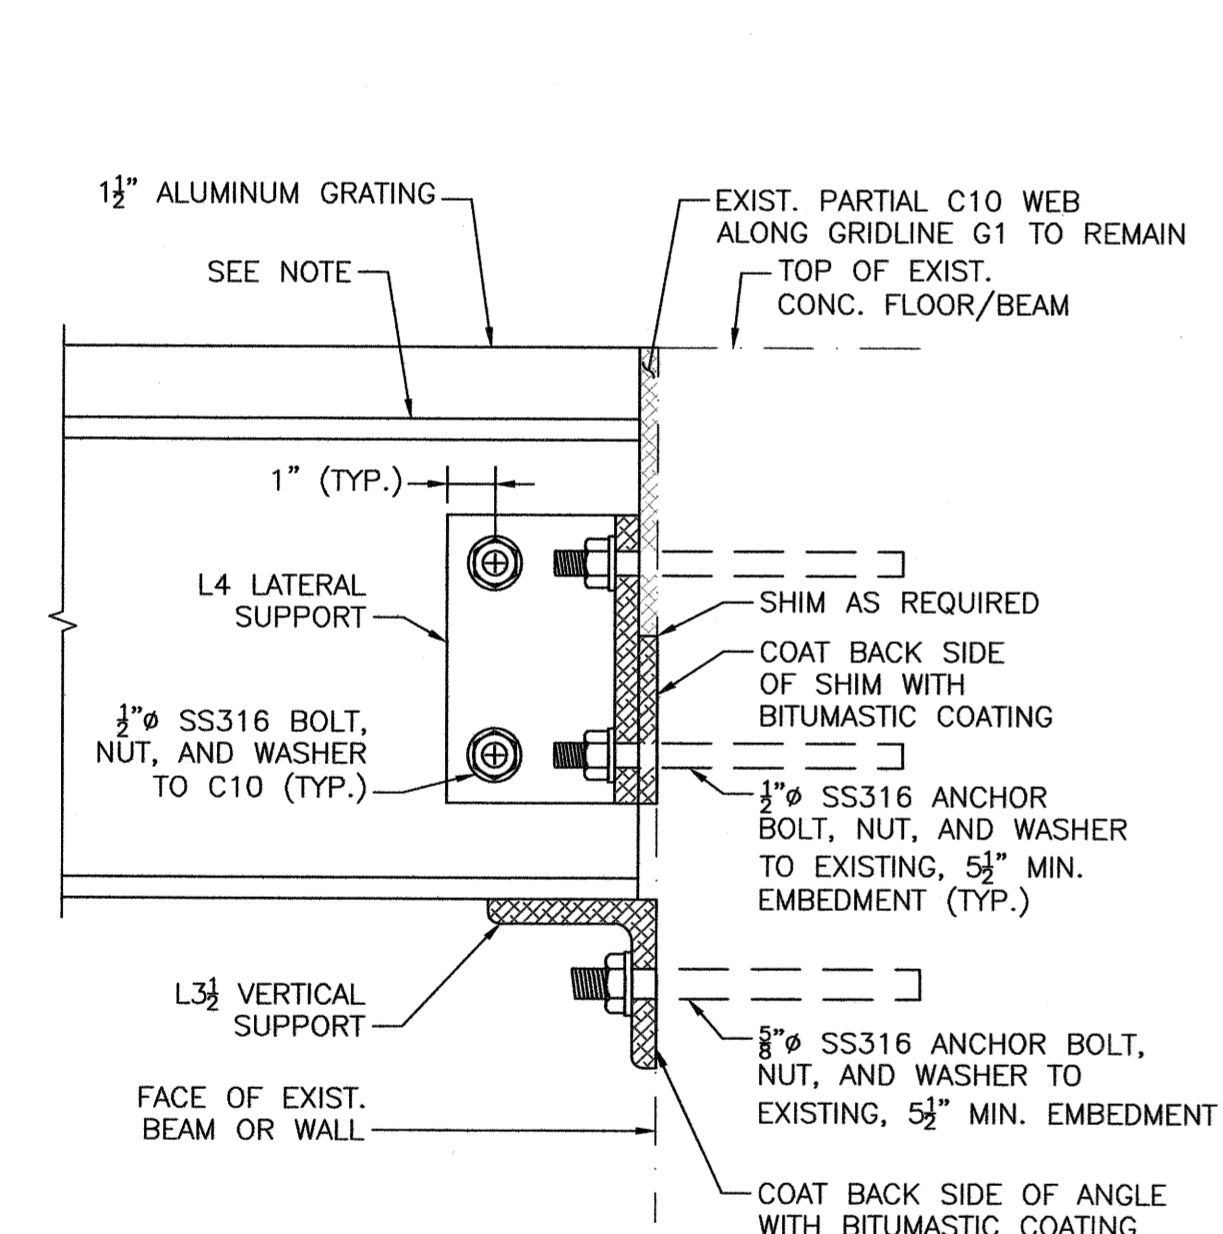

SECTION 3
[VERTICAL AND LATERAL SUPPORTS]

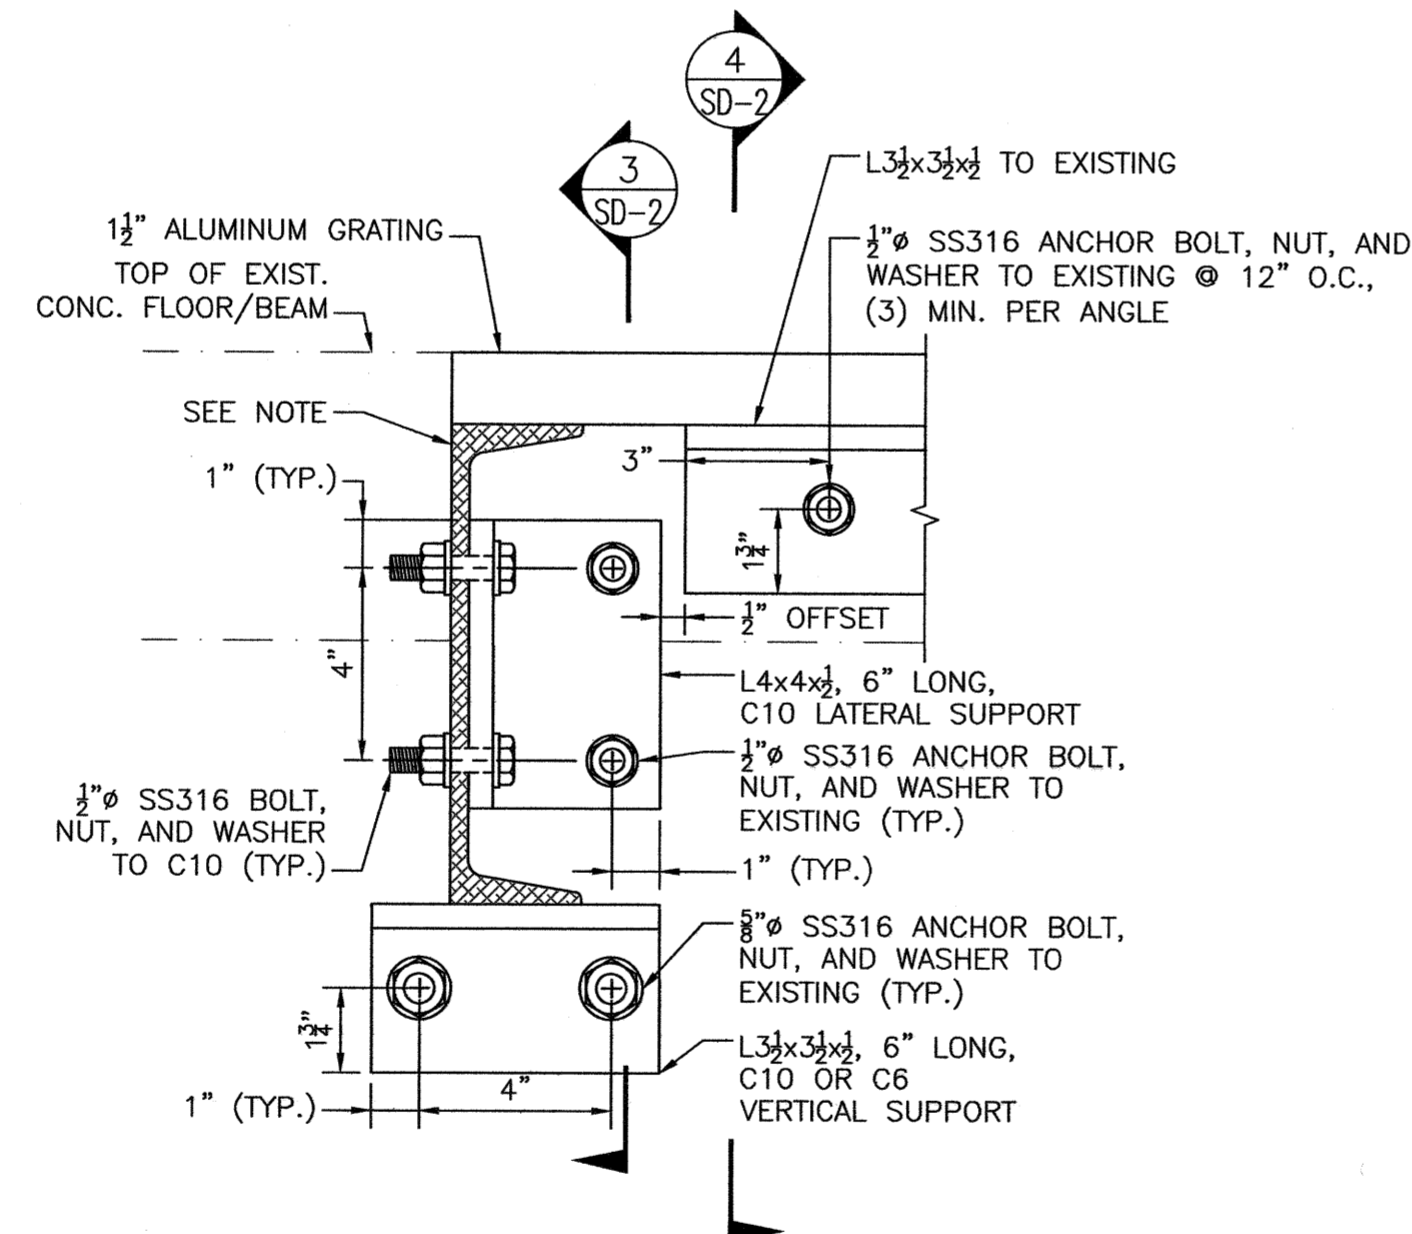


SECTION 4
[GENERAL]


NOTE:
C10 SHOWN, C6 SIMILAR. OMIT LATERAL SUPPORT AT C6.

TYPICAL CONNECTION DETAILS TO EXISTING BEAM OR WALL

SCALE: 3" = 1'-0"

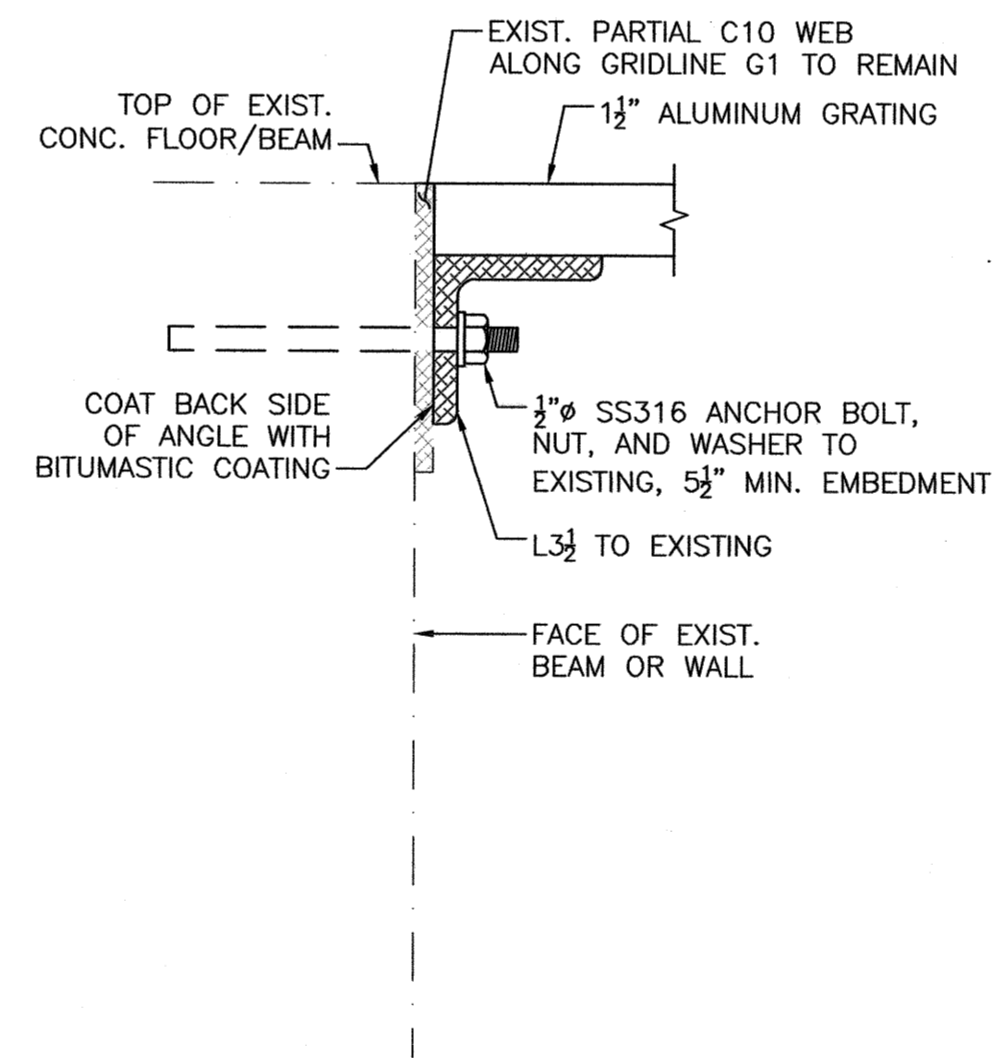


SECTION 5
[L3/2 TO BEAM OR WALL]

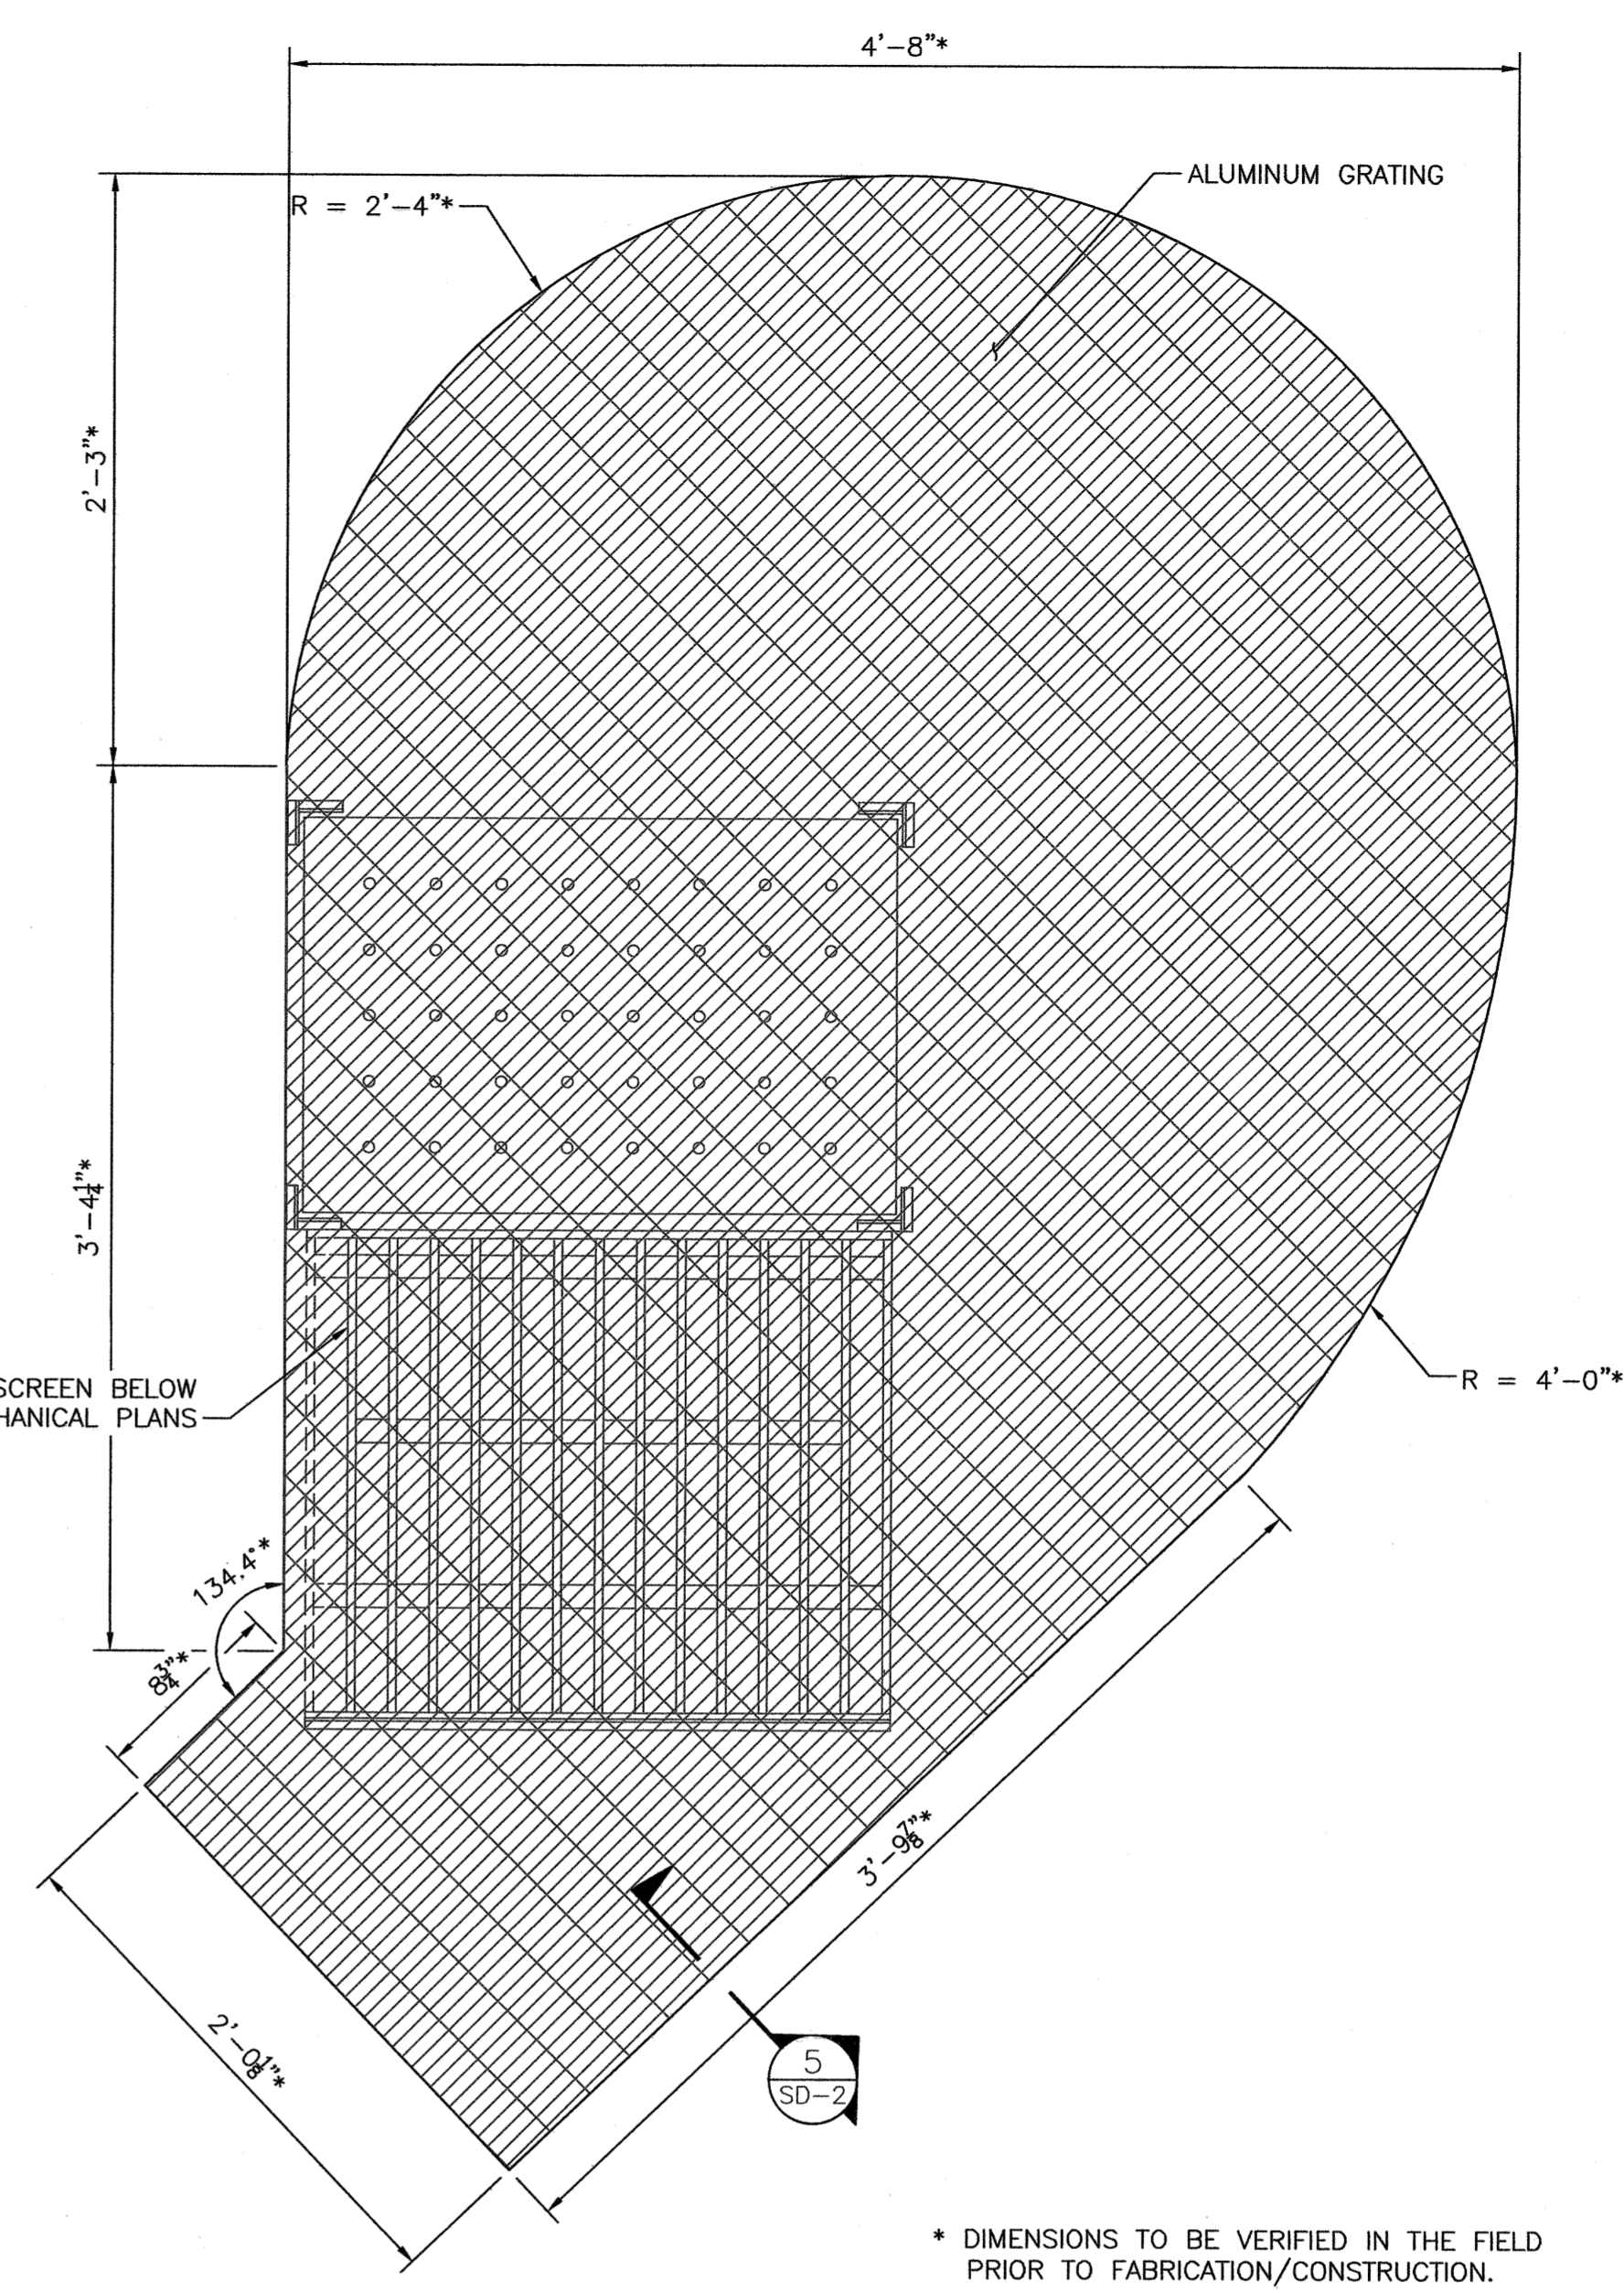

BAR RACK GRATING

SCALE: 1 1/2" = 1'-0"

* DIMENSIONS TO BE VERIFIED IN THE FIELD PRIOR TO FABRICATION/CONSTRUCTION.

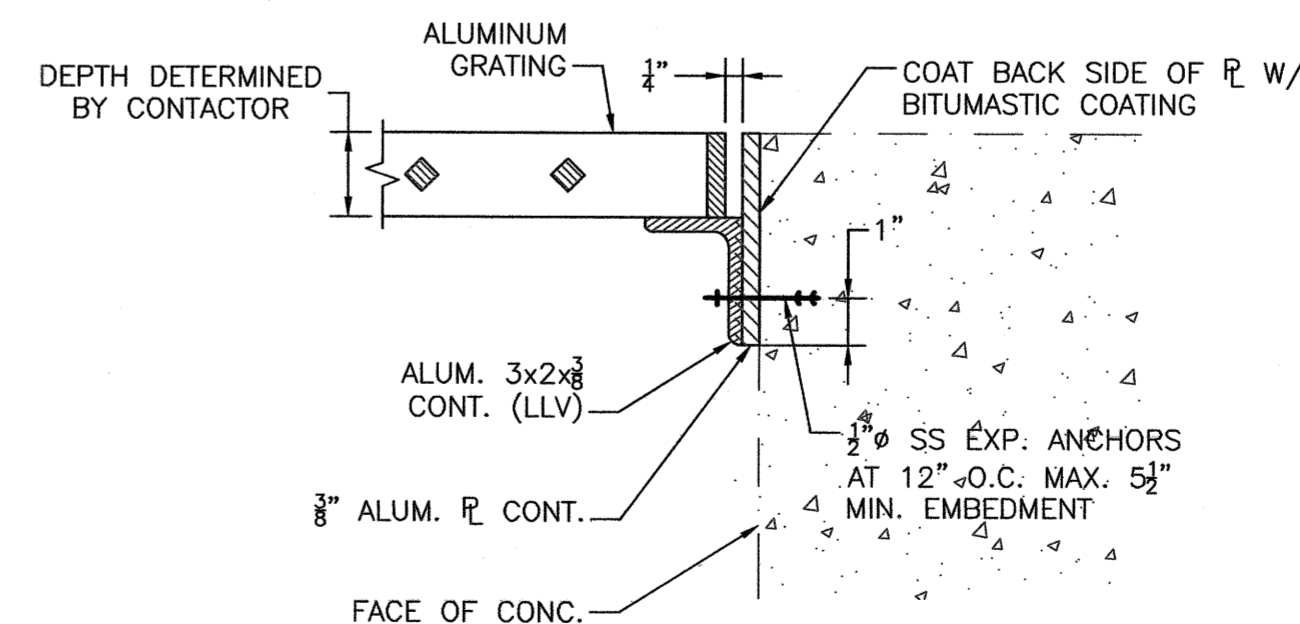


SECTION 5

NOT TO SCALE

PREPARED BY



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SUBCONSULTANT

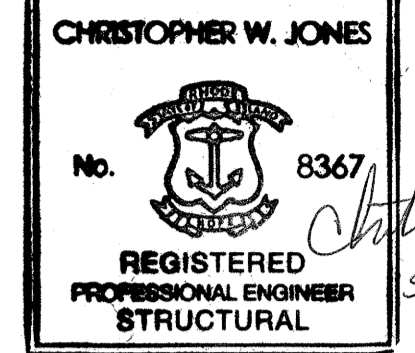PROJECT

BURRILLVILLE WWTF HEADWORKS & OAKLAND PUMP STATION IMPROVEMENTS

BURRILLVILLE, RI

TITLE

STRUCTURAL DETAILS - II

NO. REVISIONS DATE

DRAWN BY: DW
DESIGNED BY: PJK/DW
CHECKED BY: CWJ
ISSUE DATE: MAY 2023
BETA JOB NO.: 6861-105


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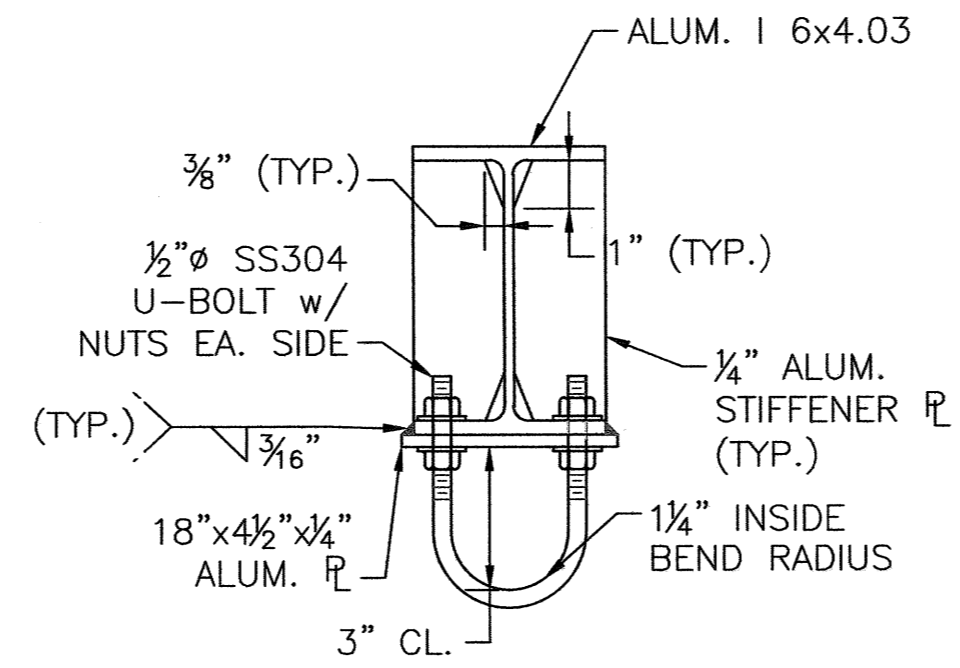
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SHEET NO.


SD-2




[TYPICAL CONNECTION AT HOIST BEAM - 2 REQ'D]
HOIST FRAME ELEVATION
SCALE: 3" = 1'-0"

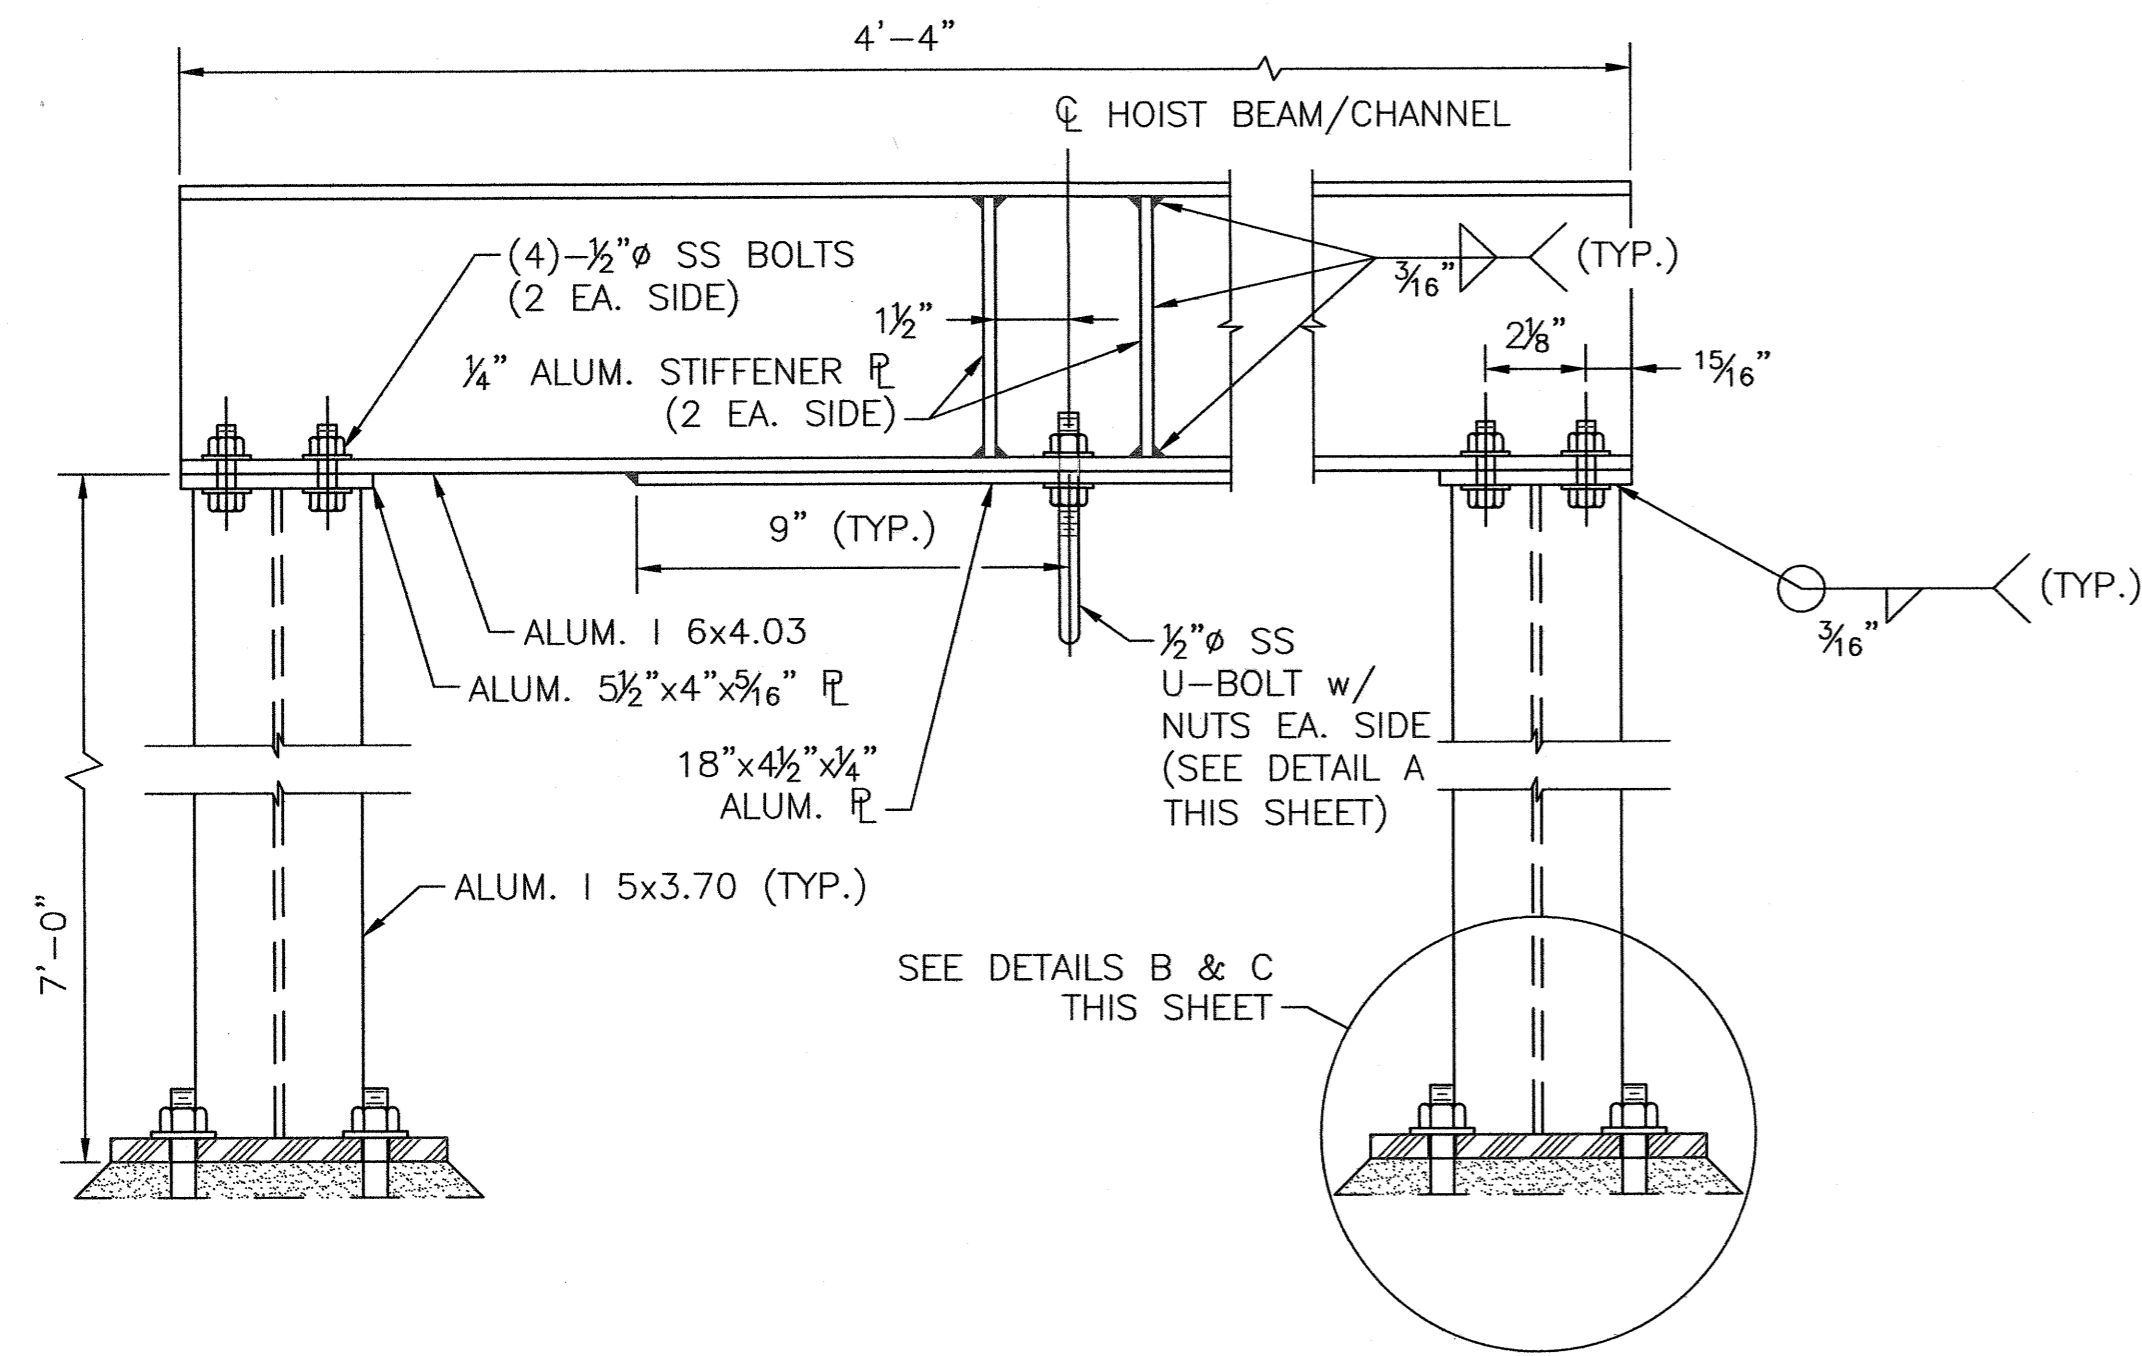

[LIFT HOOK AT BAR SCREEN]
DETAIL A
SCALE: 3" = 1'-0"

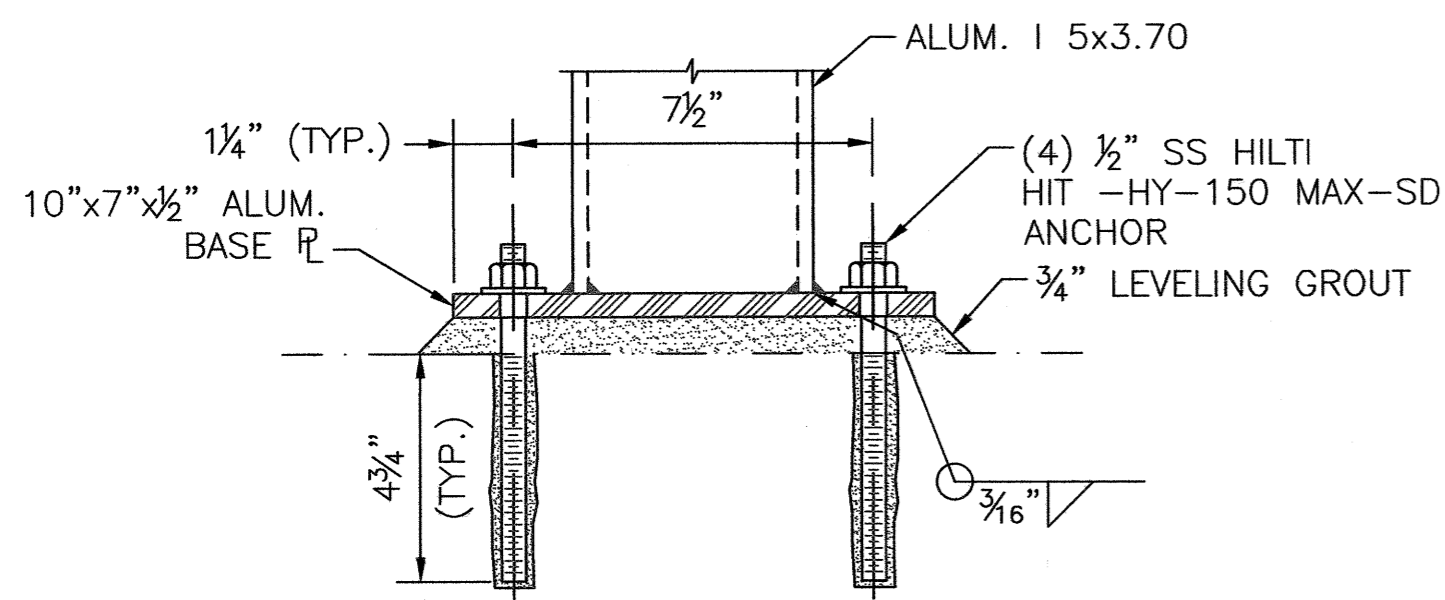

[TYPICAL BASE PLATE SECTION FOR HOIST COLUMN]
DETAIL B
SCALE: 3" = 1'-0"

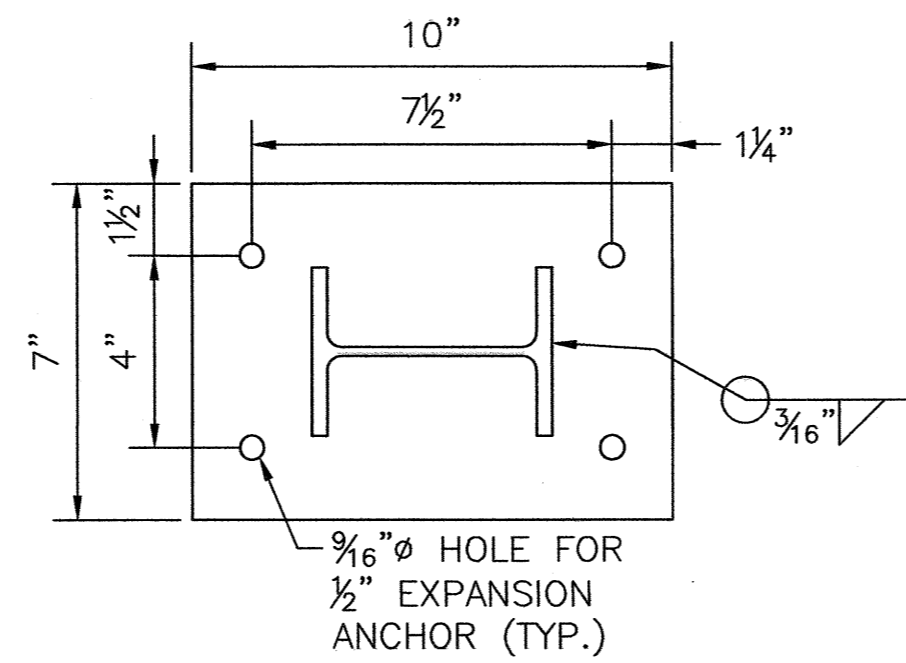

[TYPICAL BASE PLATE PLAN FOR HOIST COLUMN - 4 REQ'D]
DETAIL C
SCALE: 3" = 1'-0"


ALUMINUM HOIST NOTES:

1. ALL ALUMINUM STOCK SHALL BE 6061-T6.
2. WELDS SHALL USE 5556 FILLER ALLOY.
3. BOLTS, NUTS, AND WASHERS SHALL BE STAINLESS STEEL 316.

PREPARED BY



REGISTERED PROFESSIONAL

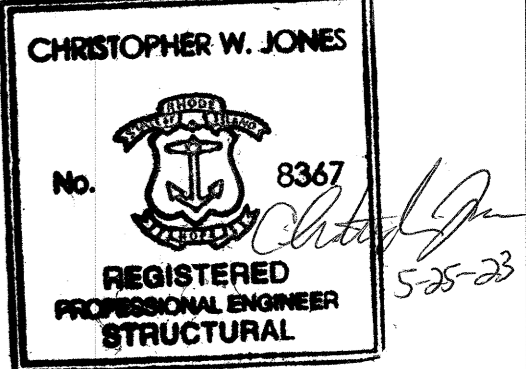

SUBCONSULTANT

PROJECT

BURRILLVILLE WWT HEADWORKS & OAKLAND PUMP STATION IMPROVEMENTS

BURRILLVILLE, RI

TITLE

STRUCTURAL DETAILS - III

NO. REVISIONS DATE

DRAWN BY: DW

DESIGNED BY: PJK/DW

CHECKED BY: CWJ

ISSUE DATE: MAY 2023

BETA JOB NO.: 6861-105

SCALE

AS SHOWN

UNLESS OTHERWISE NOTED OR CHANGED BY REPRODUCTION

SHEET NO.

SD-3

MECHANICAL DEMOLITION NOTES:


- ALL DEMOLITION AND REMOVAL OF EXISTING CONSTRUCTION, UTILITIES EQUIPMENT, AND APPURTENANCES SHALL BE ACCOMPLISHED WITHOUT DAMAGING THE INTEGRITY OF EXISTING STRUCTURES, EQUIPMENT, AND APPURTENANCES THAT ARE TO REMAIN. EQUIPMENT DESIGNATED BY THE OWNER TO BE SALVAGED SHALL BE REMOVED AND DELIVERED BY THE CONTRACTOR TO AN AREA AT THE TREATMENT FACILITY, INDICATED BY THE ENGINEER. REFER TO SPECIFICATION SECTION 02050-DEMOLITION.
- ALL DEMOLITION MATERIAL INCLUDING CONCRETE, PIPE, AND BRICK THAT WAS IN CONTACT WITH SEWAGE SHALL BE CLEANED IN ACCORDANCE WITH RIDEM REQUIREMENTS AND DISPOSED OF ACCORDINGLY. ONCE CLEANED, DEMOLITION MATERIALS SHALL NOT BE CONSIDERED SPECIAL WASTE.
- MATERIALS TO BE REMOVED THAT ARE NOT DESIGNATED TO BE SALVAGED SHALL BECOME THE PROPERTY OF THE CONTRACTOR AND SHALL BE REMOVED OFF-SITE AND DISPOSED OF AT THE CONTRACTORS' EXPENSE.
- THE CONTRACTOR IS RESPONSIBLE FOR THE LEGAL AND PROPER DISPOSAL OF ALL DEMOLITION MATERIAL ACCORDING TO ANY RELEVANT LAWS OF THE STATE OF RHODE ISLAND.
- ADDITIONAL DEMOLITION WORK IS SHOWN ON THE STRUCTURAL, PLUMBING, H&V, I&C, AND ELECTRICAL DRAWINGS.
- ALL REQUIRED DEMOLITION WORK SHALL BE DONE ACCORDING TO THE SEQUENCE OF OPERATIONS PLAN SUBMITTED BY THE CONTRACTOR AND APPROVED BY THE ENGINEER.
- PLANS OF THE EXISTING HEADWORKS FACILITY WERE BASED ON THE EXISTING DRAWINGS. THE DRAWINGS SHOW OVERALL DIMENSIONS OF THE STRUCTURE, AND THE LOCATION OF MAJOR EQUIPMENT AND PIPING. MISCELLANEOUS EQUIPMENT, PIPING, CONCRETE EQUIPMENT PADS, PIPE SUPPORTS, AND MATERIALS ARE NOT NECESSARILY SHOWN BUT ARE INCLUDED IN THE DEMOLITION. THE CONTRACTOR SHALL INSPECT THE HEADWORKS FACILITY DURING THE BIDDING PHASE OF THE PROJECT TO FAMILIARIZE THEMSELVES WITH THE EXTENT OF THE DEMOLITION WORK REQUIRED.

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PROJECT

**BURRILLVILLE WWTF
HEADWORKS &
OAKLAND PUMP
STATION
IMPROVEMENTS**

BURRILLVILLE, RI

TITLE

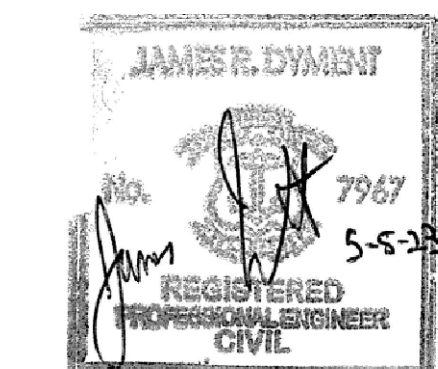**HEADWORKS -
DEMOLITION
PLANS - I**

NO.	REVISIONS	DATE

DRAWN BY:	CJM
DESIGNED BY:	AJG
CHECKED BY:	JRD
ISSUE DATE:	MAY 2023
BETA JOB NO.:	6861-105


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UNLESS OTHERWISE NOTED OR CHANGED BY REPRODUCTION


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SHEET NO. **M-1.1**

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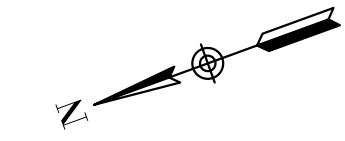


FIRST FLOOR PLAN - DEMOLITION
SCALE: 1/4" = 1'-0"

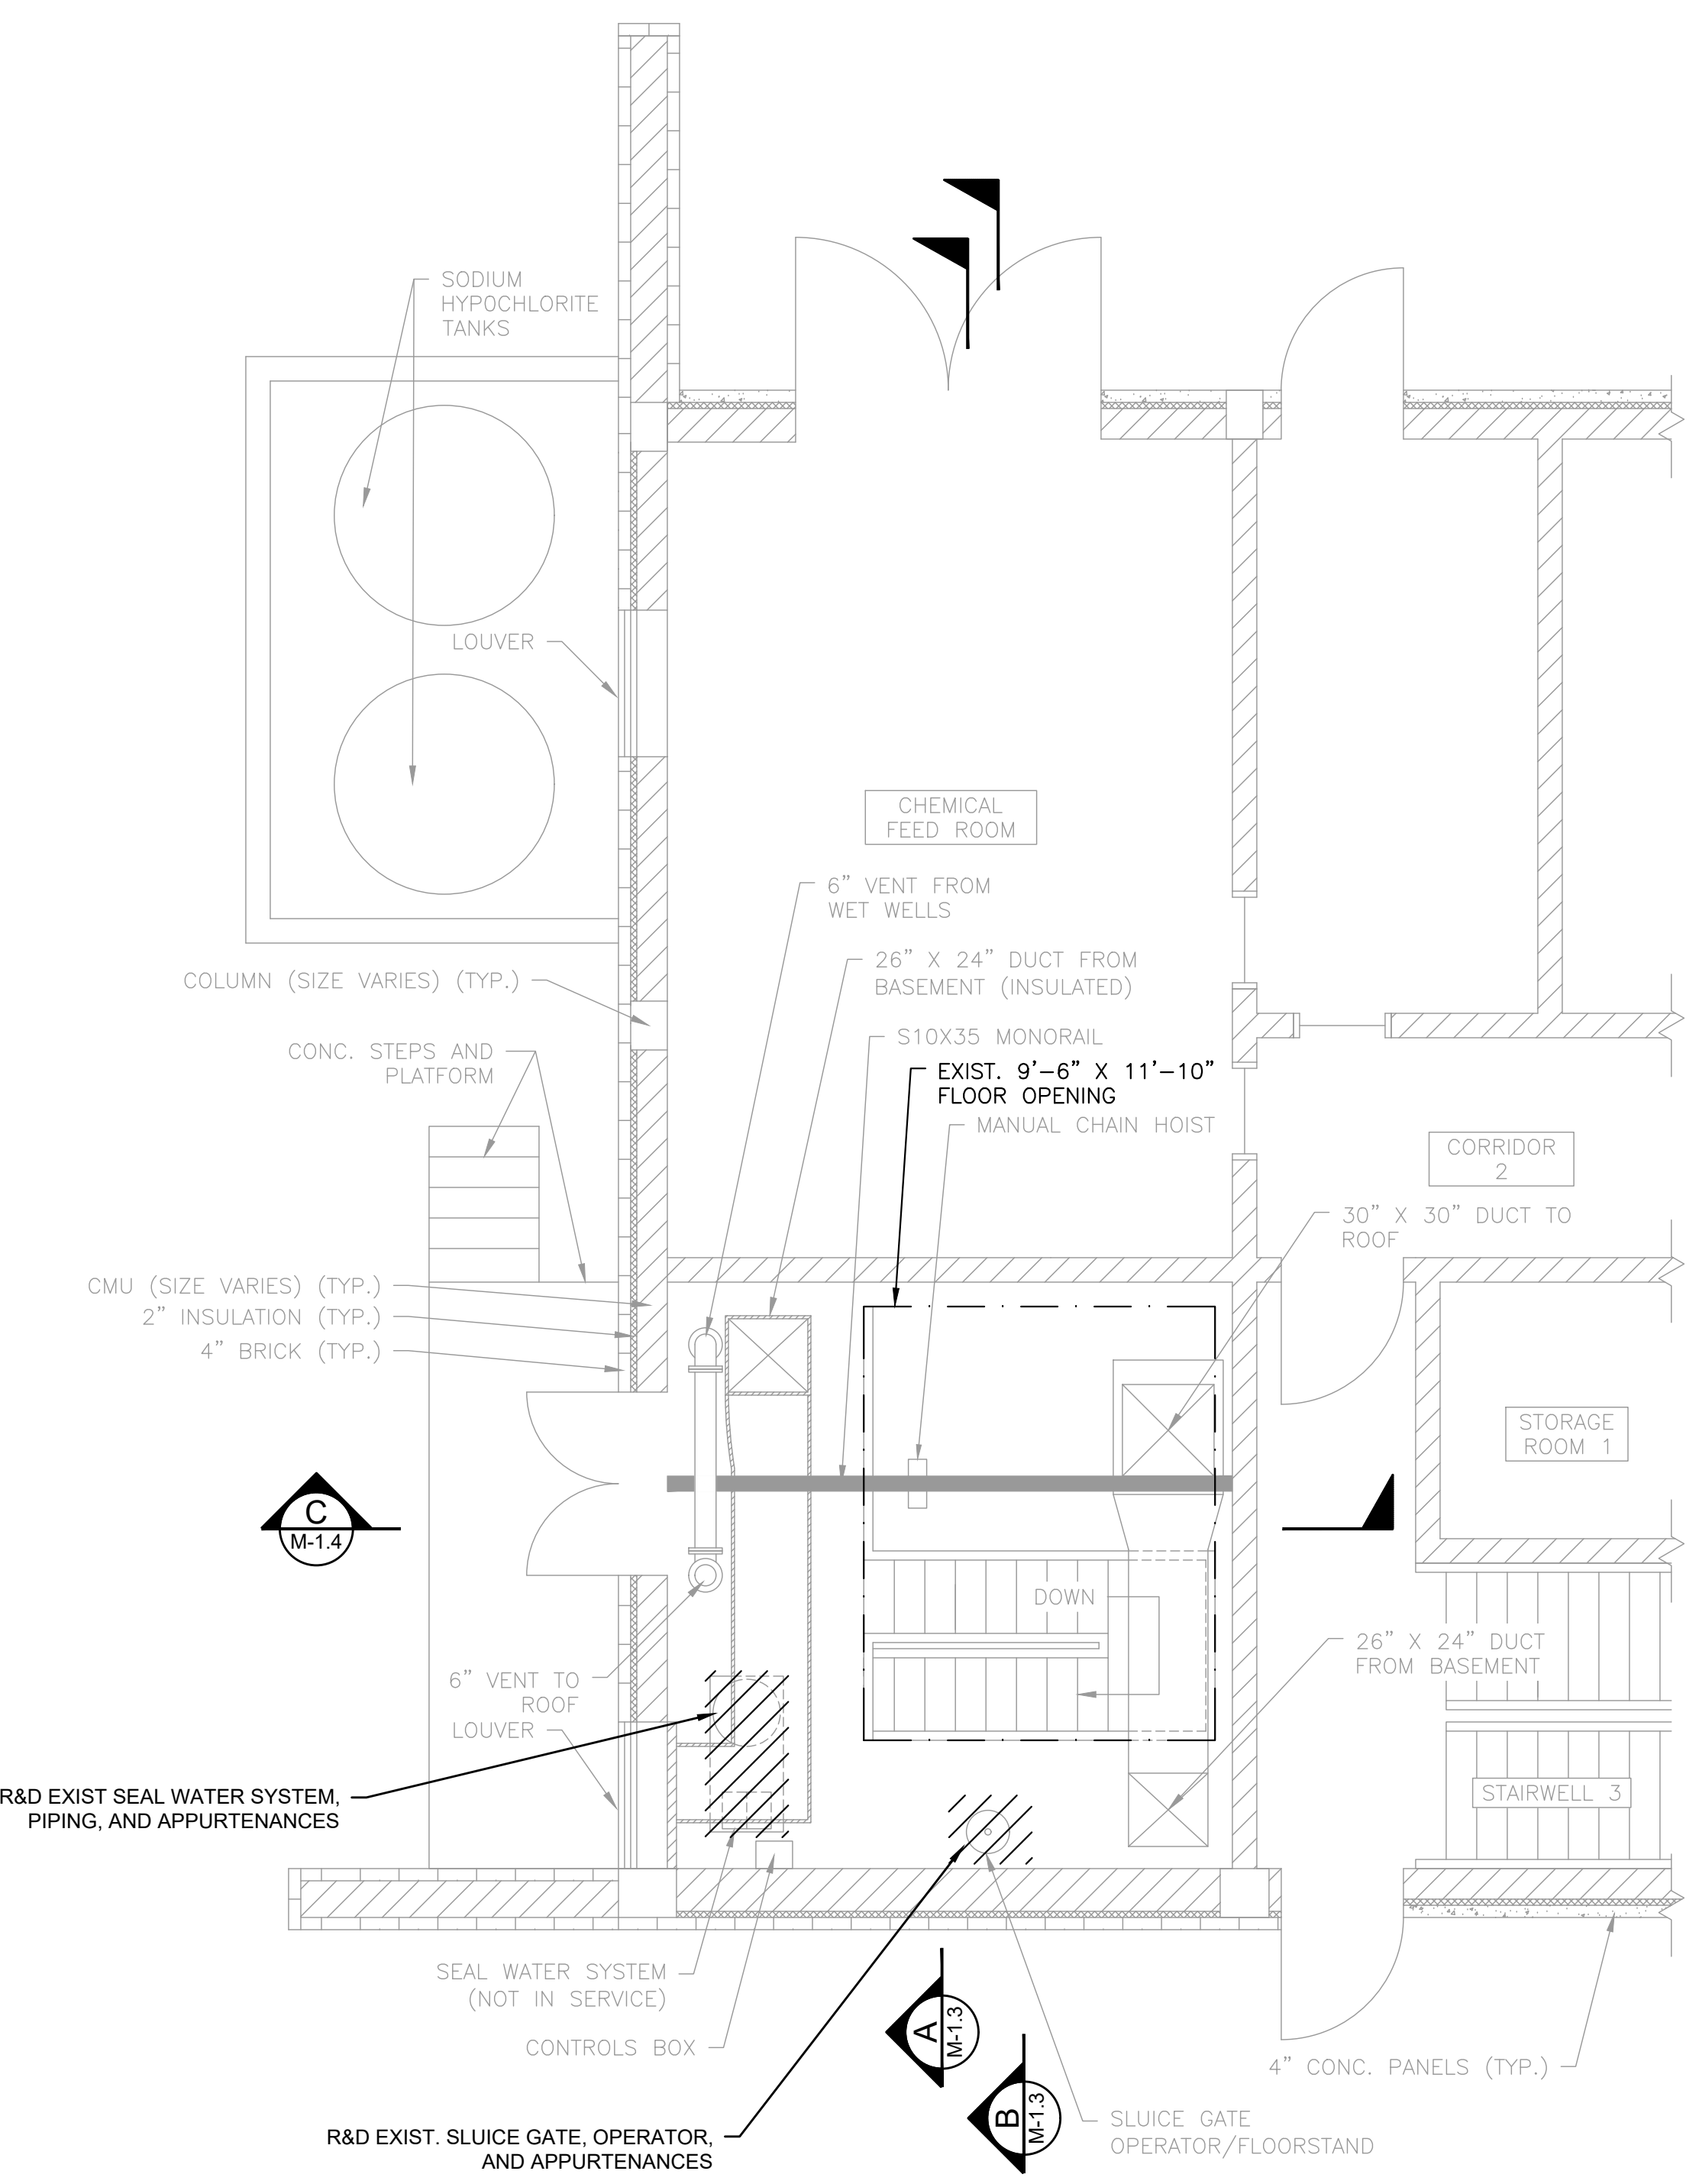

BASEMENT PLAN - DEMOLITION
SCALE: 1/4" = 1'-0"

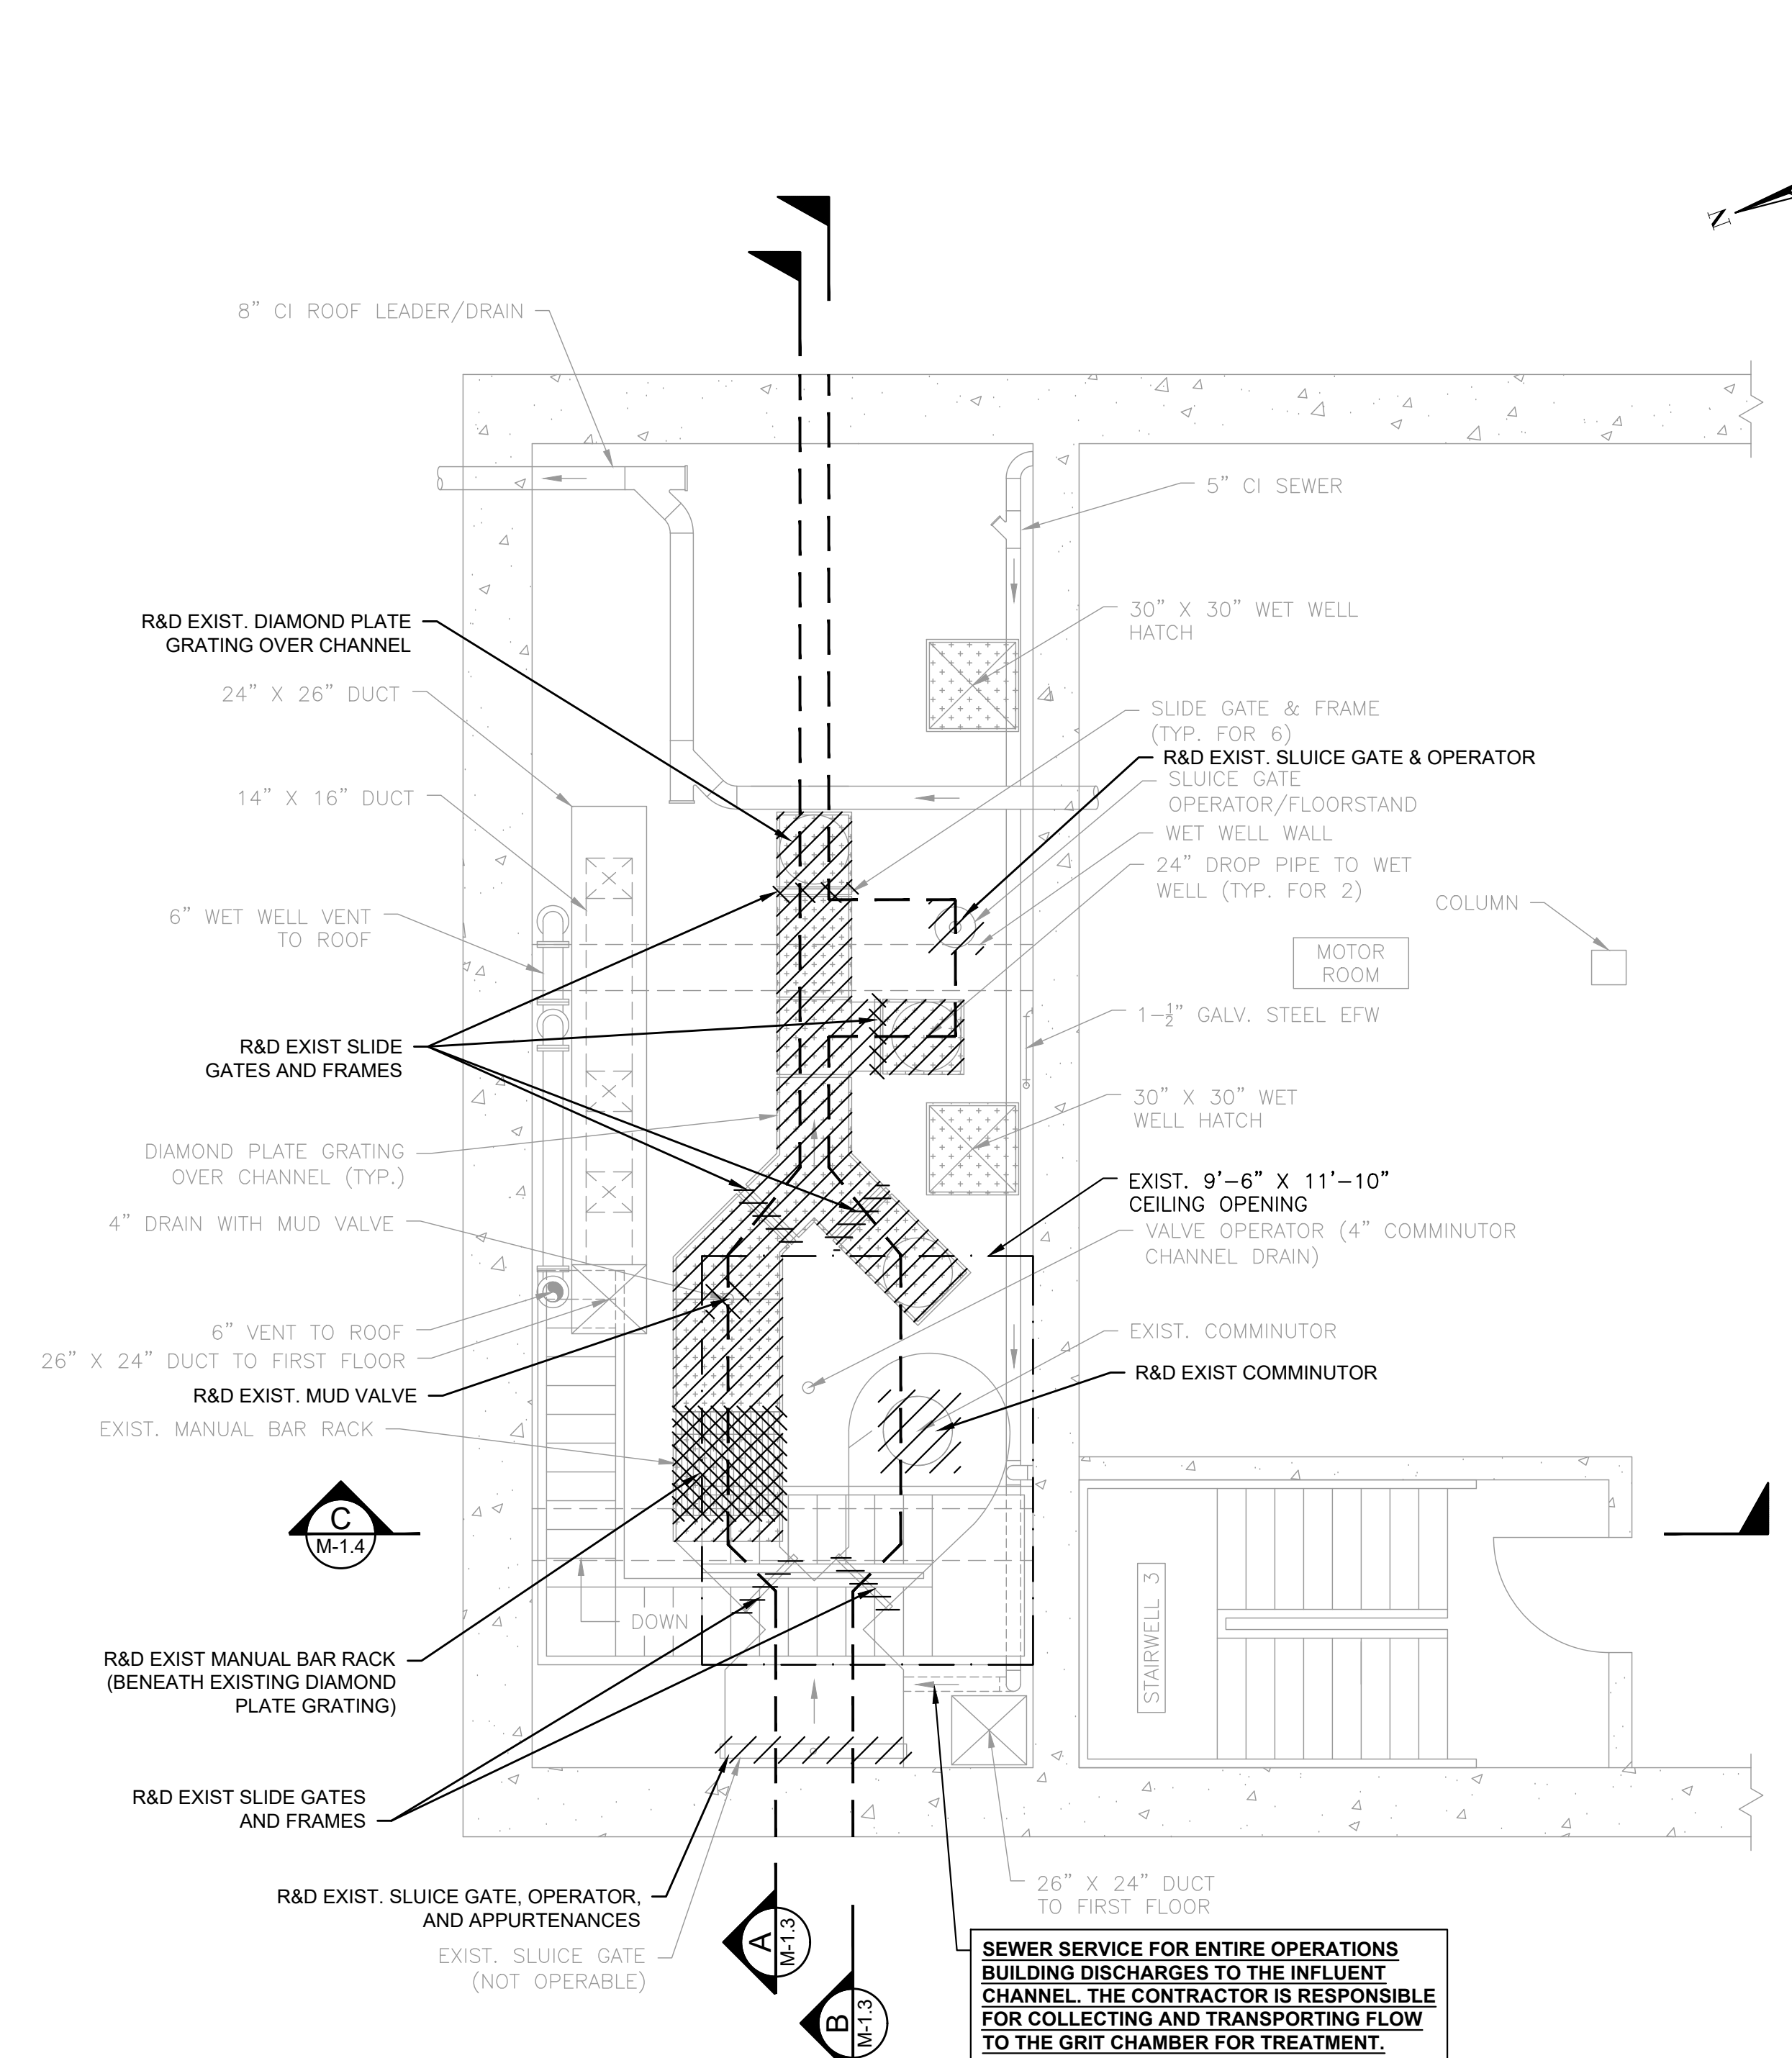
SEWER SERVICE FOR ENTIRE OPERATIONS BUILDING DISCHARGES TO THE INFLUENT CHANNEL. THE CONTRACTOR IS RESPONSIBLE FOR COLLECTING AND TRANSPORTING FLOW TO THE GRIT CHAMBER FOR TREATMENT.



PREPARED BY



REGISTERED PROFESSIONAL

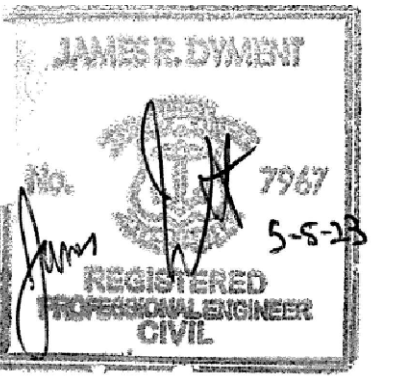

SUBCONSULTANT

PROJECT

**BURRILLVILLE WWTF
HEADWORKS &
OAKLAND PUMP
STATION
IMPROVEMENTS**

BURRILLVILLE, RI

TITLE

**HEADWORKS -
DEMOLITION
PLANS - II**

NO. REVISIONS DATE

DRAWN BY: CJM

DESIGNED BY: AJG

CHECKED BY: JRD

ISSUE DATE: MAY 2023

BETA JOB NO.: 6861-105

SCALE




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SHEET NO.

M-1.2




SUB-BASEMENT PLAN - DEMOLITION
SCALE: 1/4" = 1'-0"

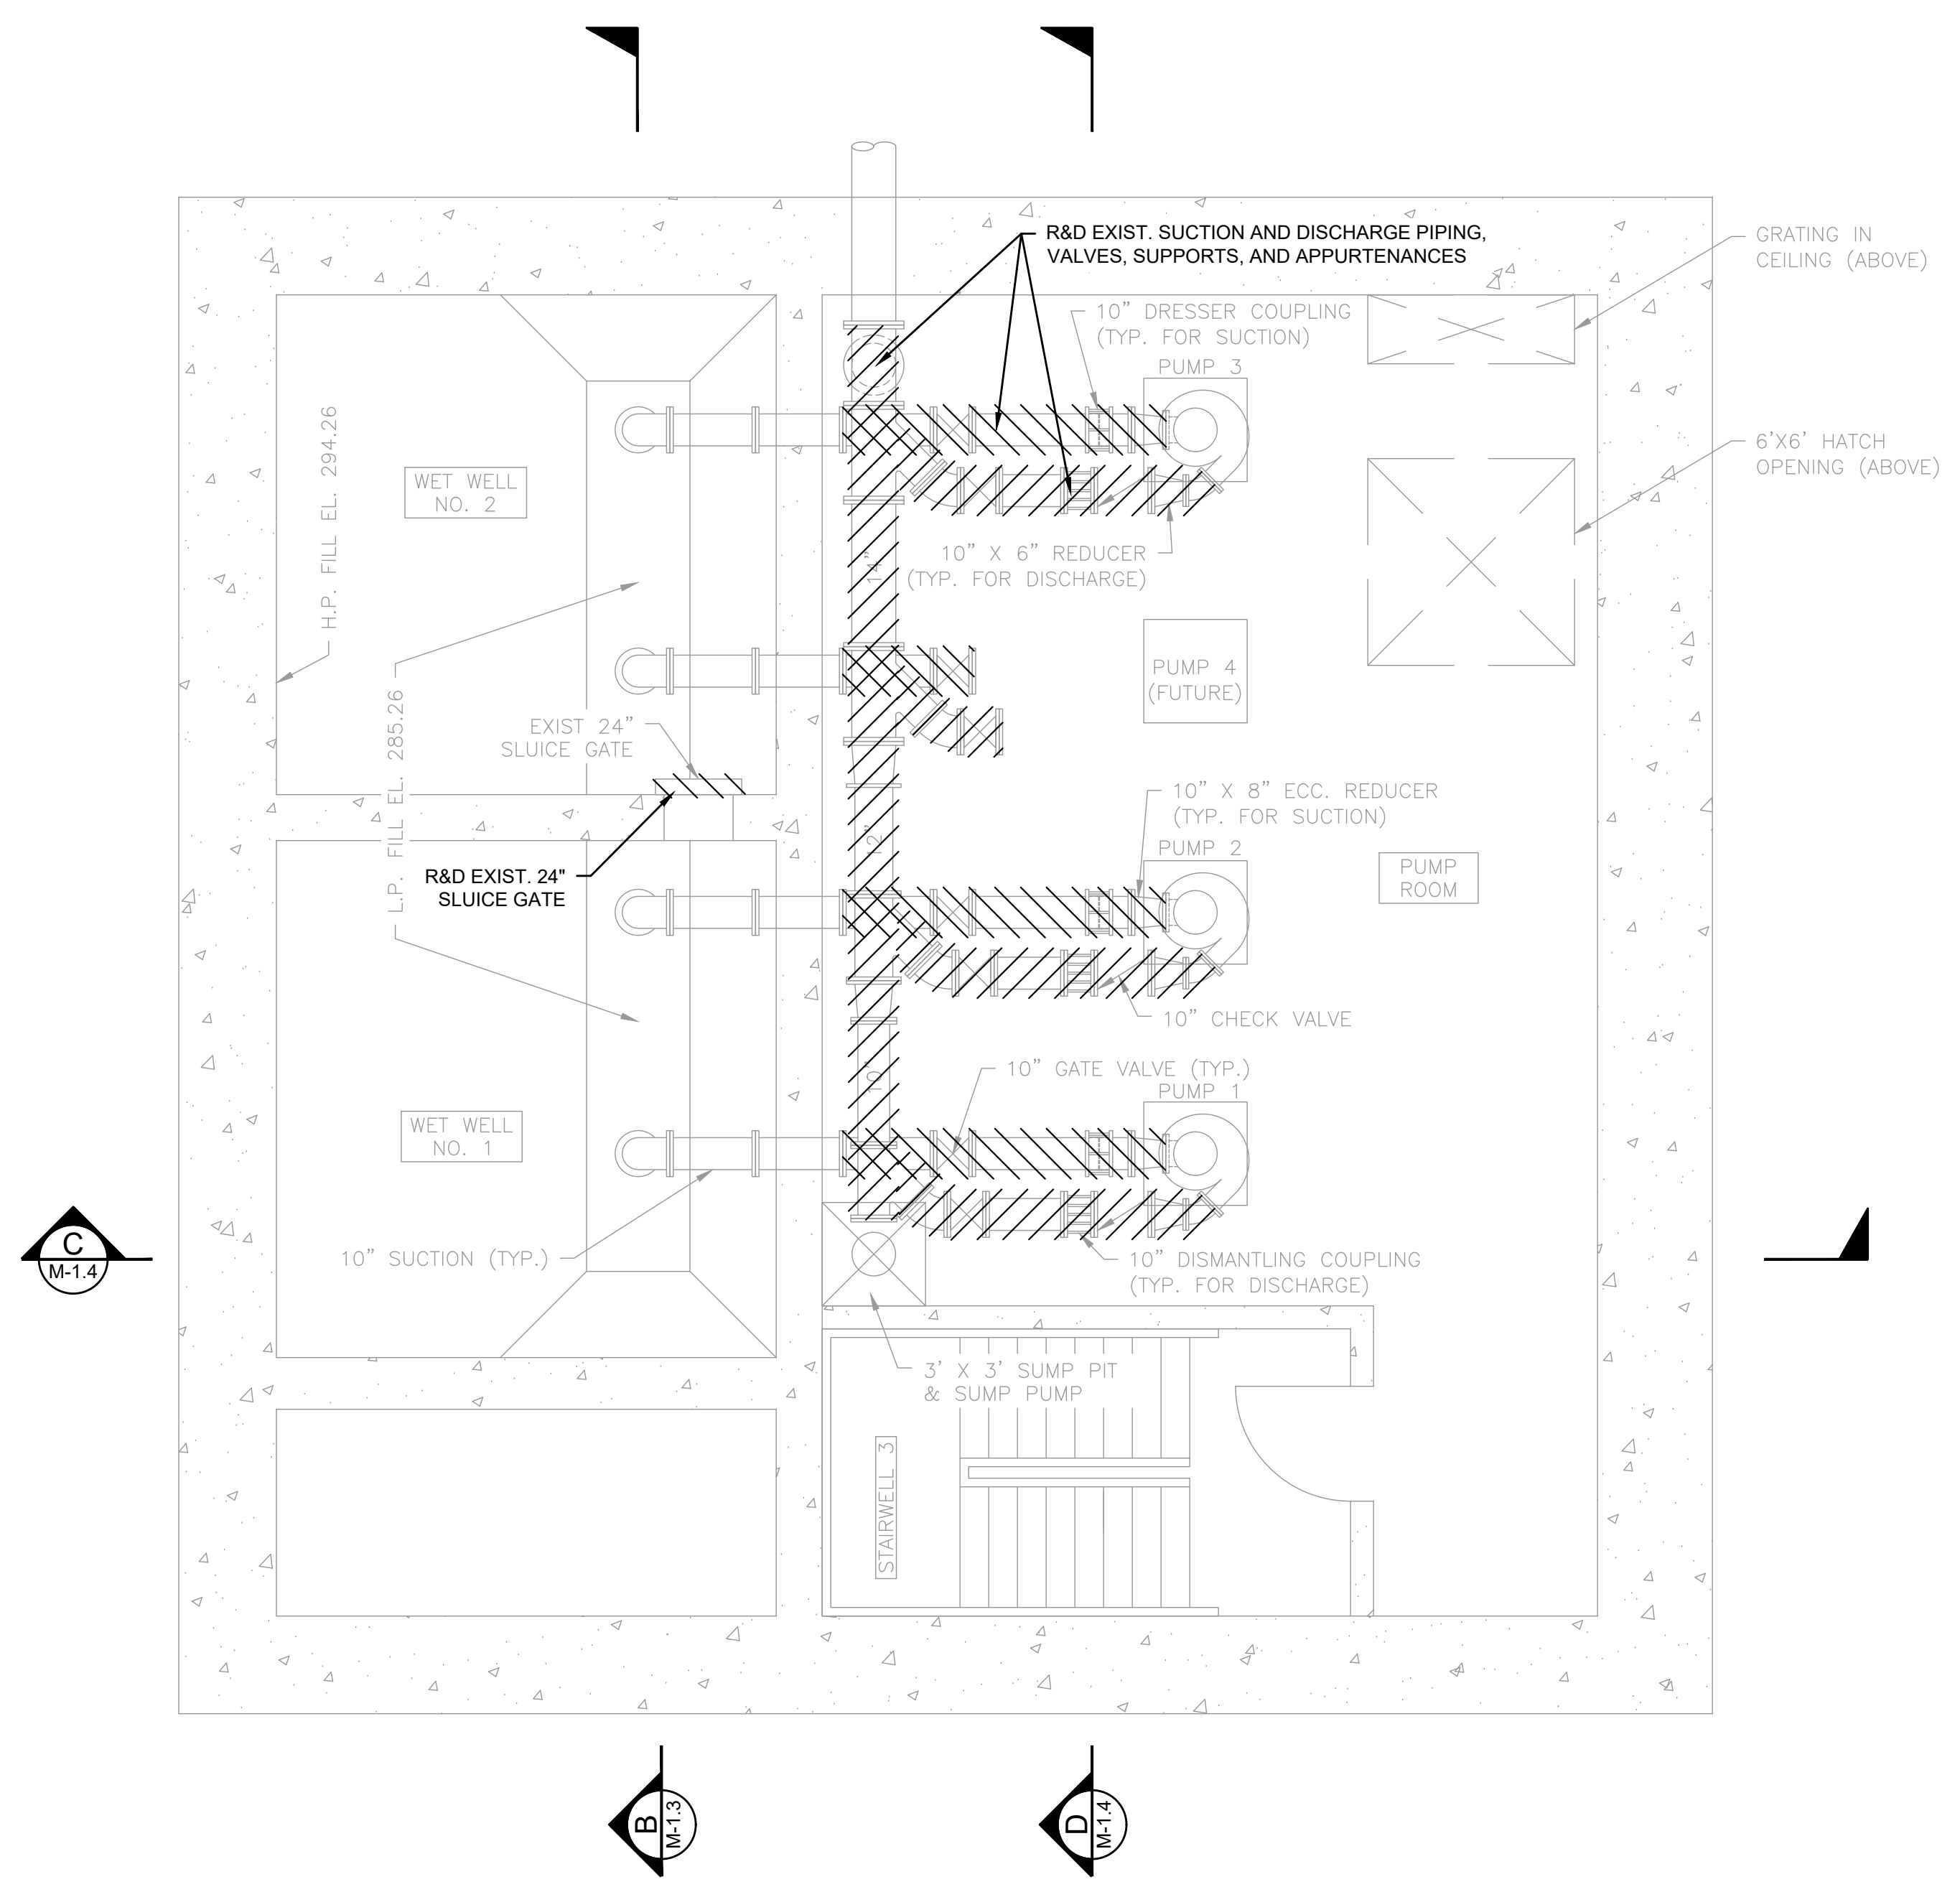
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5/16/2023

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5/16/2023

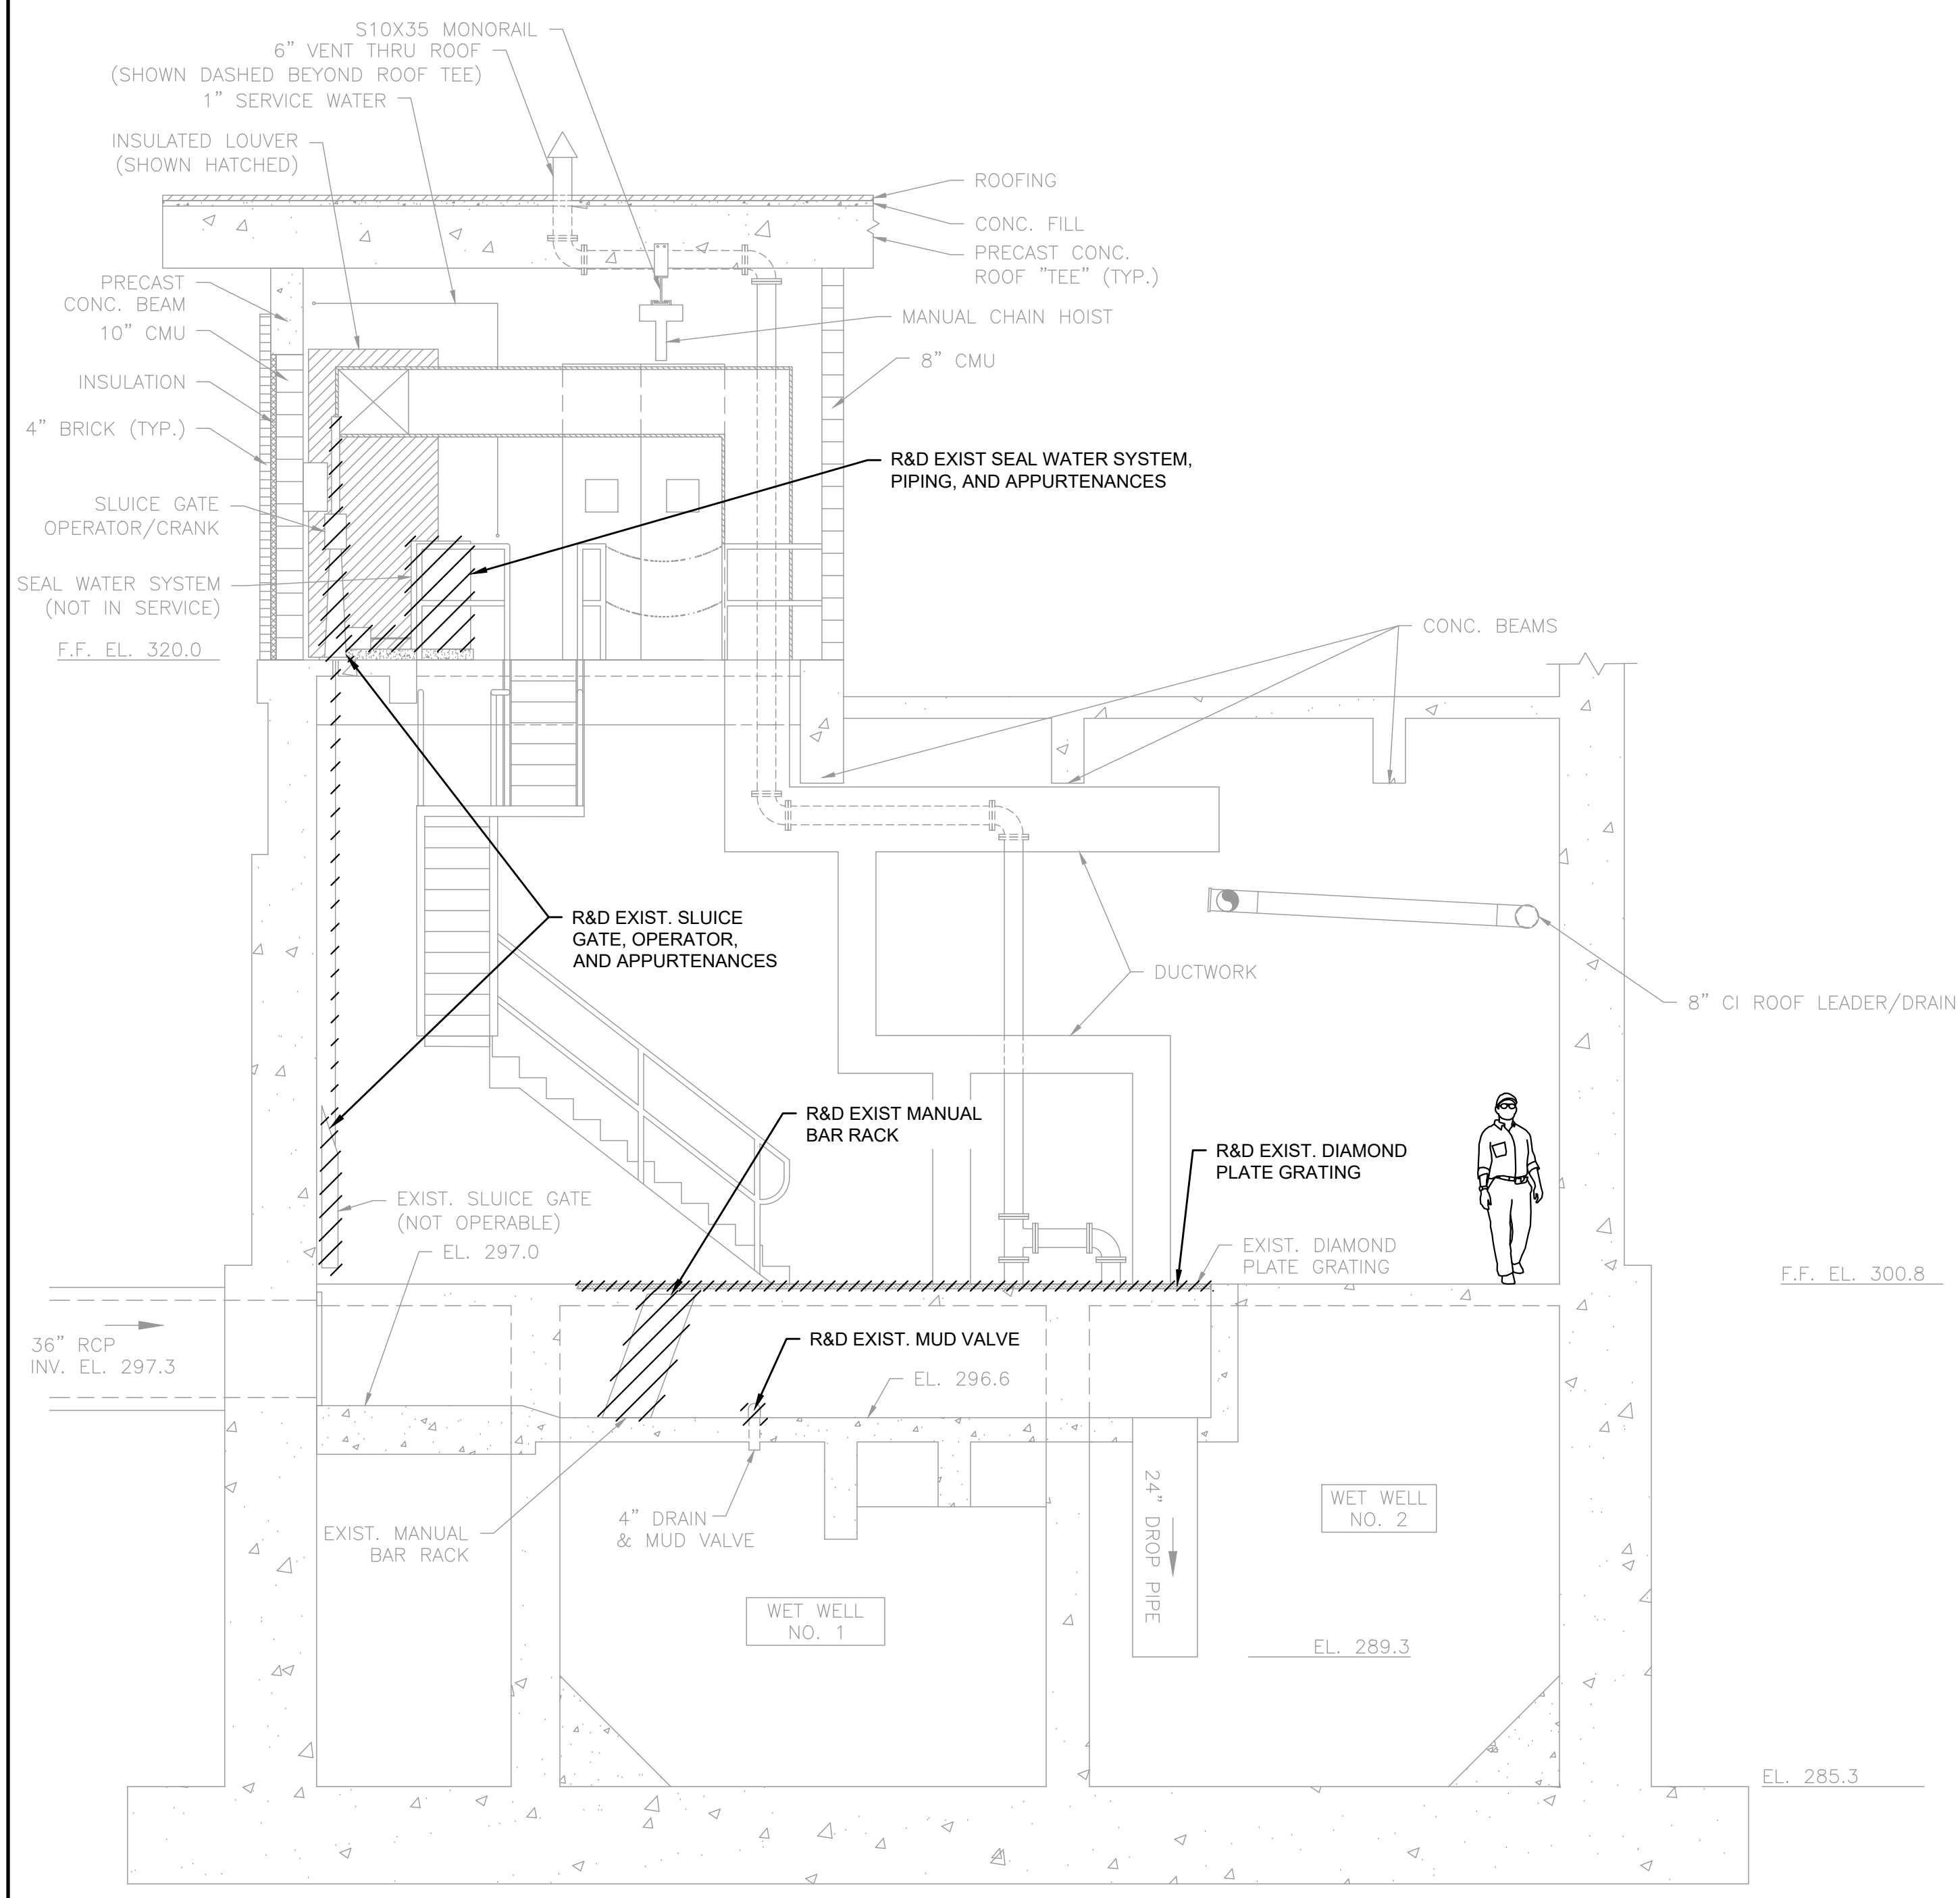


DEMOLITION SECTION A
SCALE: 1/4" = 1'-0"
M-1.1

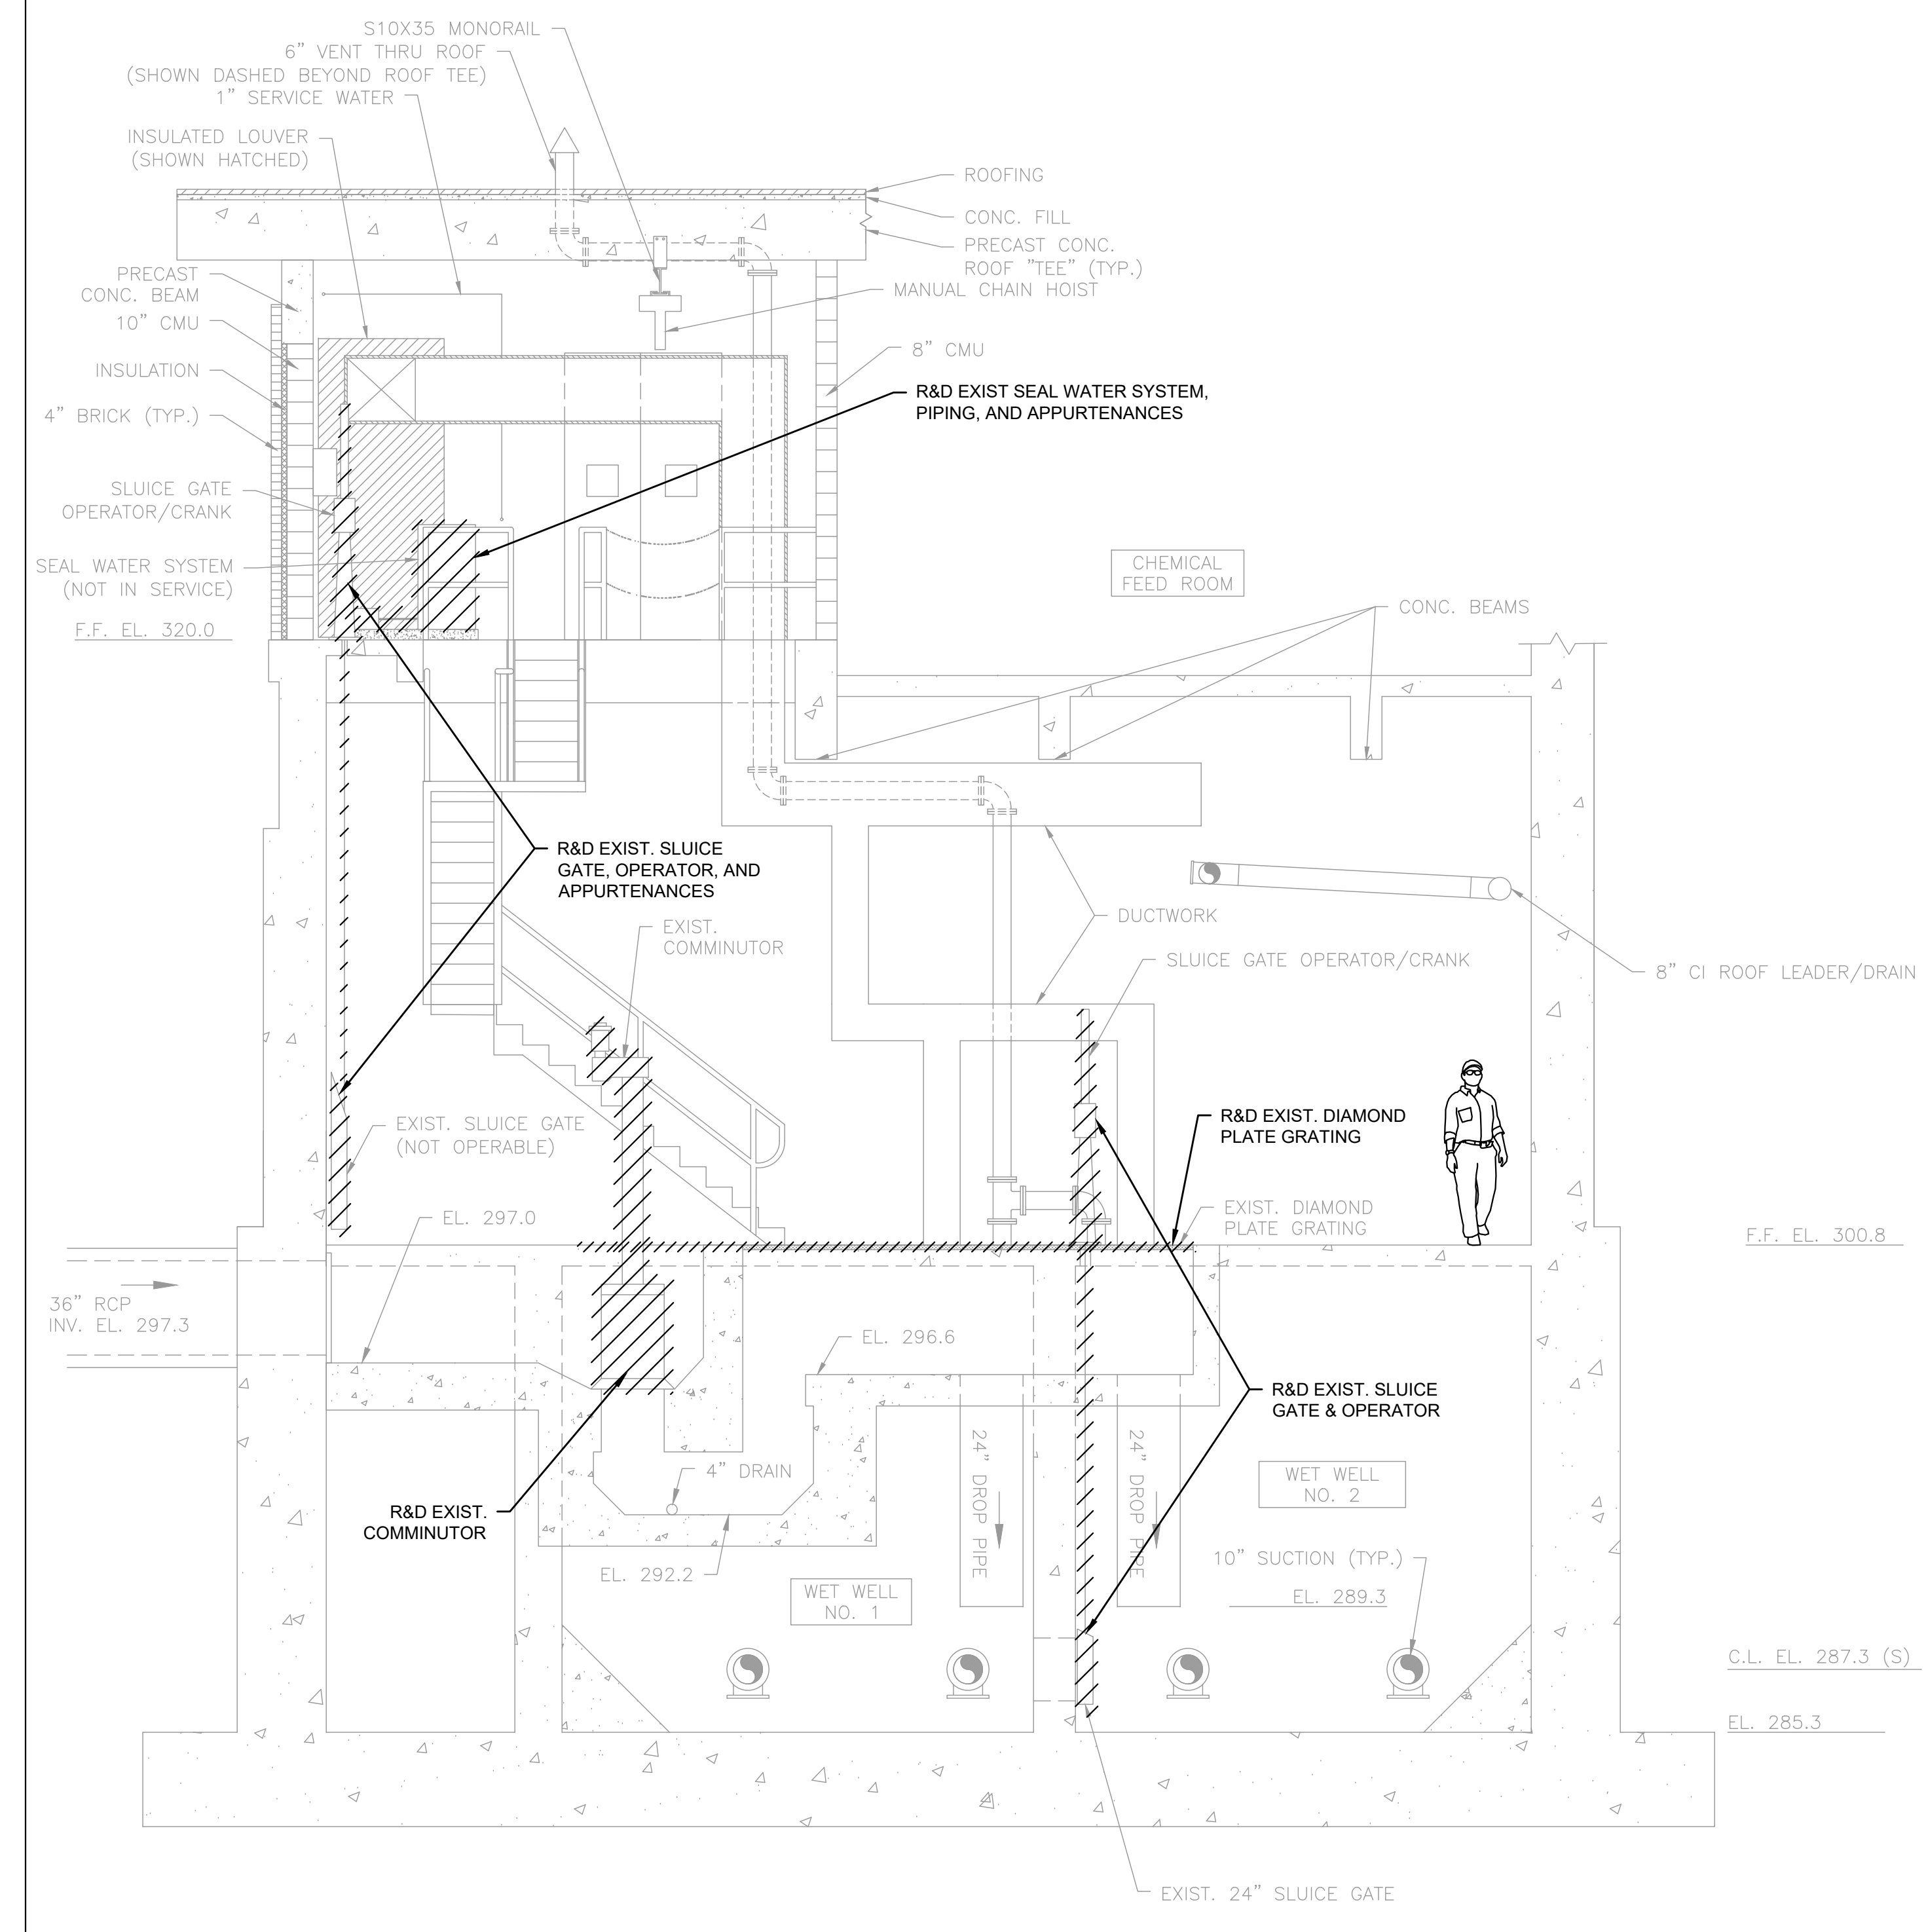


DEMOLITION SECTION B
SCALE: 1/4" = 1'-0"
M-1.1

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PROJECT

**BURRILLVILLE WWTF
HEADWORKS &
OAKLAND PUMP
STATION
IMPROVEMENTS**

BURRILLVILLE, RI


TITLE

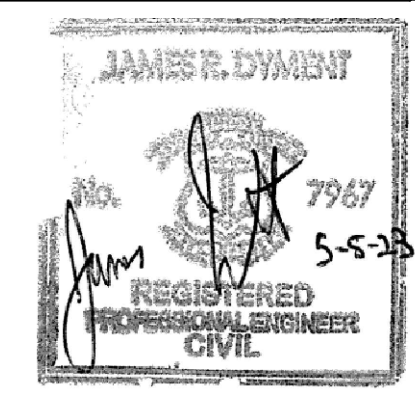**HEADWORKS -
DEMOLITION
SECTIONS - I**

NO.	REVISIONS	DATE

DRAWN BY: CJM
DESIGNED BY: AJG
CHECKED BY: JRD
ISSUE DATE: MAY 2023
BETA JOB NO.: 6861-105

SCALE



SCALE IN FEET: 1"=4"


UNLESS OTHERWISE NOTED OR CHANGED BY REPRODUCTION

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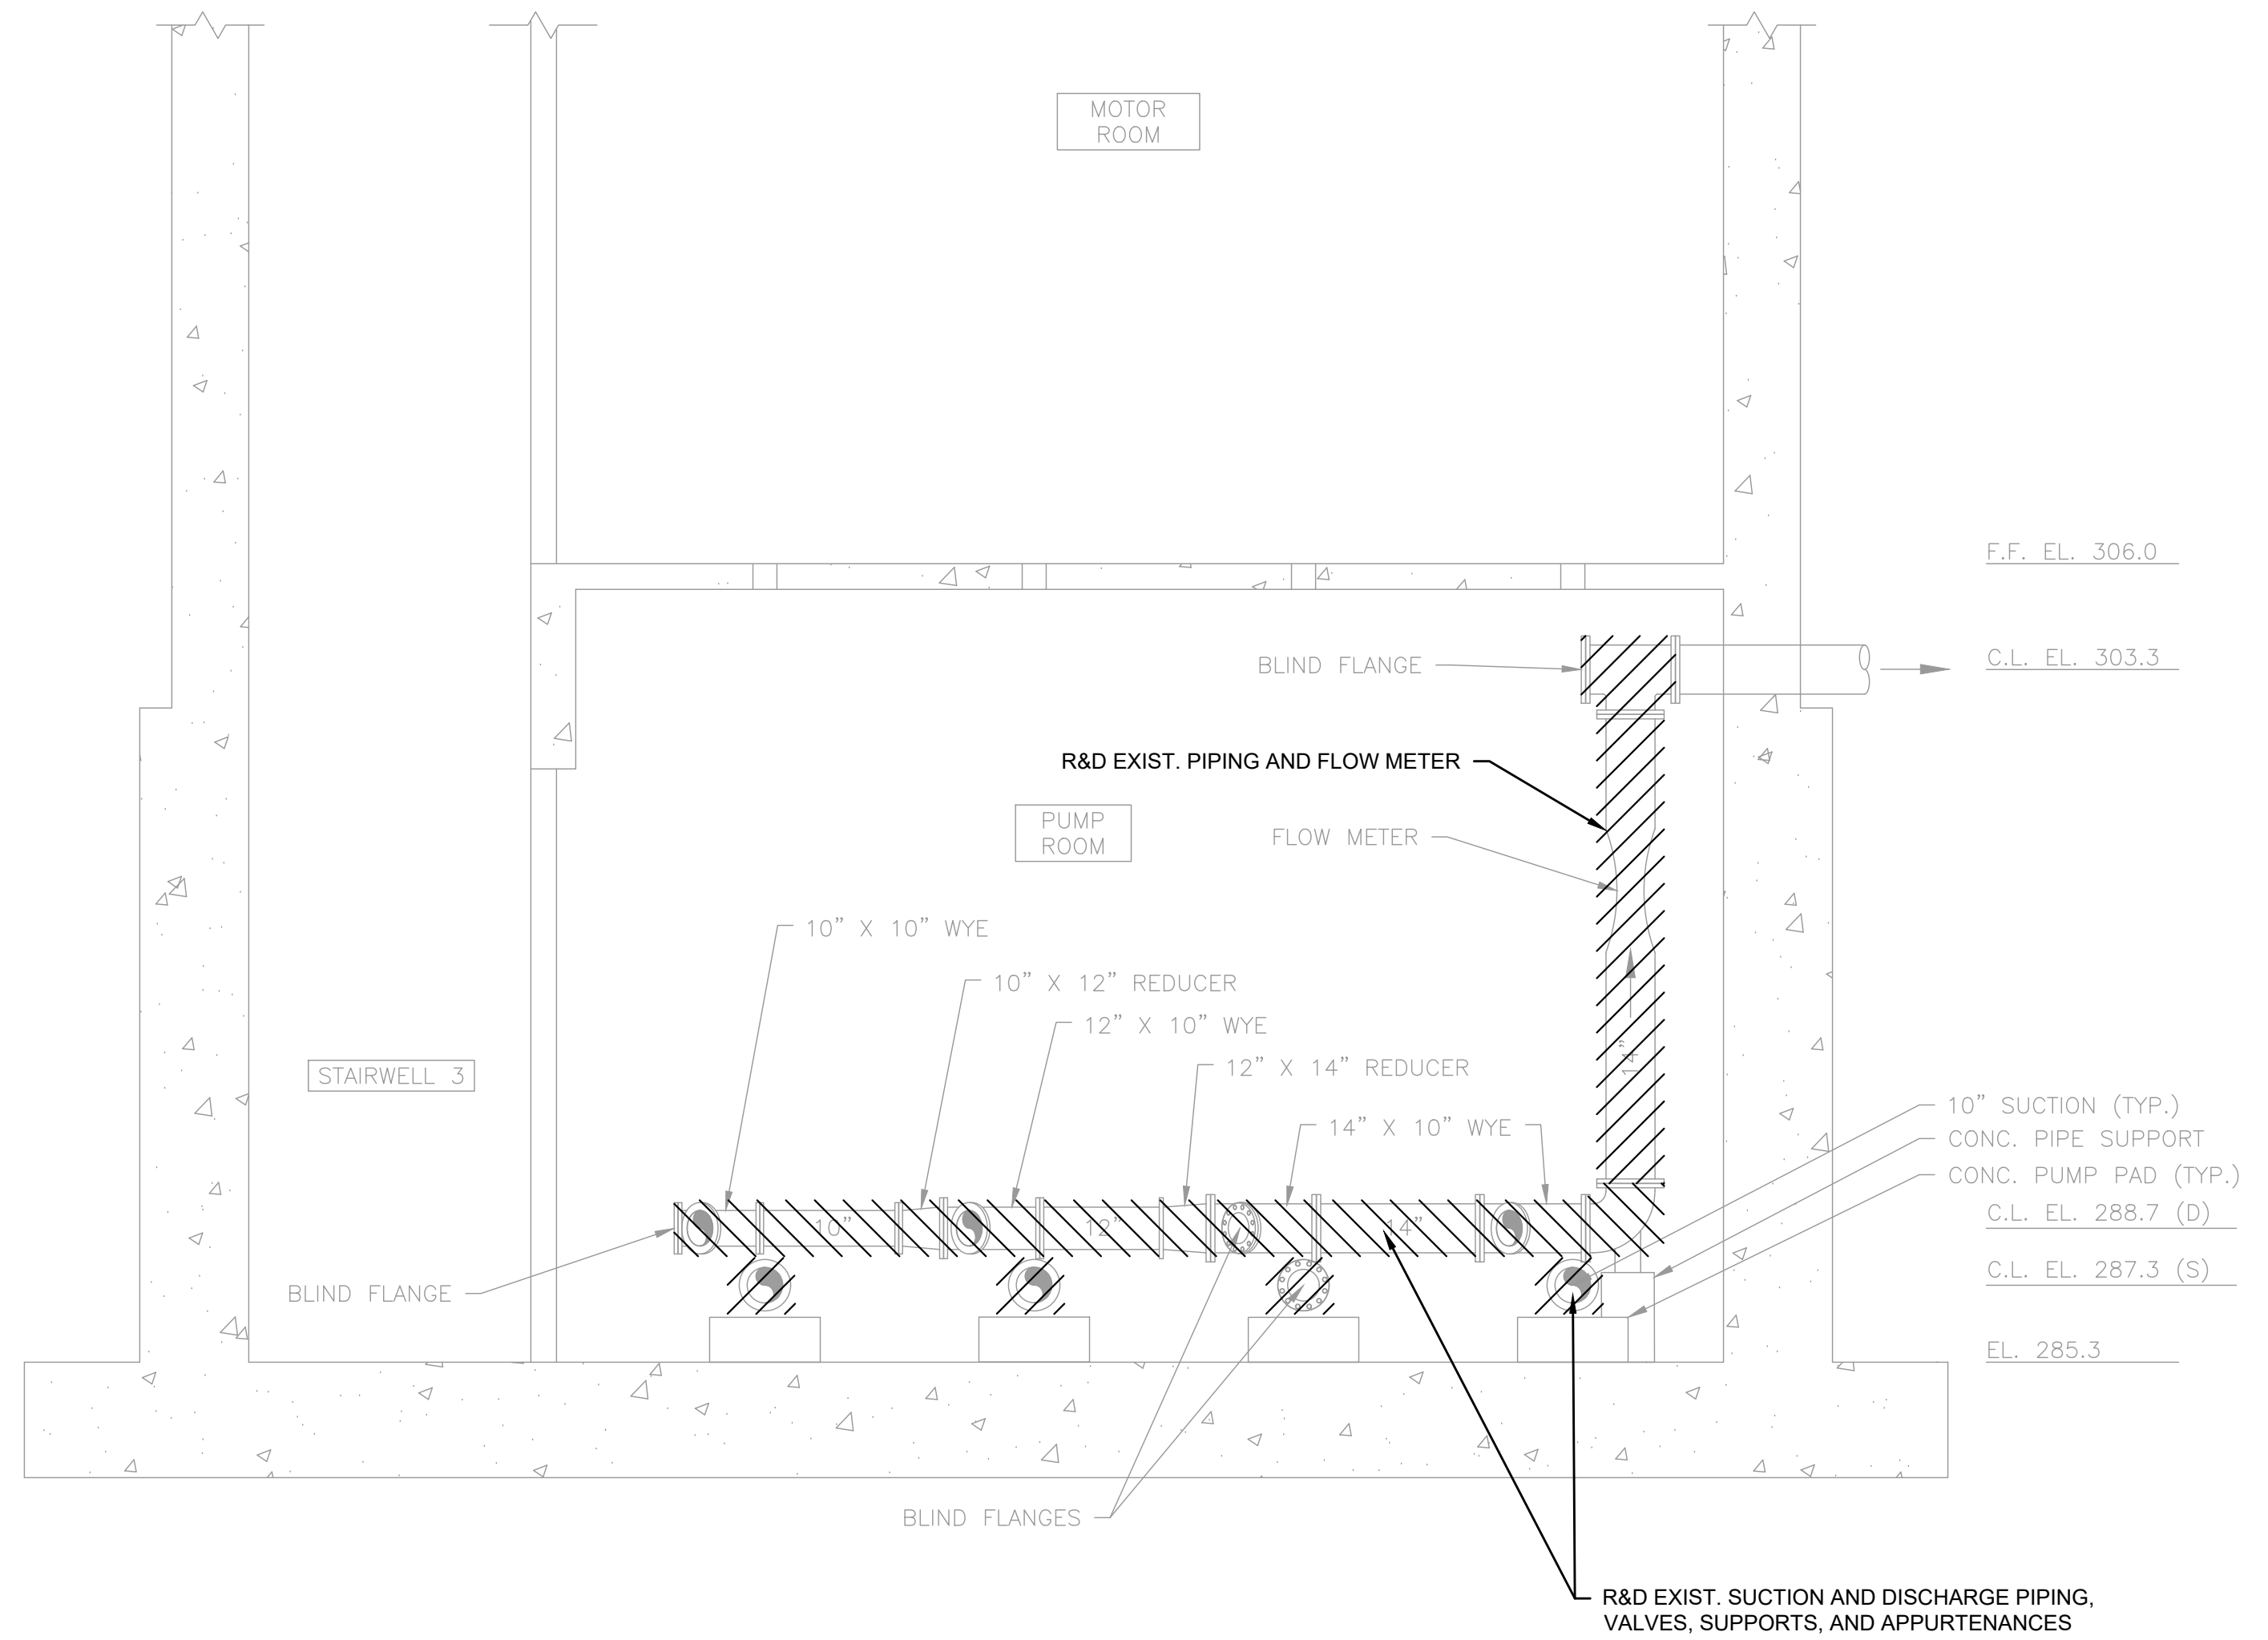
SHEET NO.

M-1.3

5/16/2023 J:\BURRILLVILLE\WTF-HEADWORKS IMPROVEMENTS\CAD\DRAWINGFILES\PLANSET\MECHANICAL-EXIST-HEADWORKS.DWG

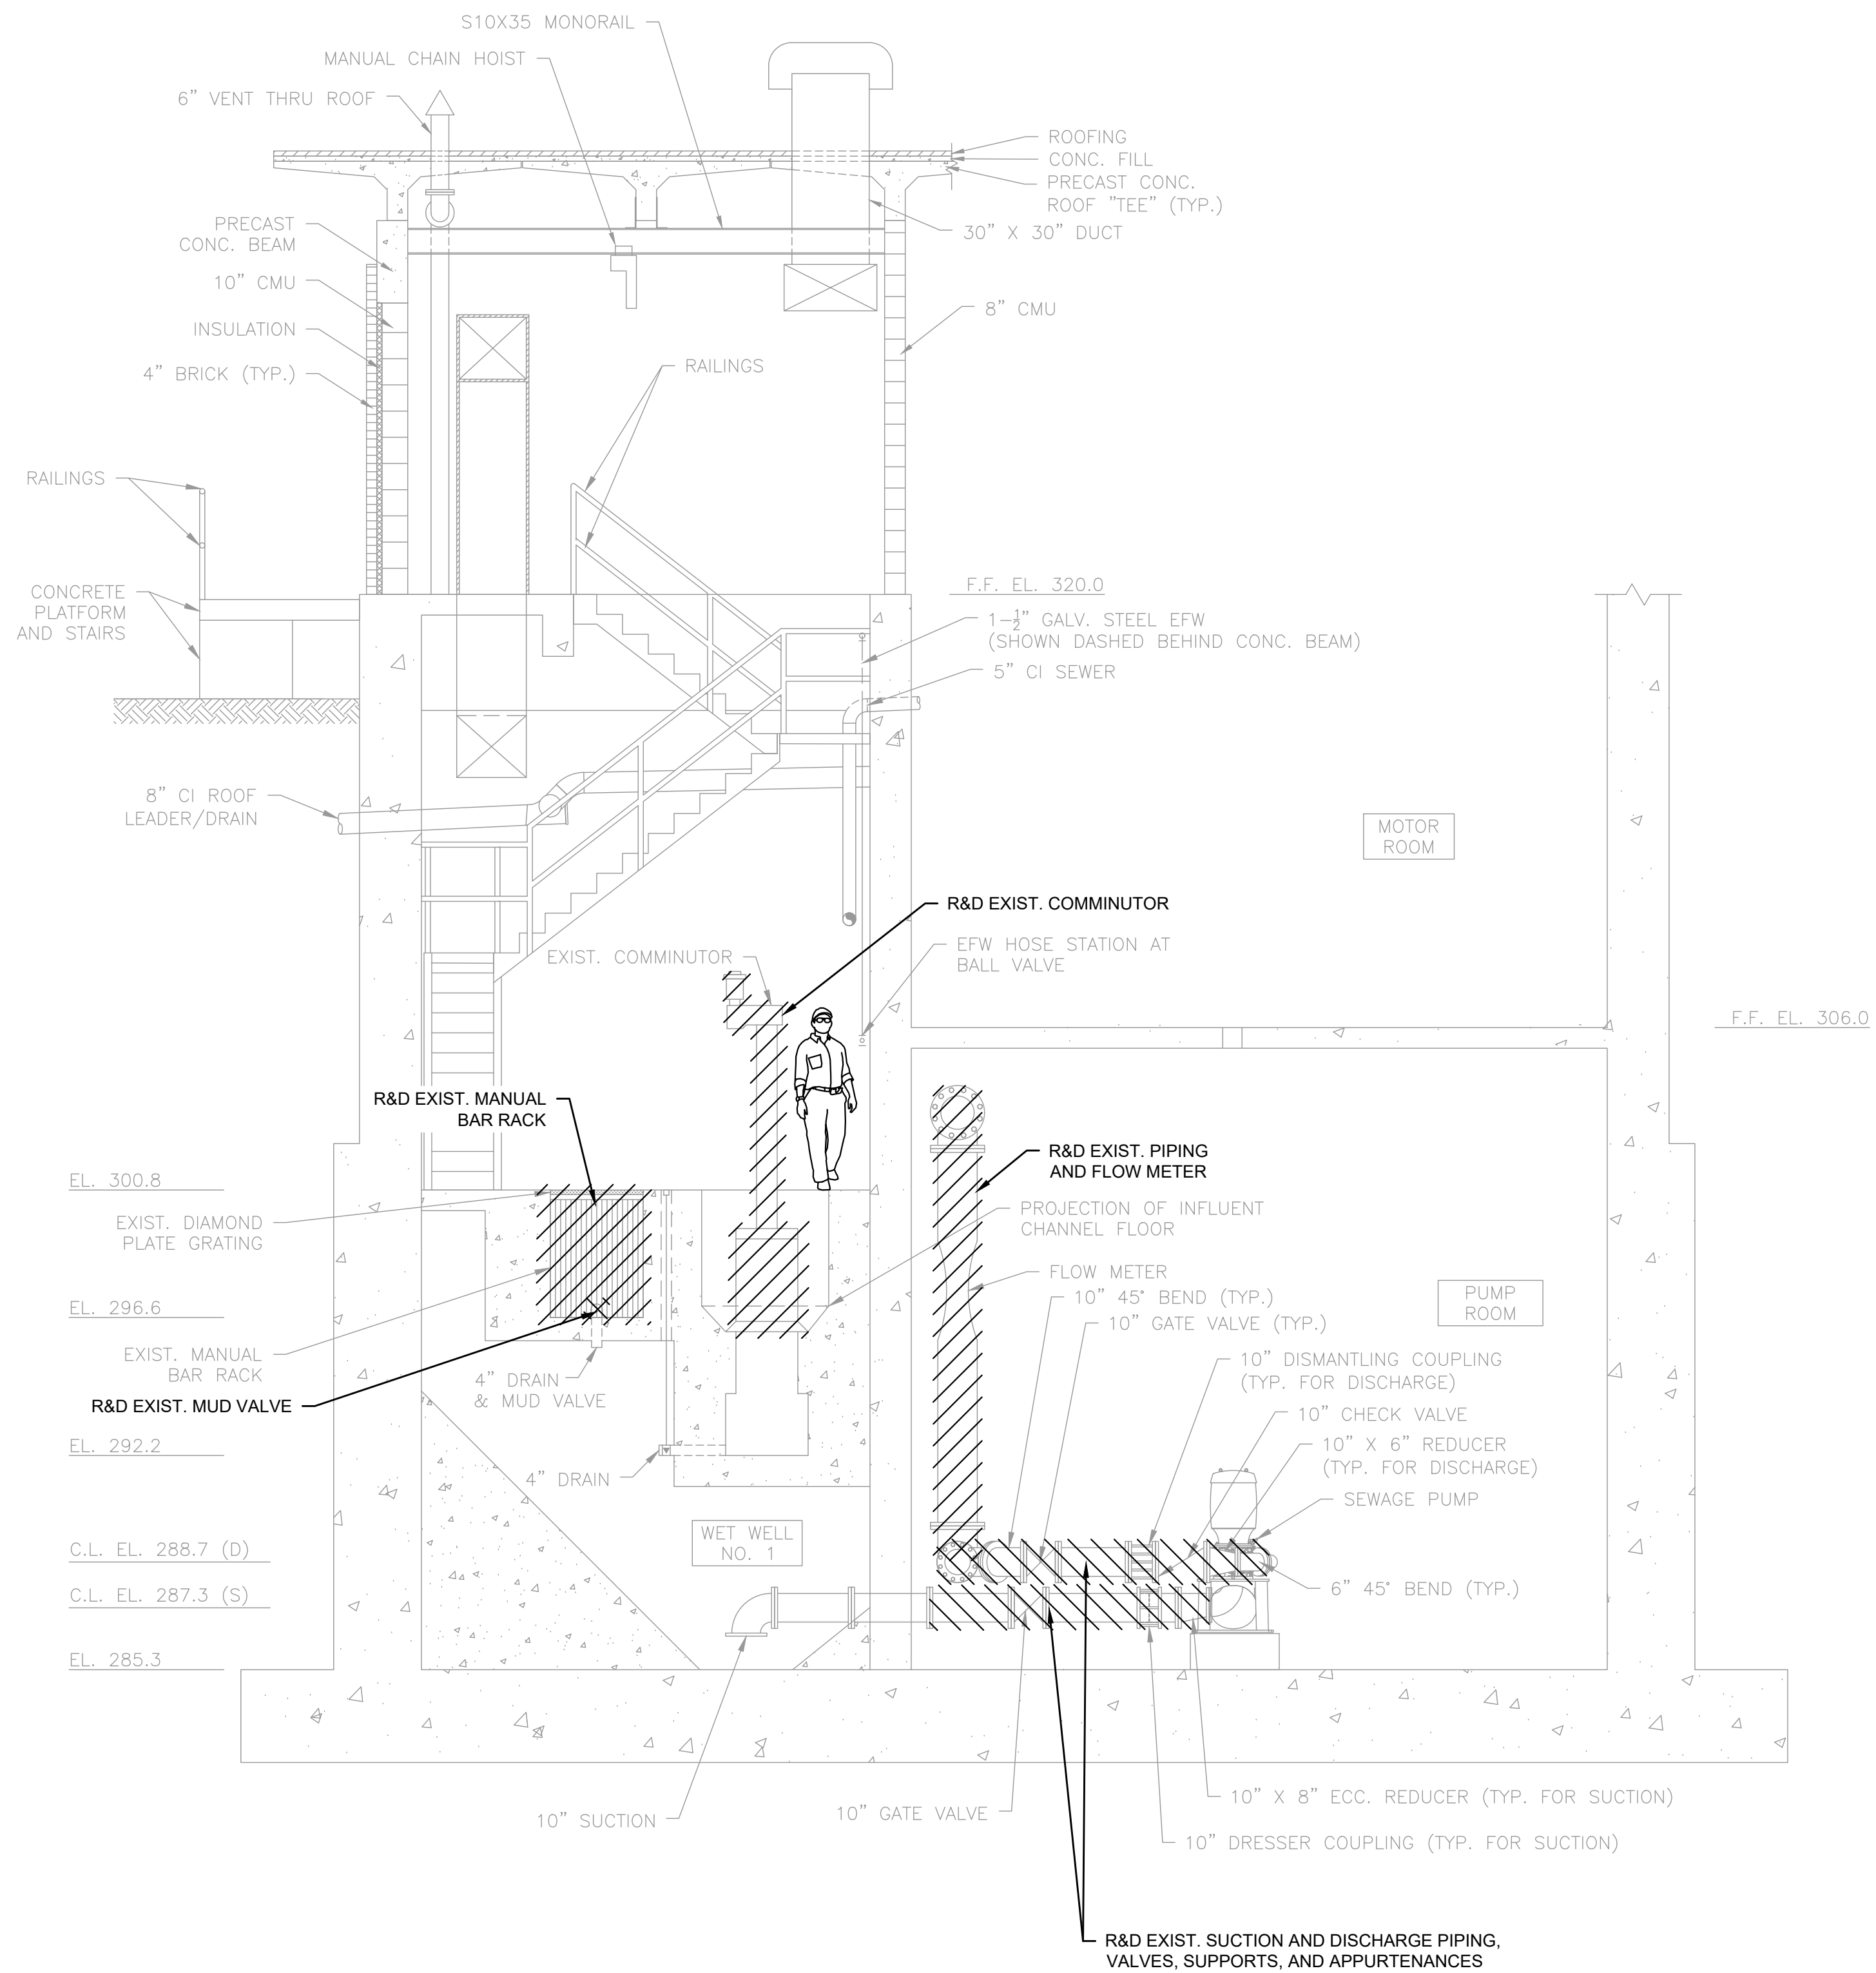

DEMOLITION SECTION C
SCALE: 1/4" = 1'-0"
M-1.1




DEMOLITION SECTION D
SCALE: 1/4" = 1'-0"
M-1.2

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**BURRILLVILLE WWTF
HEADWORKS &
OAKLAND PUMP
STATION
IMPROVEMENTS**

BURRILLVILLE, RI

TITLE

**HEADWORKS -
DEMOLITION
SECTIONS - II**

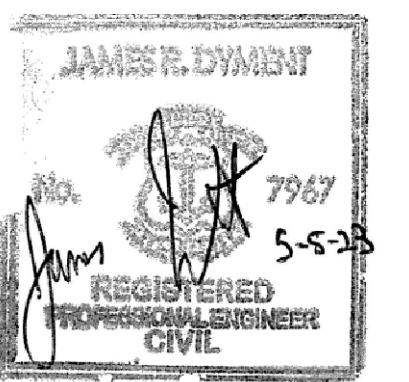NO.	REVISIONS	DATE

DRAWN BY: CJM

DESIGNED BY: AJG

CHECKED BY: JRD

ISSUE DATE: MAY 2023

BETA JOB NO.: 6861-105

SCALE



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SHEET NO.

M-1.4

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GENERAL NOTES:


INSTALLATION OF NEW EQUIPMENT WITHIN THE HEADWORKS BUILDING IS BROKEN DOWN INTO THE FOLLOWING BASE BID WITH ADD/ALTERNATES:

1. **BASE BID ITEM 1:** INSTALL THE PROPOSED MANUAL BAR RACK, SLUICE GATES, NEW GRATING AND GRATING MODIFICATIONS, DEBRIS BIN, NEW FLOW METER AND PIPING, ALL OTHER APPURTENANT WORK, AND THE INFLUENT FINE SCREEN WITH SCREENINGS DISCHARGED TO THE LOWER LEVEL.
 - 1.1. PROPOSED WORK UNDER THE BASE BID ITEM IS SHOWN BOLD THIS SHEET.
2. **ADD/ALTERNATE A-1:** REMOVE AND DISPOSE OF THE EXISTING MANUAL CHAIN HOIST AND INSTALL THE PROPOSED ELECTRIC HOIST.
 - 2.1. PROPOSED WORK UNDER THIS ADD/ALTERNATE ITEM IS SHOWN WITH A REV CLOUD.
3. **ADD/ALTERNATE A-2:** INSTALL THE PROPOSED VERTICAL CONVEYOR WITH SCREENINGS DISCHARGED TO THE UPPER LEVEL AND THE PROPOSED UPPER LEVEL PLATFORM.
 - 3.1. PROPOSED WORK UNDER THIS ADD/ALTERNATE ITEM IS NOT SHOWN THIS SHEET.
4. **ADD/ALTERNATE A-3:** REMOVE, DISPOSE, AND REPLACEMENT OF PIPING & APPURTENANCES AS SHOWN IN THE PUMP ROOM.
 - 4.1. PROPOSED WORK UNDER THIS ADD/ALTERNATE ITEM NOT SHOWN ON THIS SHEET..

PREPARED BY



REGISTERED PROFESSIONAL

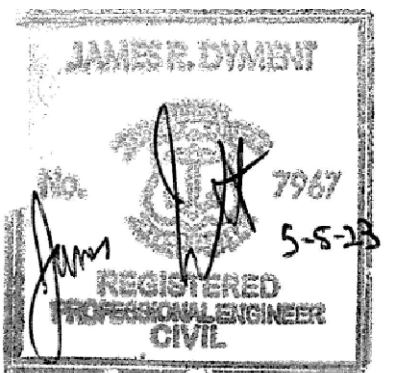

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PROJECT

BURRILLVILLE WWTF HEADWORKS & OAKLAND PUMP STATION IMPROVEMENTS

BURRILLVILLE, RI

TITLE

HEADWORKS - PROPOSED PLANS - I

NO.	REVISIONS	DATE

DRAWN BY:	CJM
DESIGNED BY:	AJG
CHECKED BY:	JRD
ISSUE DATE:	MAY 2023
BETA JOB NO.:	6861-105

SCALE




UNLESS OTHERWISE NOTED OR CHANGED BY REPRODUCTION


For Review Only

SHEET NO.

M-1.5

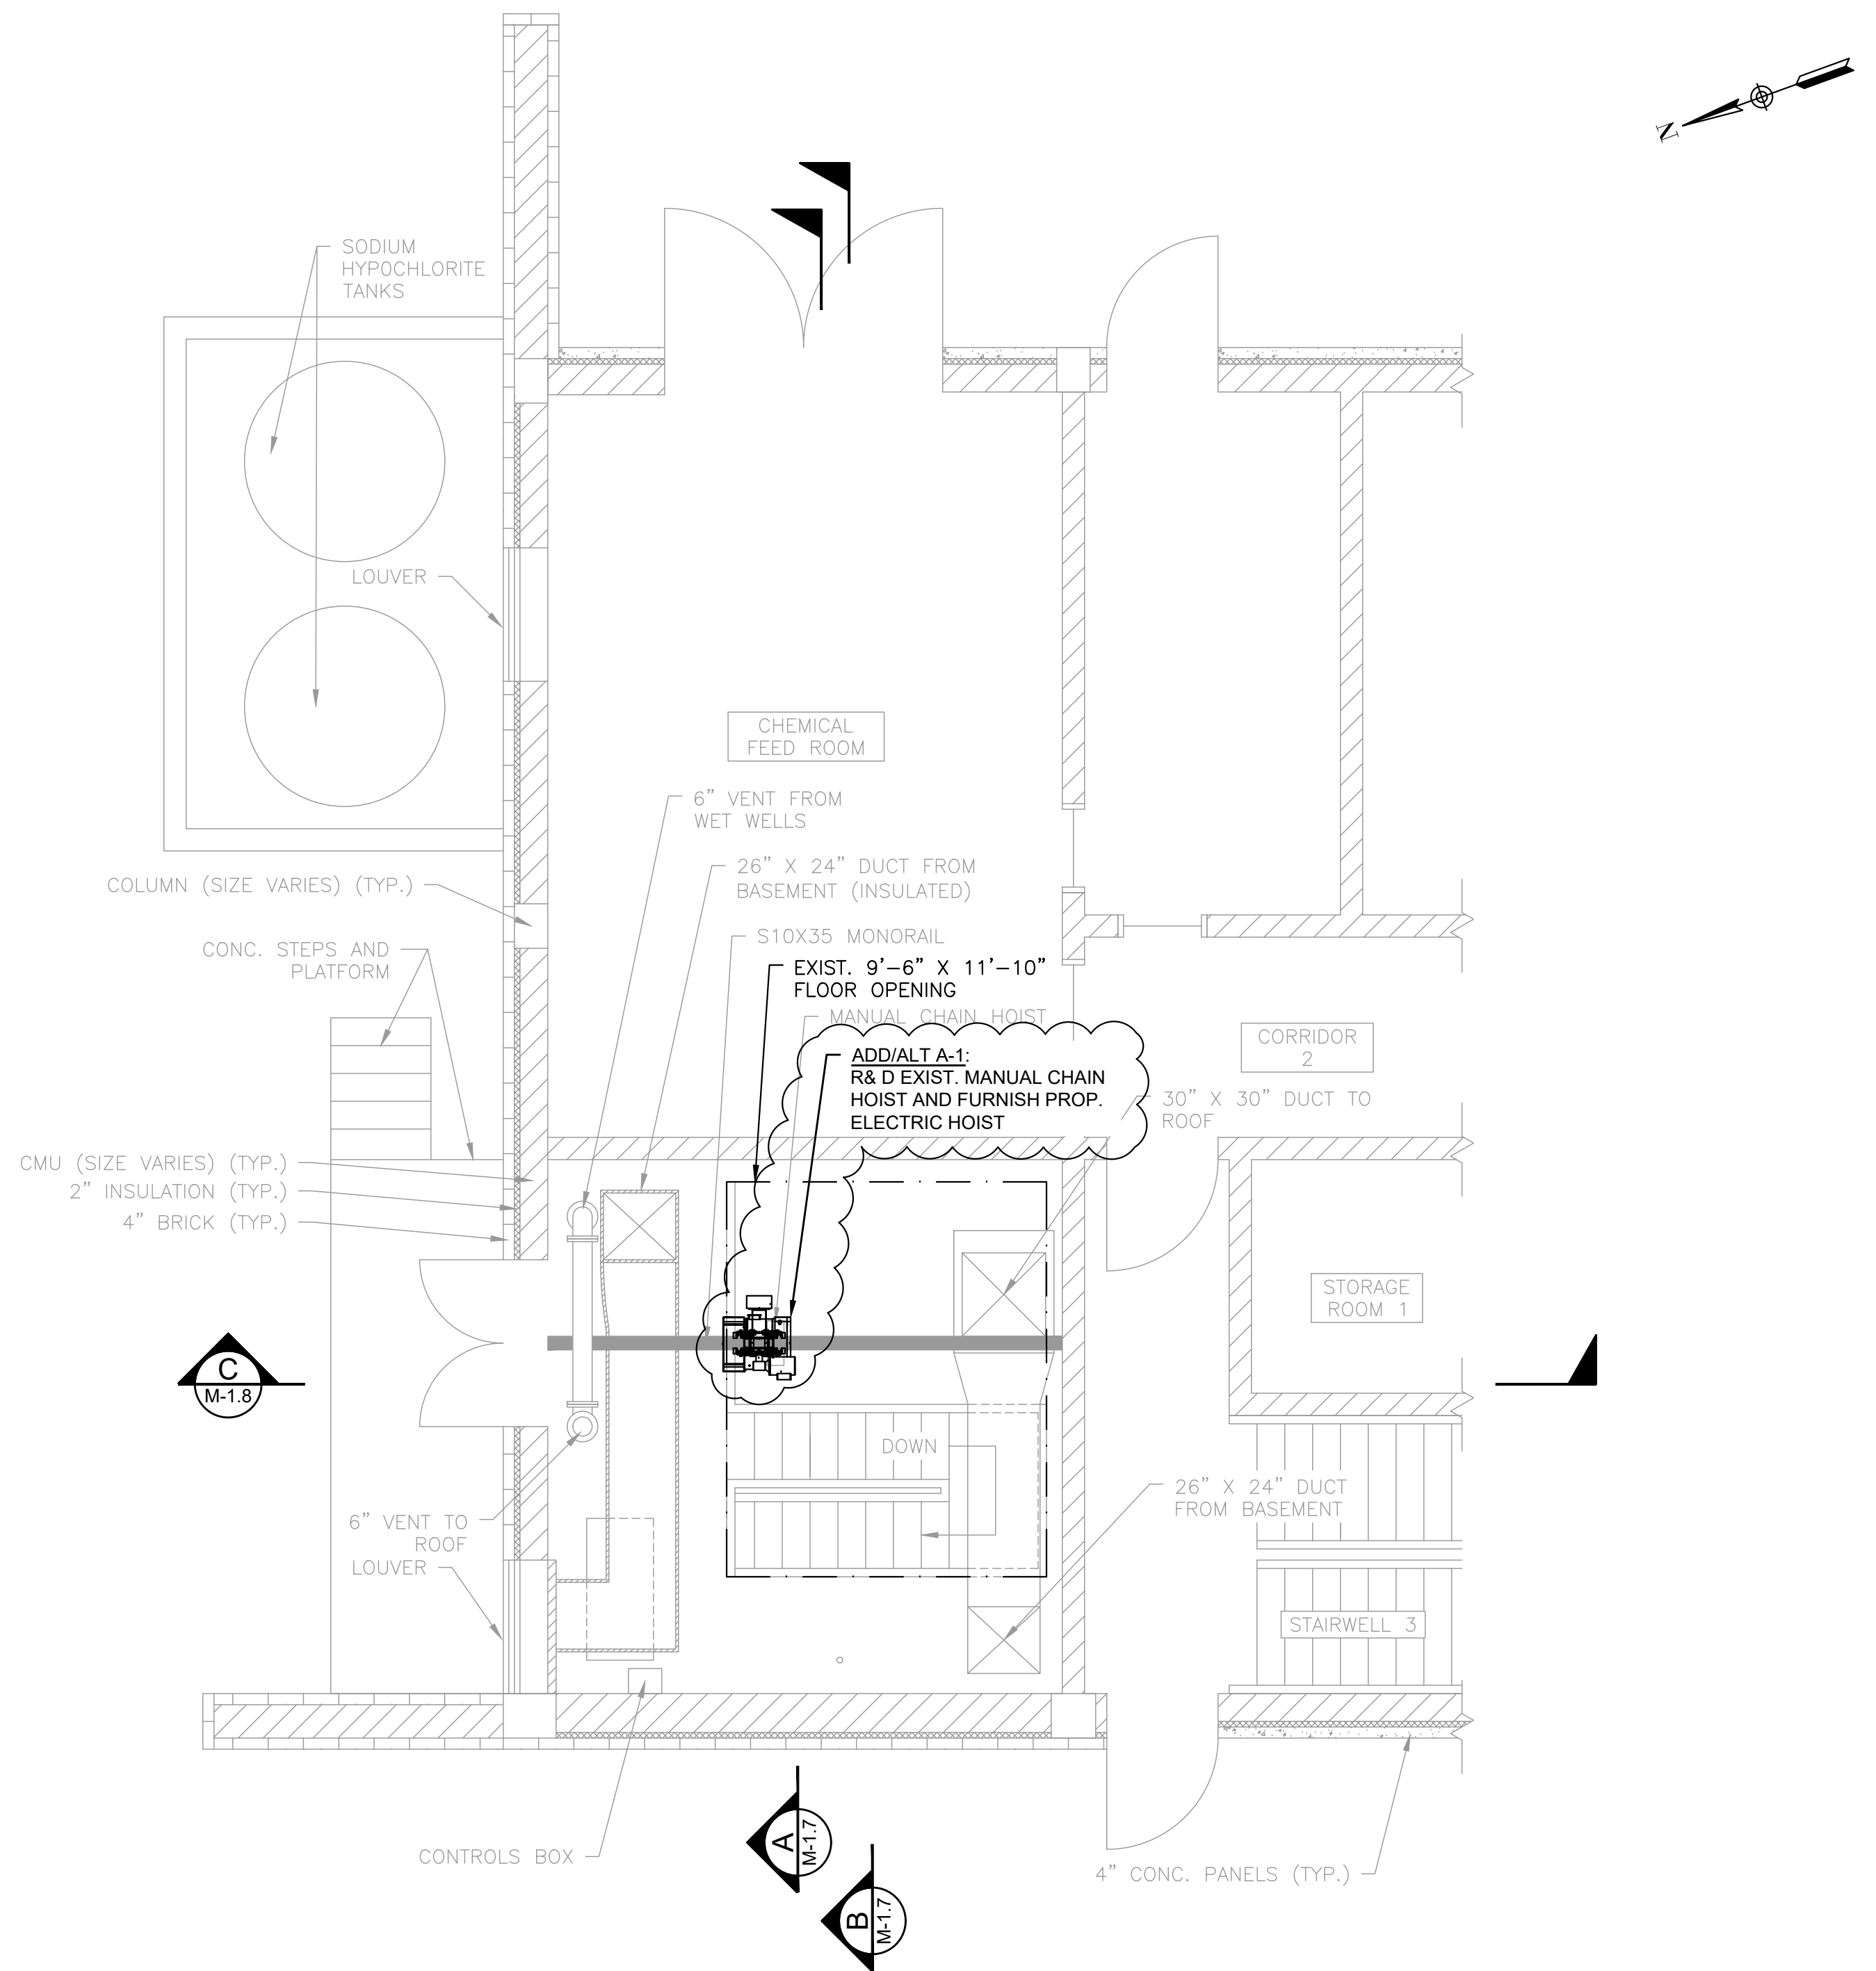

FIRST FLOOR PLAN - PROPOSED
SCALE: 1/4" = 1'-0"

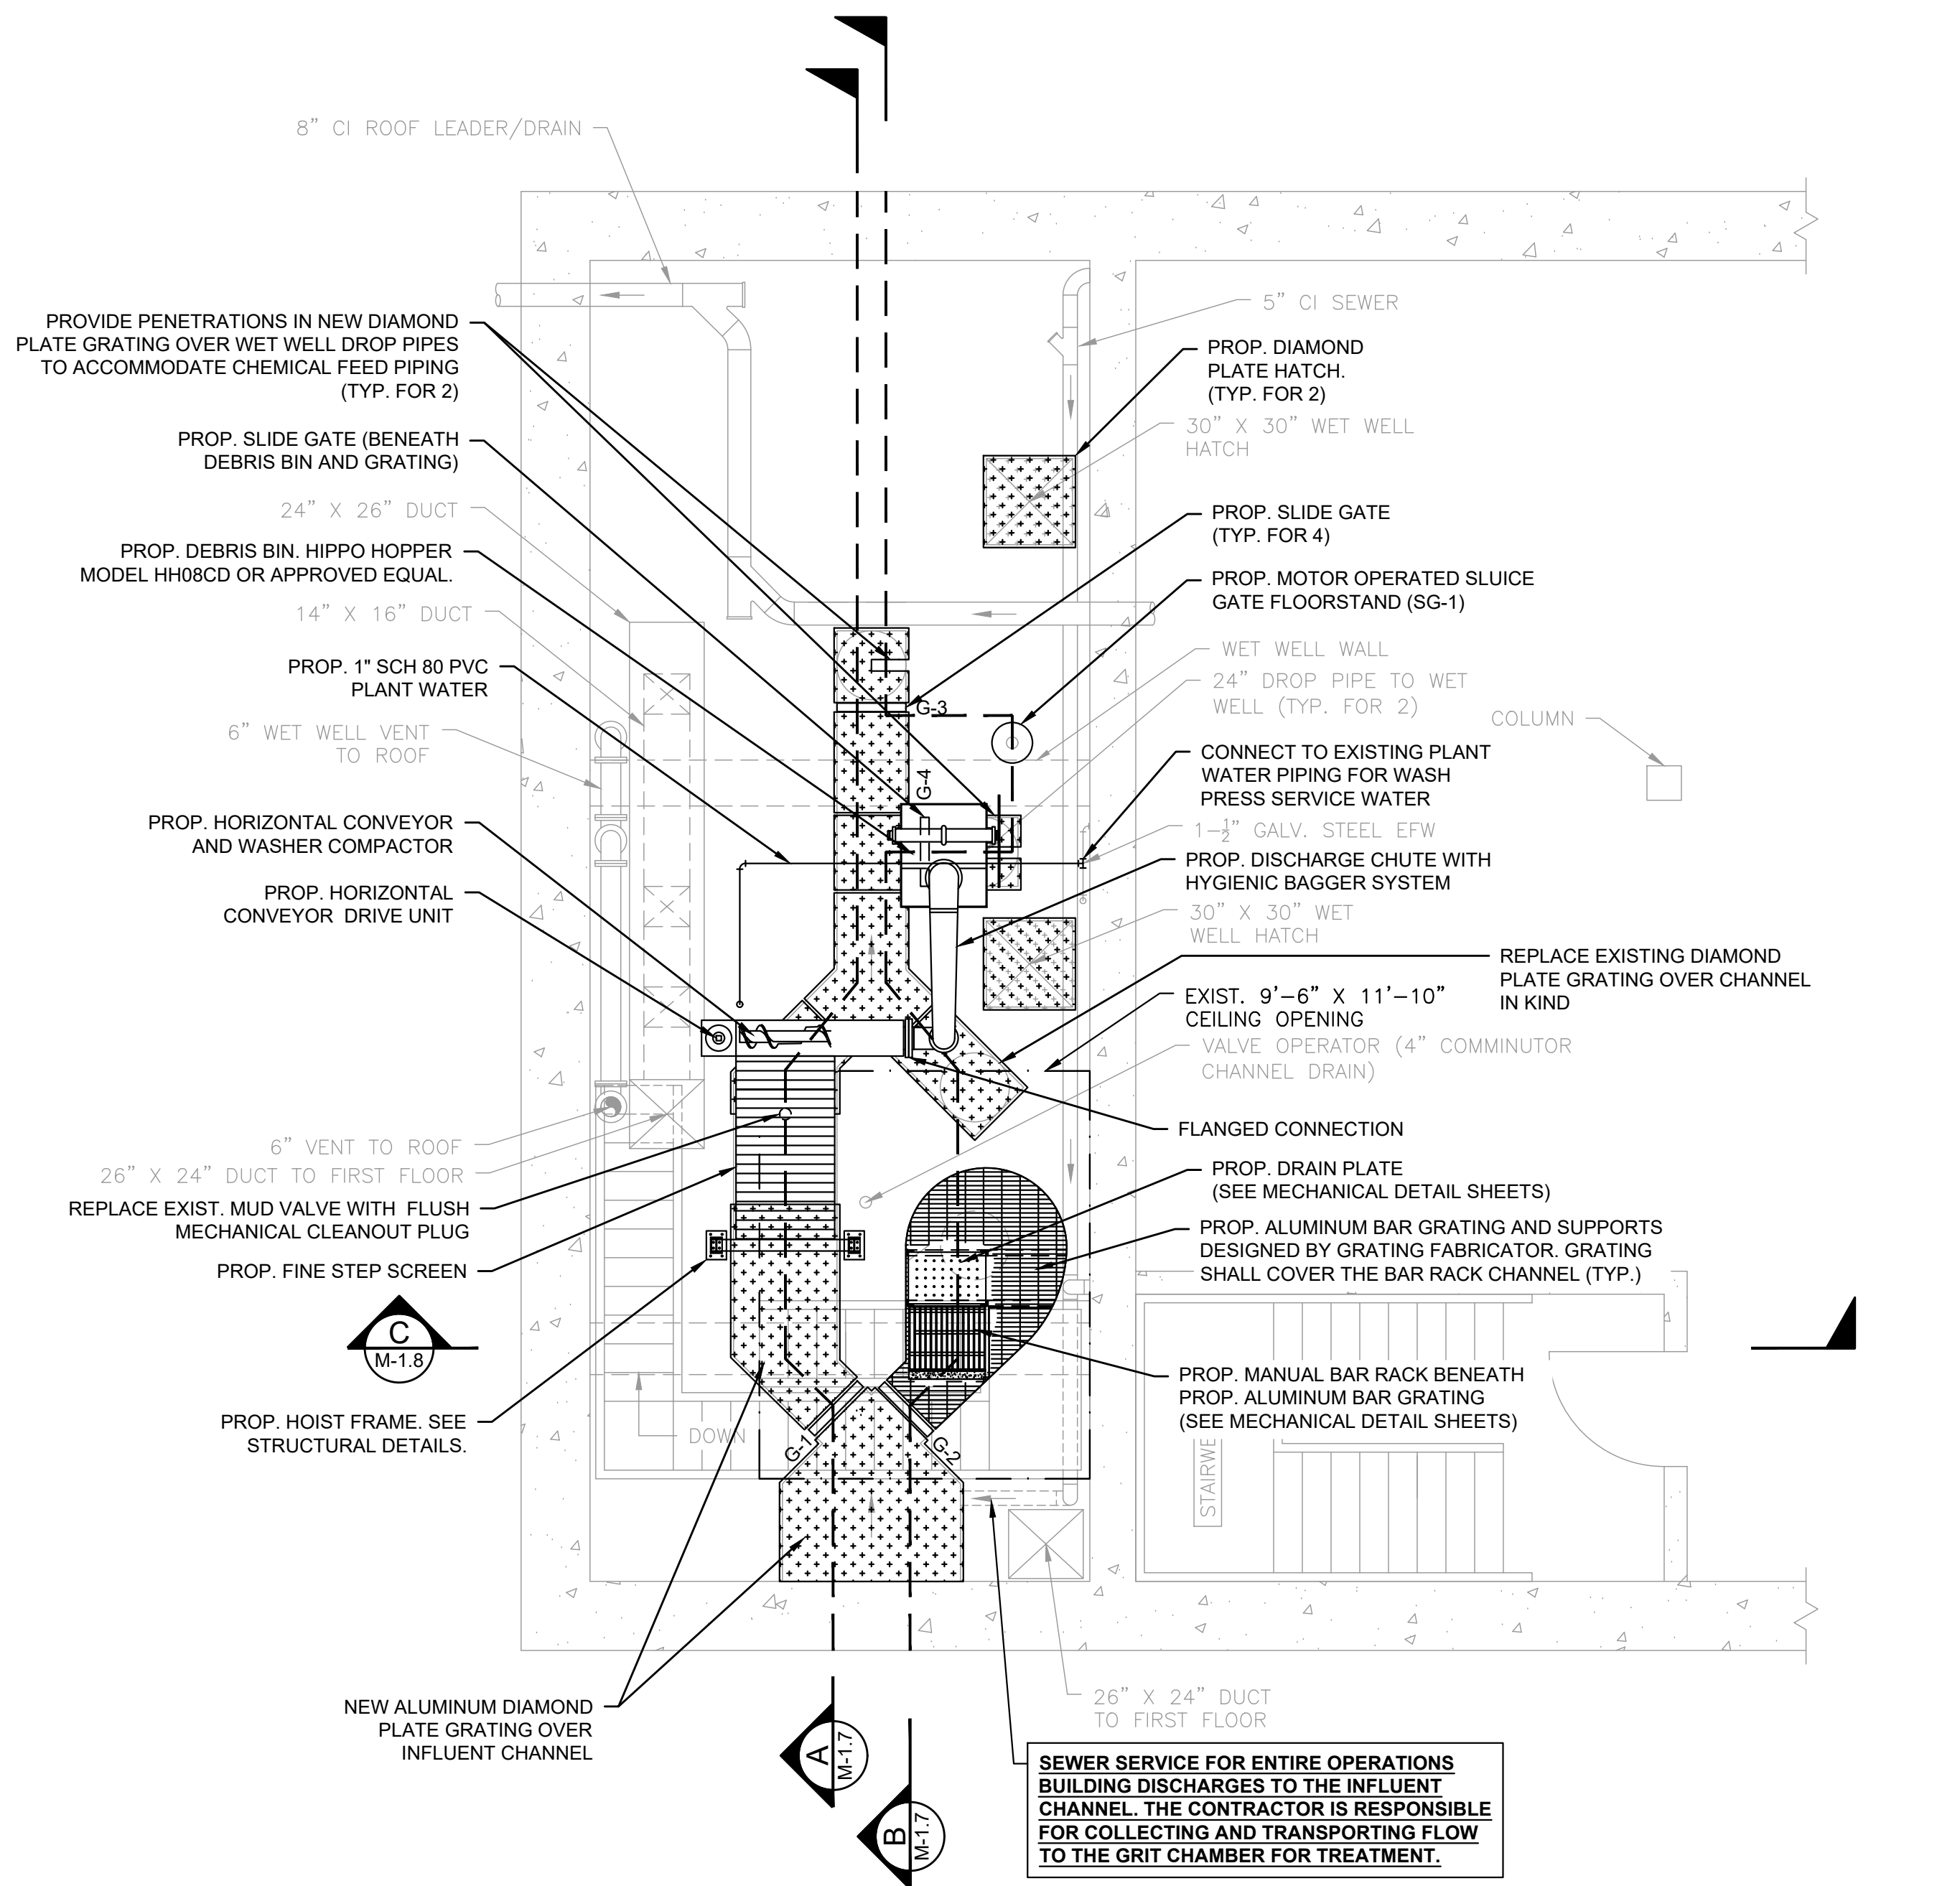

- NOTES:**
1. SEE MECHANICAL DETAIL SHEETS FOR ALL WORK INVOLVING THE MANUAL BAR RACK CHANNEL.


BASEMENT PLAN - PROPOSED
SCALE: 1/4" = 1'-0"

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GENERAL NOTES:


INSTALLATION OF NEW EQUIPMENT WITHIN THE HEADWORKS BUILDING IS BROKEN DOWN INTO THE FOLLOWING BASE BID WITH ADD/ALTERNATES:

1. **BASE BID ITEM 1:** INSTALL THE PROPOSED MANUAL BAR RACK, SLUICE GATES, NEW GRATING AND GRATING MODIFICATIONS, DEBRIS BIN, ALL OTHER APPURTENANT WORK, AND THE INFLUENT FINE SCREEN WITH SCREENINGS DISCHARGED TO THE LOWER LEVEL.
 - 1.1. PROPOSED WORK UNDER THE BASE BID ITEM IS NOT SHOWN ON THIS SHEET.
2. **ADD/ALTERNATE A-1:** REMOVE AND DISPOSE OF THE EXISTING MANUAL CHAIN HOIST AND INSTALL THE PROPOSED ELECTRIC HOIST.
 - 2.1. PROPOSED WORK UNDER THIS ADD/ALTERNATE ITEM IS NOT SHOWN THIS SHEET.
3. **ADD/ALTERNATE A-2:** INSTALL THE PROPOSED VERTICAL CONVEYOR WITH SCREENINGS DISCHARGED TO THE UPPER LEVEL AND THE PROPOSED UPPER LEVEL PLATFORM.
 - 3.1. PROPOSED WORK UNDER THIS ADD/ALTERNATE ITEM IS NOT SHOWN THIS SHEET.
4. **ADD/ALTERNATE A-3:** REMOVE, DISPOSE, AND REPLACEMENT OF PIPING & APPURTENANCES AS SHOWN IN THE PUMP ROOM
 - 4.1. PROPOSED WORK UNDER THIS ADD/ALTERNATE ITEM IS SHOWN BOLD ON THIS SHEET..

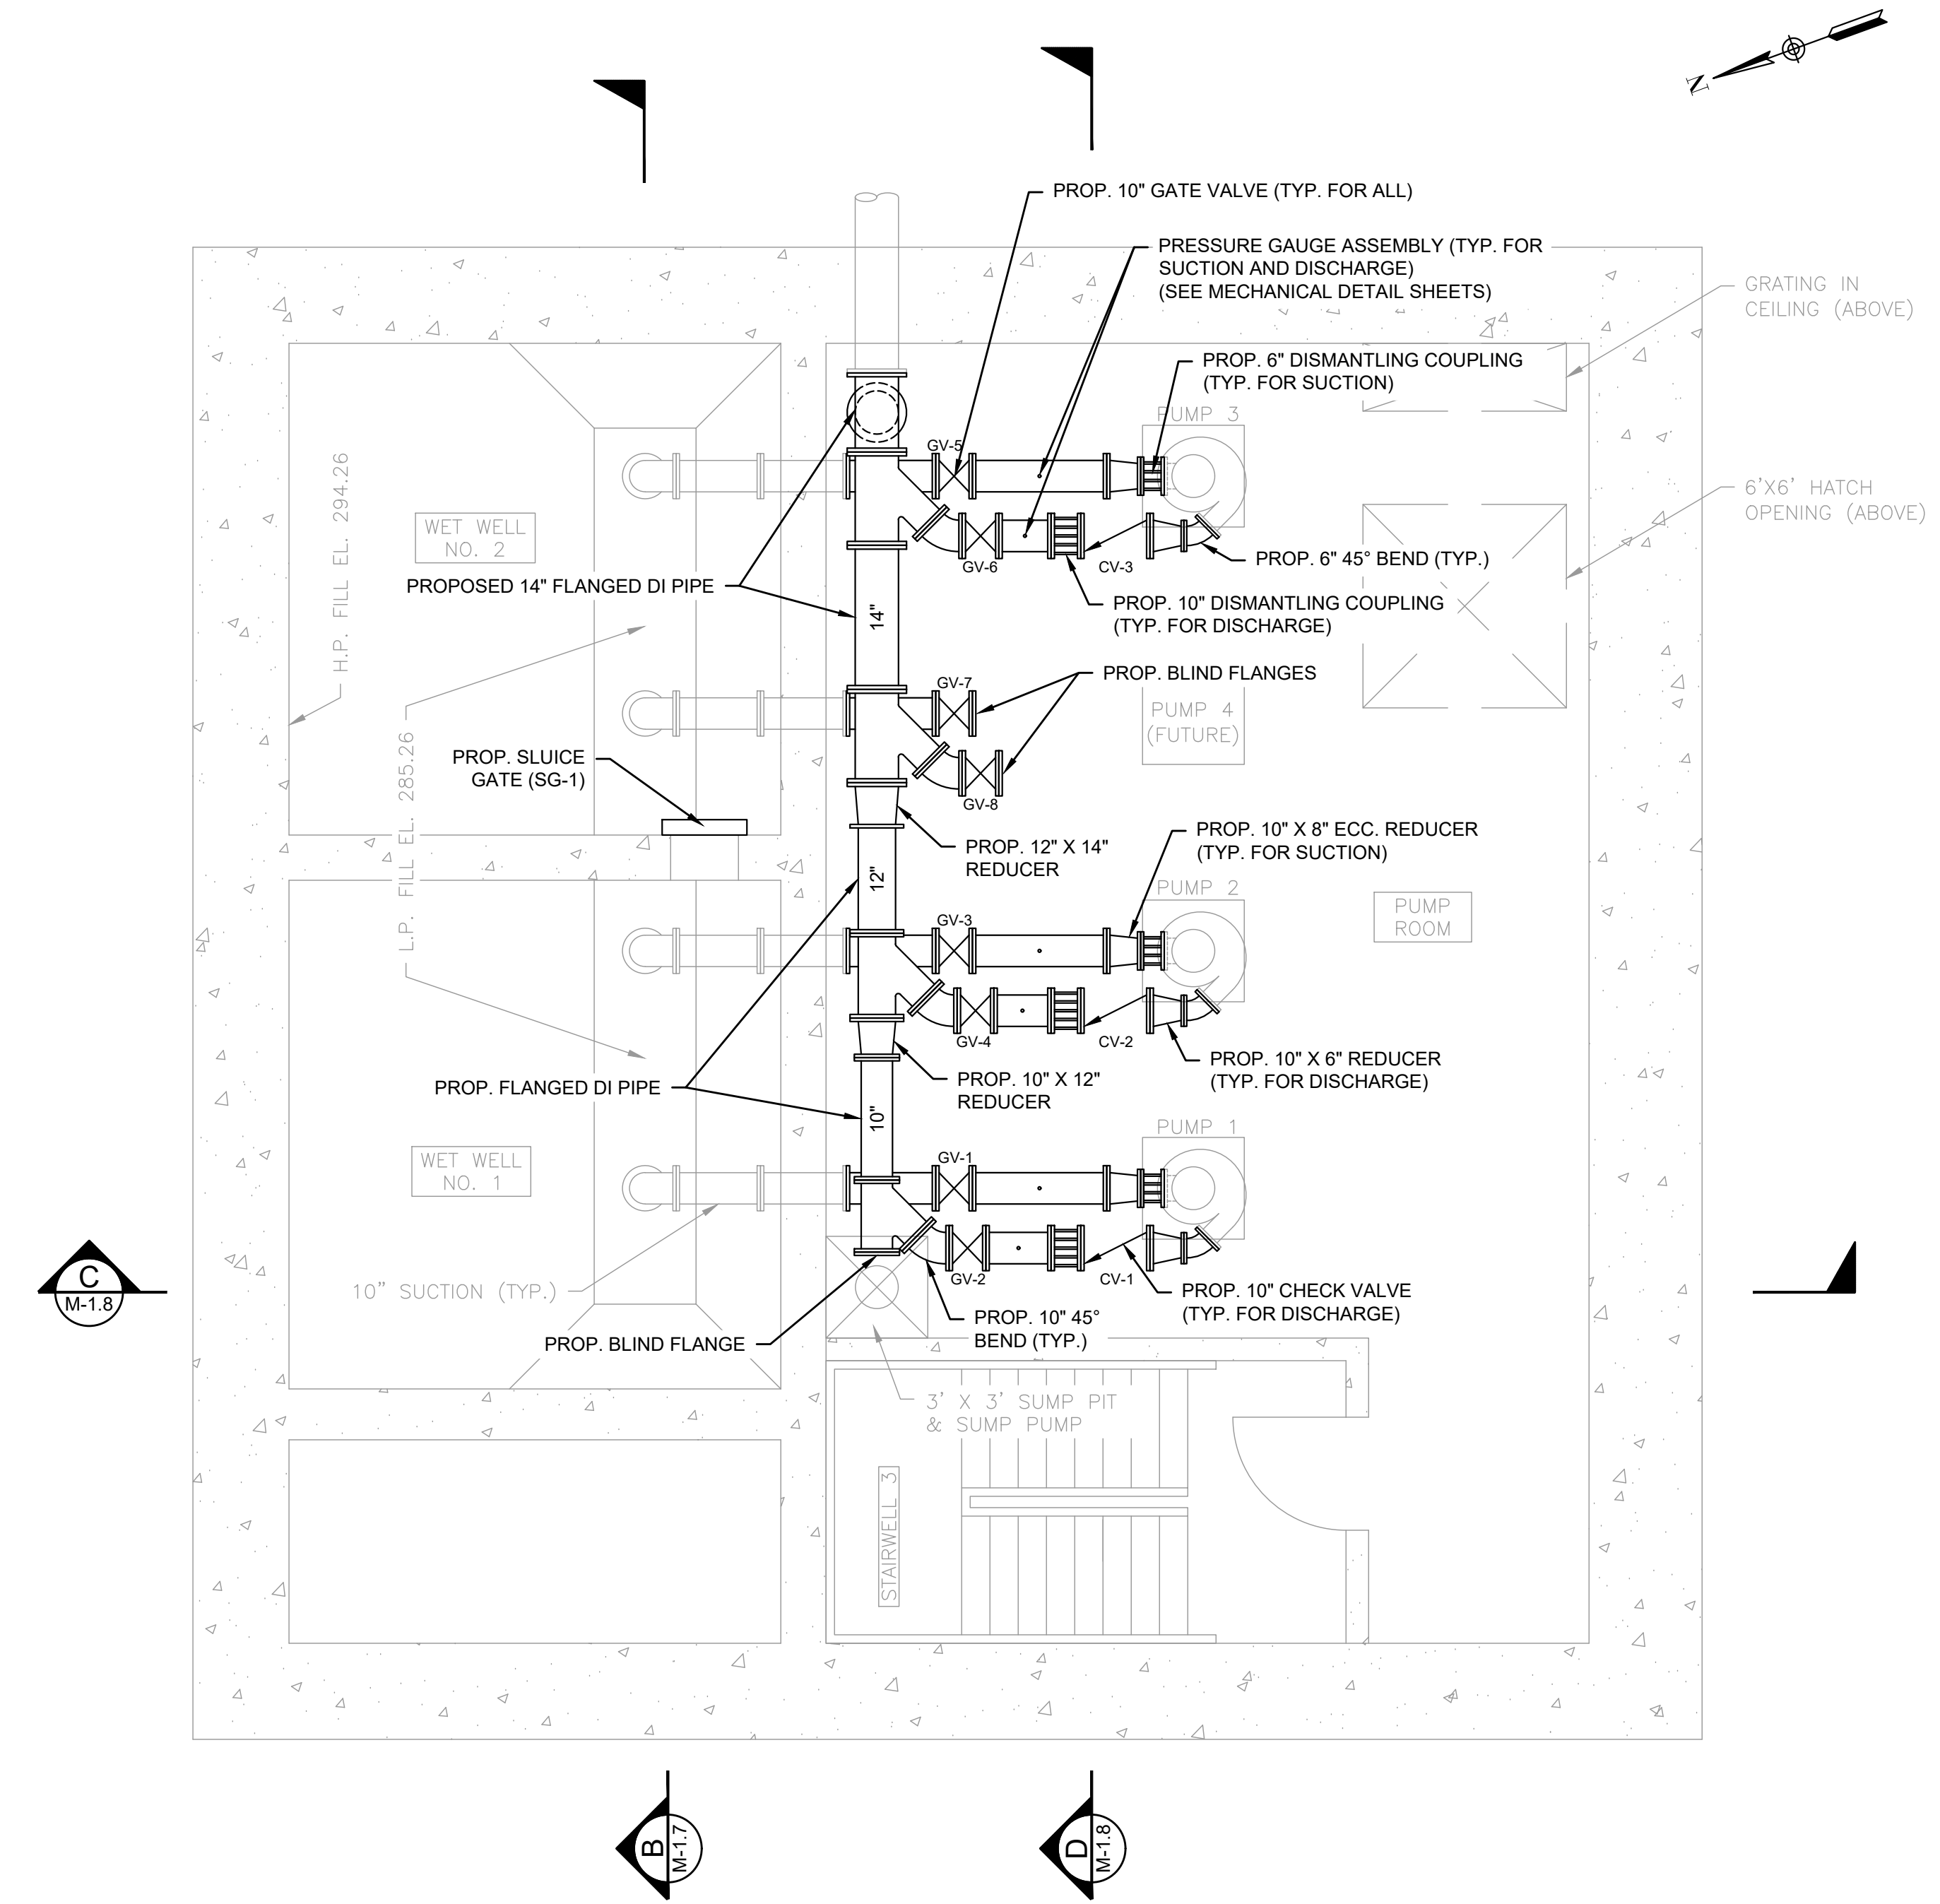


SUB-BASEMENT PLAN - PROPOSED
SCALE: 1/4" = 1'-0"

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JAMES R. DWYER
No. 7967
5-5-23
REGISTERED PROFESSIONAL ENGINEER
CIVIL

SUBCONSULTANT

PROJECT

**BURRILLVILLE WWTF
HEADWORKS &
OAKLAND PUMP
STATION
IMPROVEMENTS**

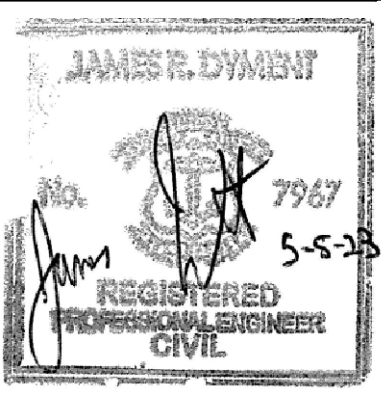BURRILLVILLE, RI


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**HEADWORKS -
PROPOSED
PLANS - II**

NO.	REVISIONS	DATE

DRAWN BY: CJM
DESIGNED BY: AJG
CHECKED BY: JRD
ISSUE DATE: MAY 2023
BETA JOB NO.: 6861-105

SCALE



SCALE IN FEET: 1"=4'

UNLESS OTHERWISE NOTED OR CHANGED BY REPRODUCTION

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SHEET NO.

M-1.6

GENERAL NOTES:

INSTALLATION OF NEW EQUIPMENT WITHIN THE HEADWORKS BUILDING IS BROKEN DOWN INTO THE FOLLOWING BASE BID WITH ADD/ALTERNATES:


1. **BASE BID ITEM 1:** INSTALL THE PROPOSED MANUAL BAR RACK, SLUICE GATES, NEW GRATING AND GRATING MODIFICATIONS, DEBRIS BIN, NEW FLOW METER AND PIPING, ALL OTHER APPURTENANT WORK, AND THE INFLUENT FINE SCREEN WITH SCREENINGS DISCHARGED TO THE LOWER LEVEL.
 - 1.1. PROPOSED WORK UNDER THE BASE BID ITEM IS SHOWN BOLD THIS SHEET.
2. **ADD/ALTERNATE A-1:** REMOVE AND DISPOSE OF THE EXISTING MANUAL CHAIN HOIST AND INSTALL THE PROPOSED ELECTRIC HOIST.
 - 2.1. PROPOSED WORK UNDER THIS ADD/ALTERNATE ITEM IS SHOWN WITH A REV CLOUD.
3. **ADD/ALTERNATE A-2:** INSTALL THE PROPOSED VERTICAL CONVEYOR WITH SCREENINGS DISCHARGED TO THE UPPER LEVEL AND THE PROPOSED UPPER LEVEL PLATFORM.
 - 3.1. PROPOSED WORK UNDER THIS ADD/ALTERNATE ITEM IS NOT SHOWN THIS SHEET.
4. **ADD/ALTERNATE A-3:** REMOVE, DISPOSE, AND REPLACEMENT OF PIPING & APPURTENANCES AS SHOWN IN THE PUMP ROOM.
 - 4.1. PROPOSED WORK UNDER THIS ADD/ALTERNATE ITEM IS NOT SHOWN ON THIS SHEET..

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BURRILLVILLE WWTF HEADWORKS & OAKLAND PUMP STATION IMPROVEMENTS


BURRILLVILLE, RI

TITLE

HEADWORKS - PROPOSED SECTIONS - I

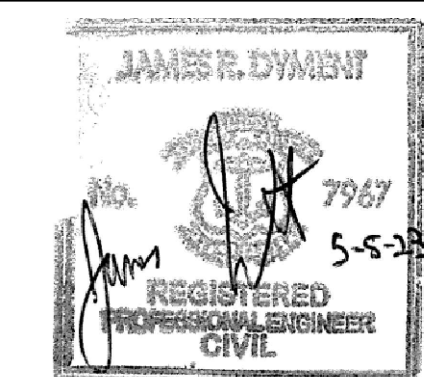NO.	REVISIONS	DATE


DRAWN BY:	CJM
DESIGNED BY:	AJG
CHECKED BY:	JRD
ISSUE DATE:	MAY 2023
BETA JOB NO.:	6861-105

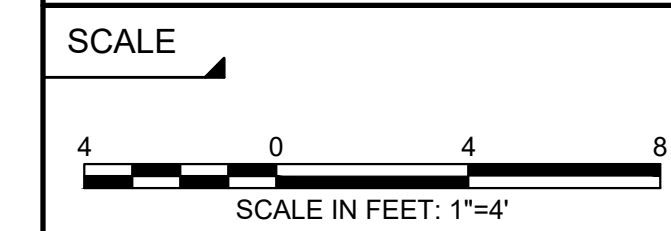


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SHEET NO. **M-1.7**



PROPOSED SECTION A
SCALE: 1/4" = 1'-0"

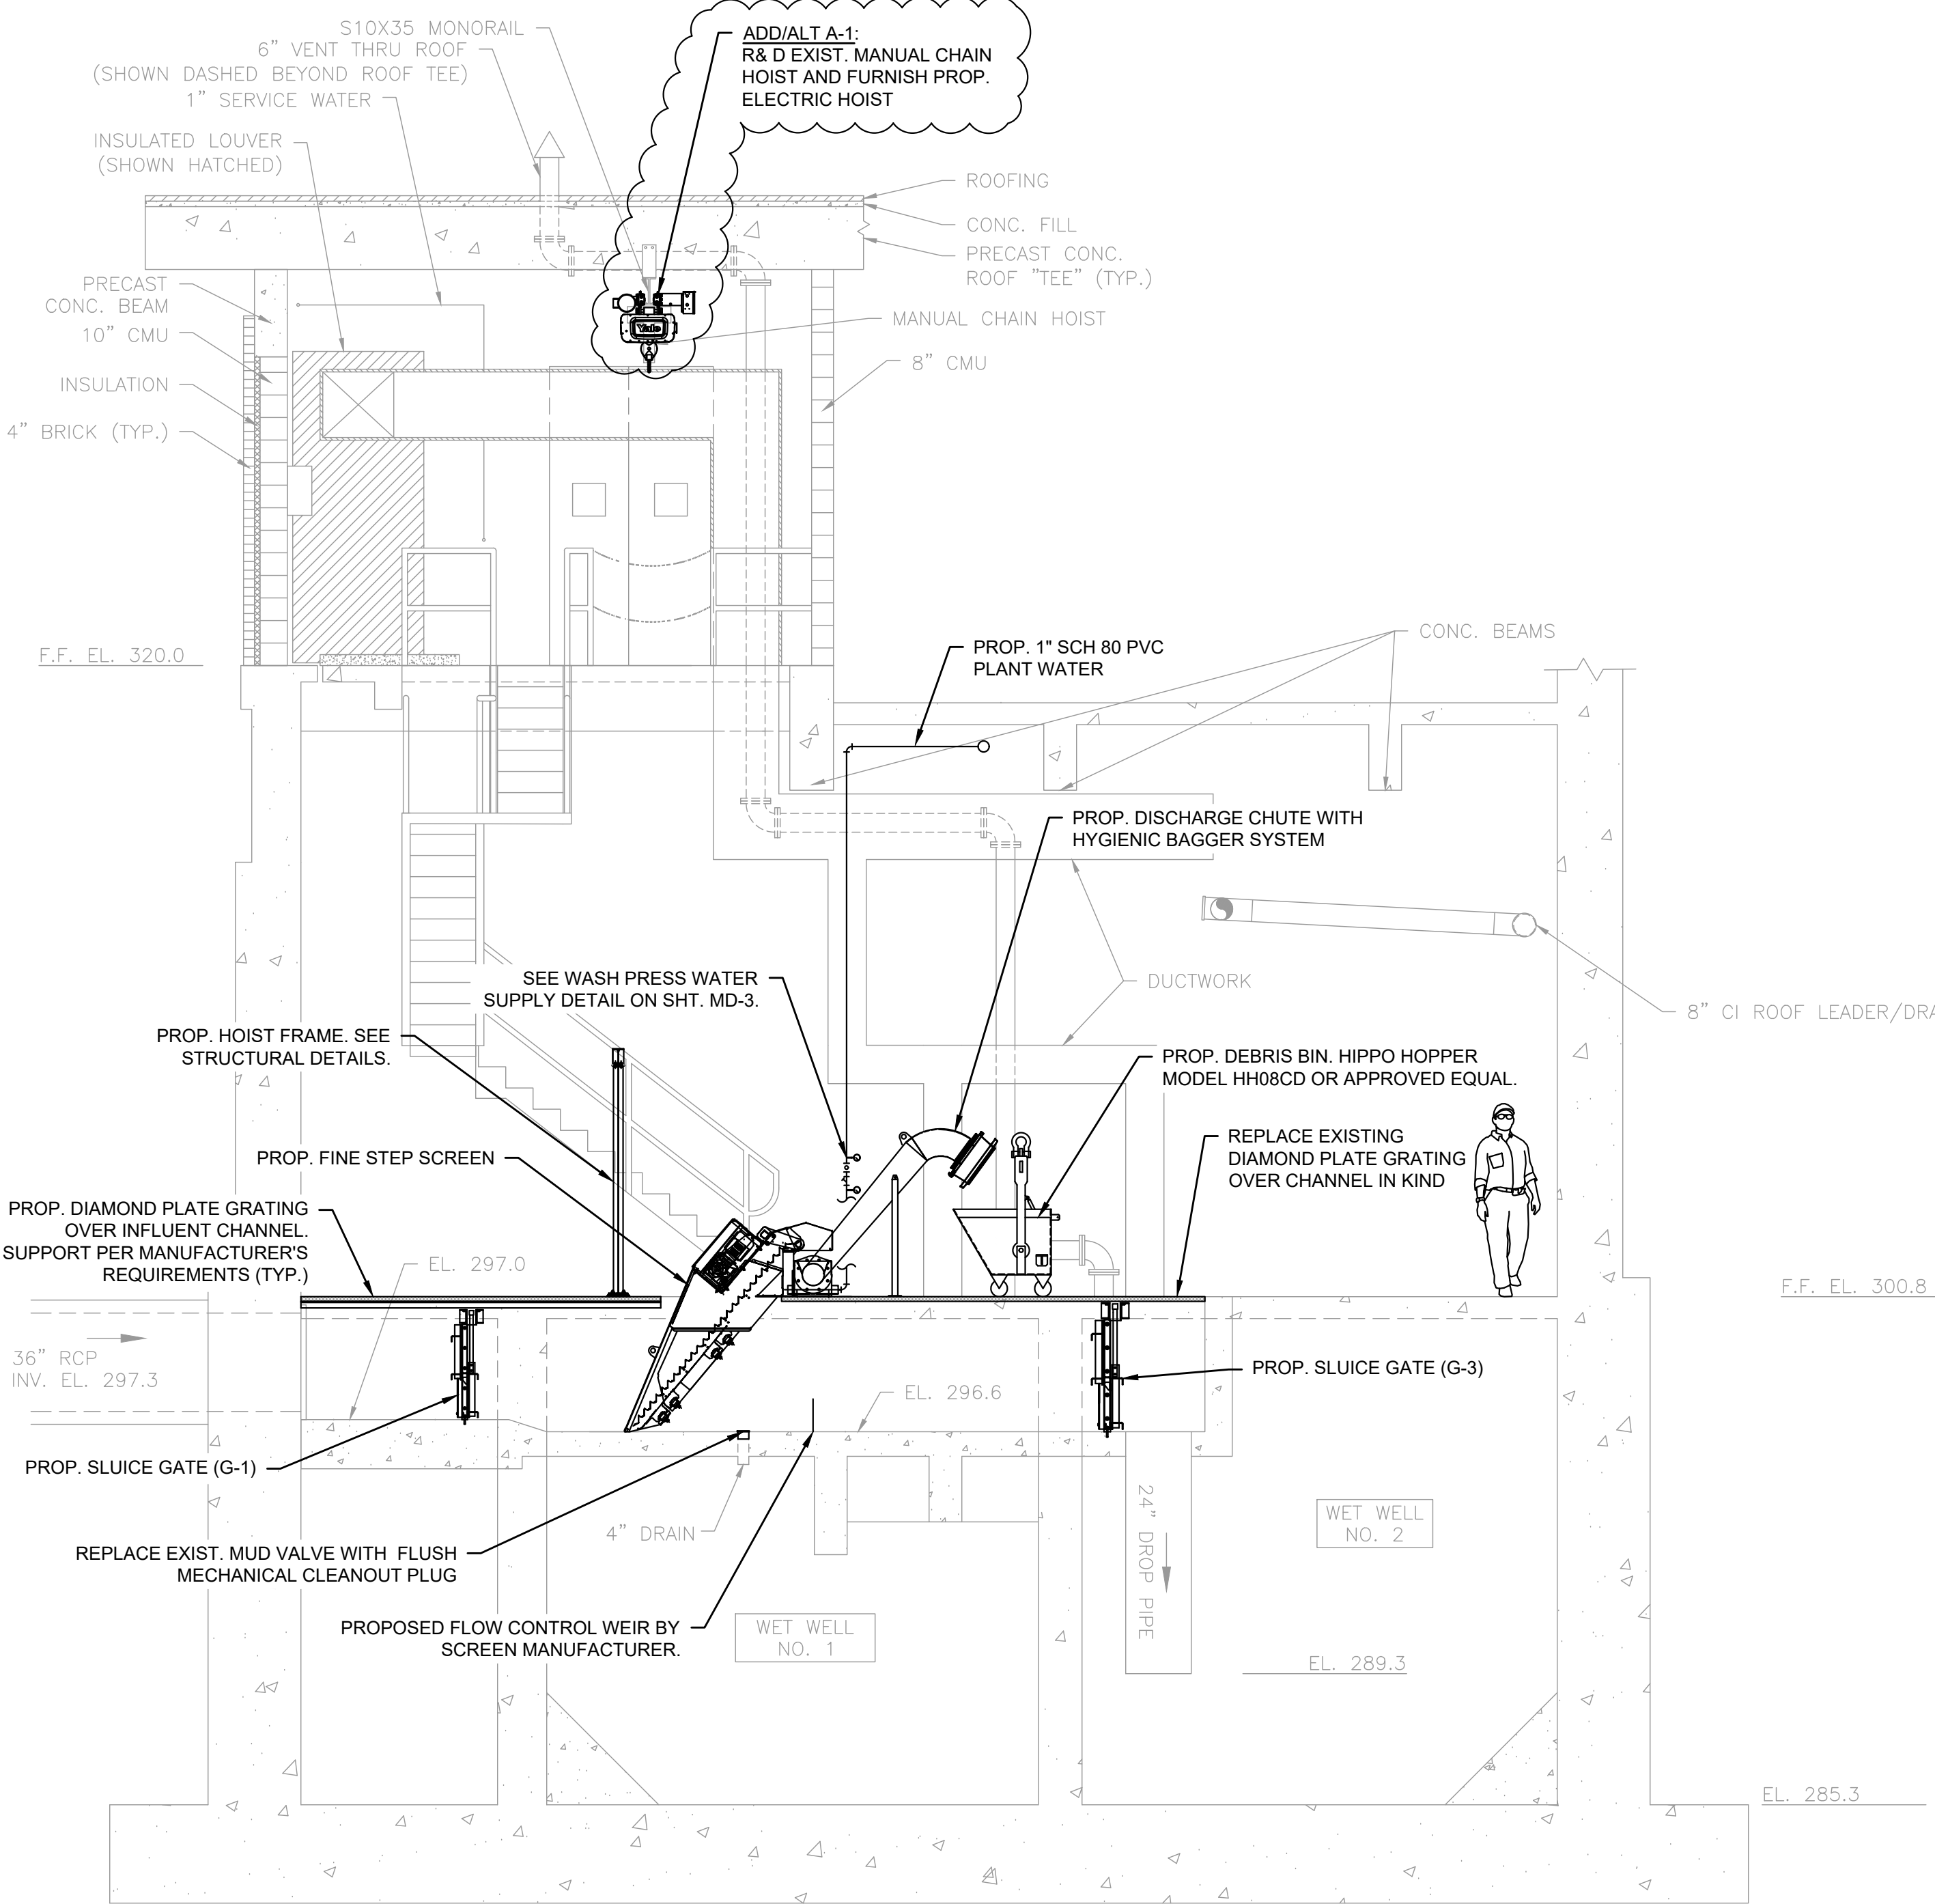


- NOTES:**
1. SEE MECHANICAL DETAIL SHEETS FOR ALL WORK INVOLVING THE MANUAL BAR RACK CHANNEL.
 2. PROPOSED INFLUENT SCREEN, CONVEYOR, AND PLANT WATER PIPING NOT SHOWN FOR CLARITY.

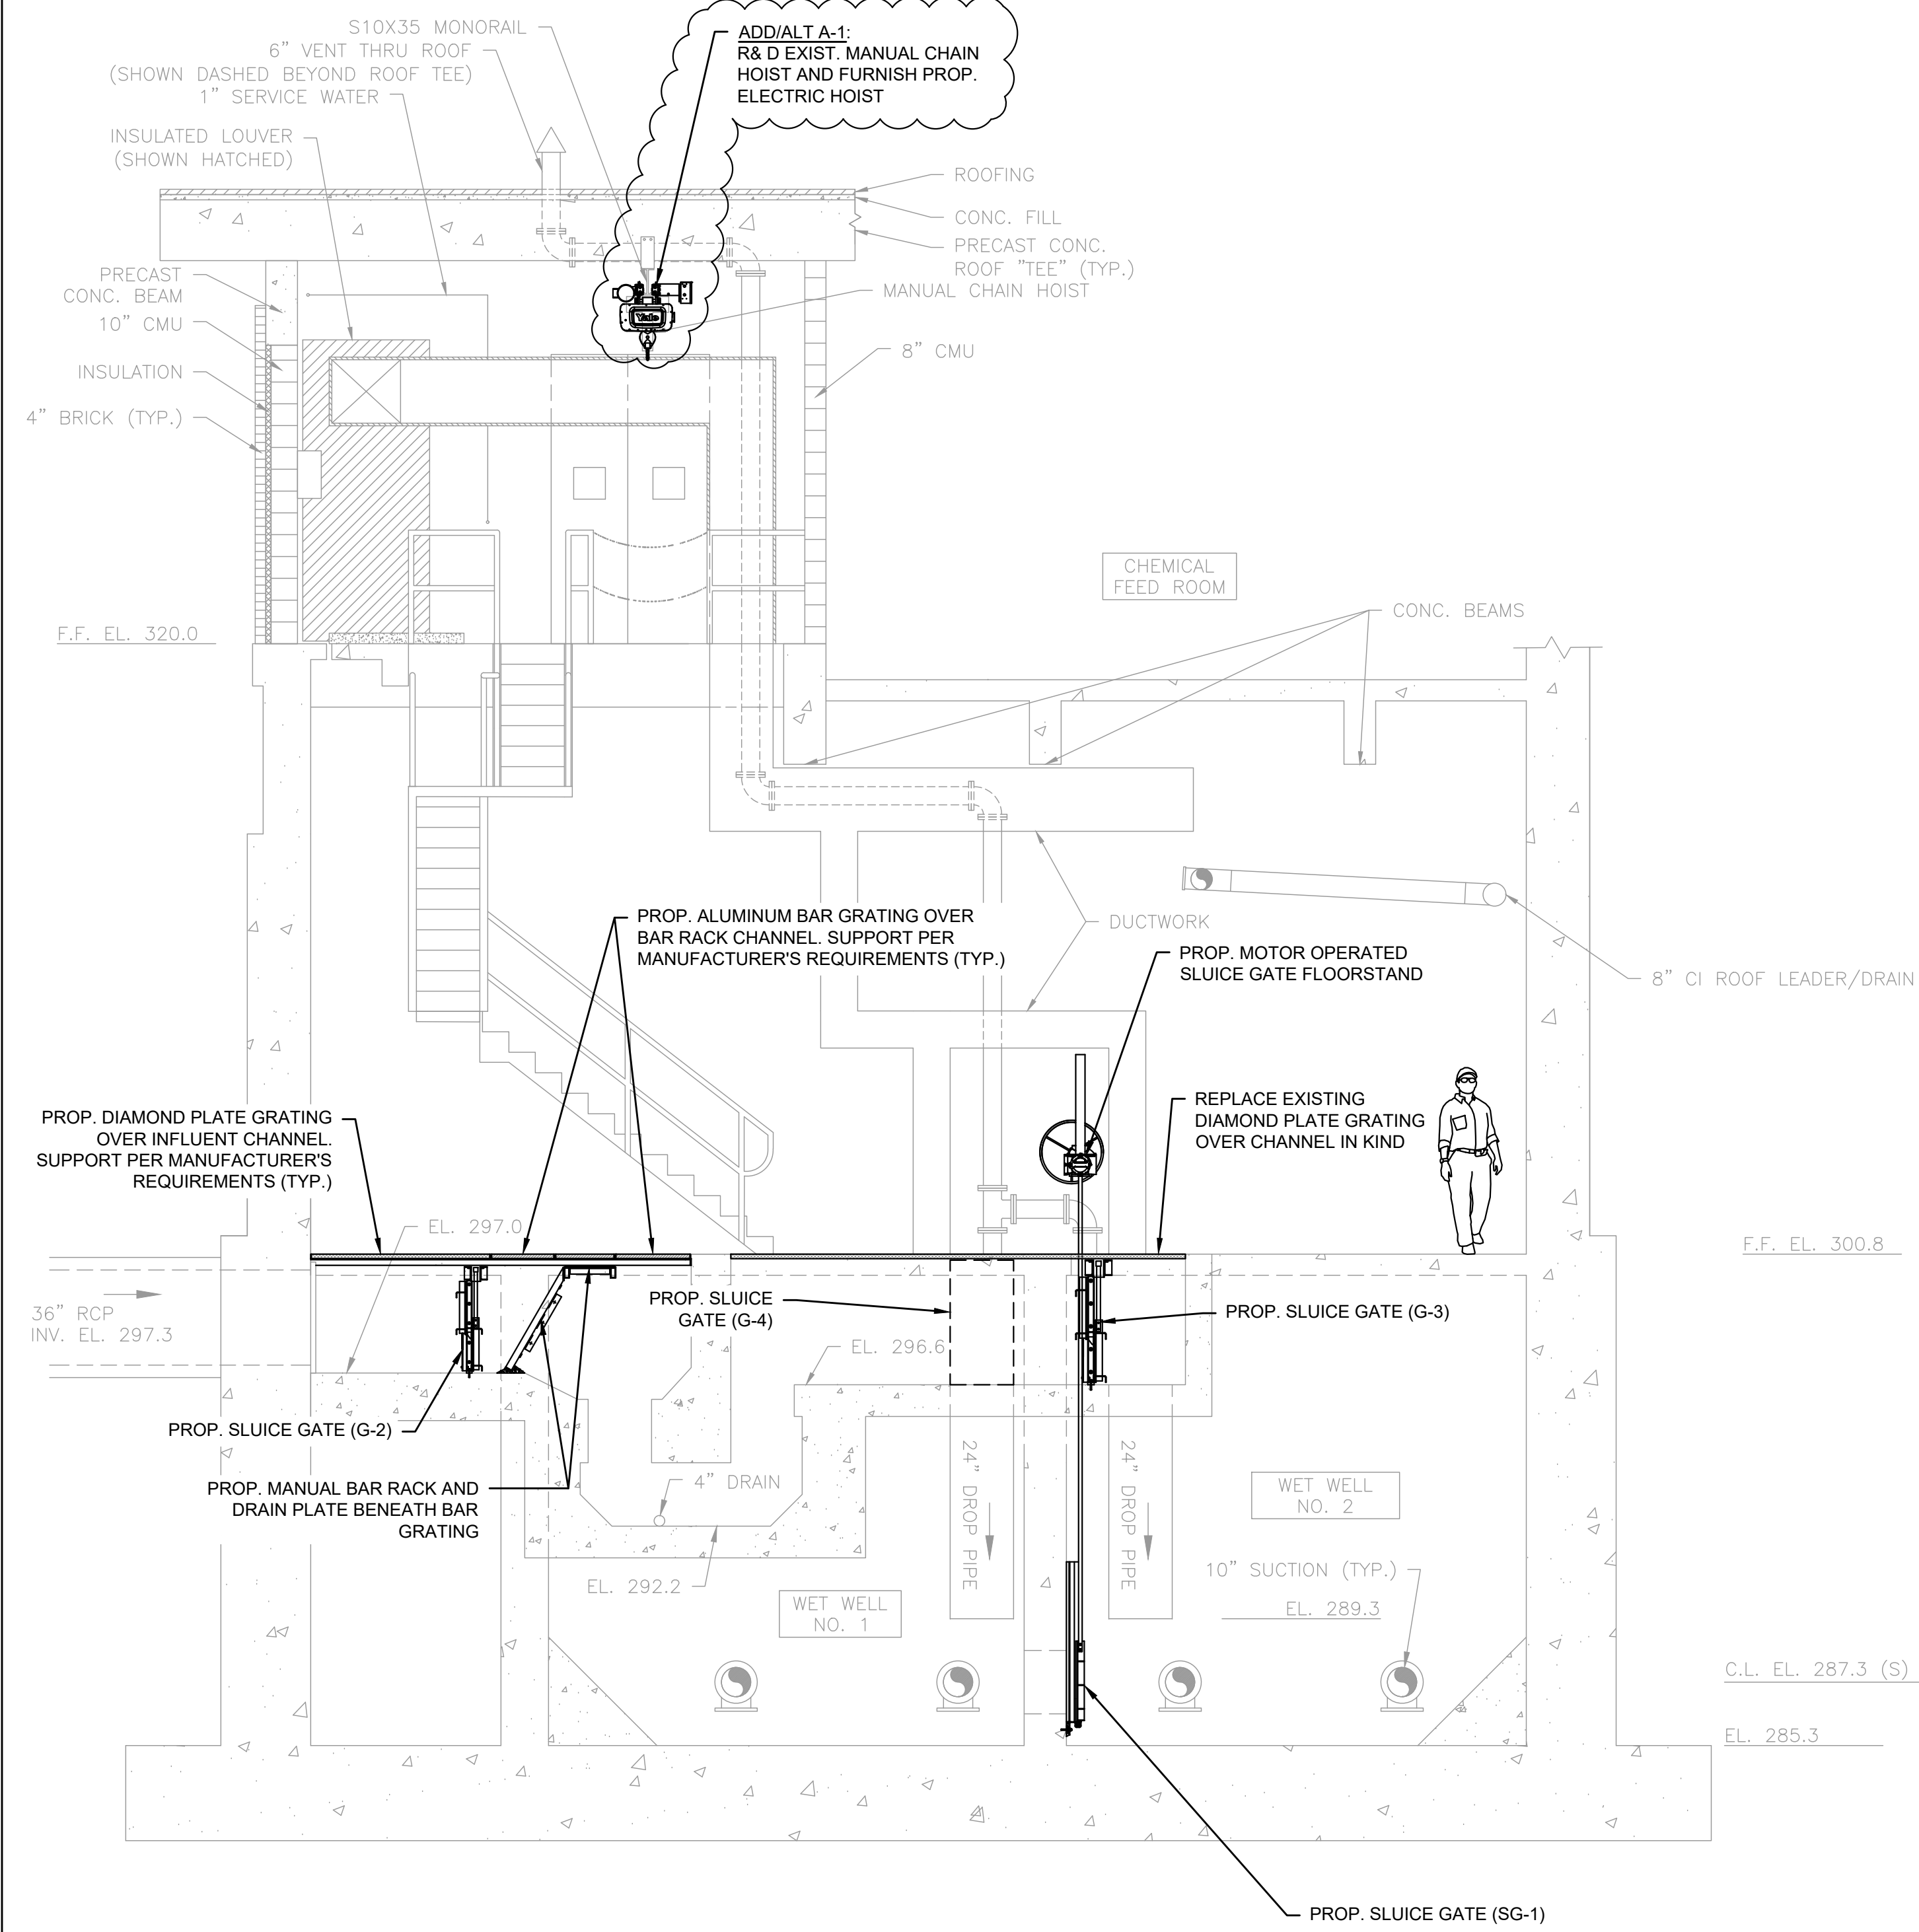PROPOSED SECTION B
SCALE: 1/4" = 1'-0"

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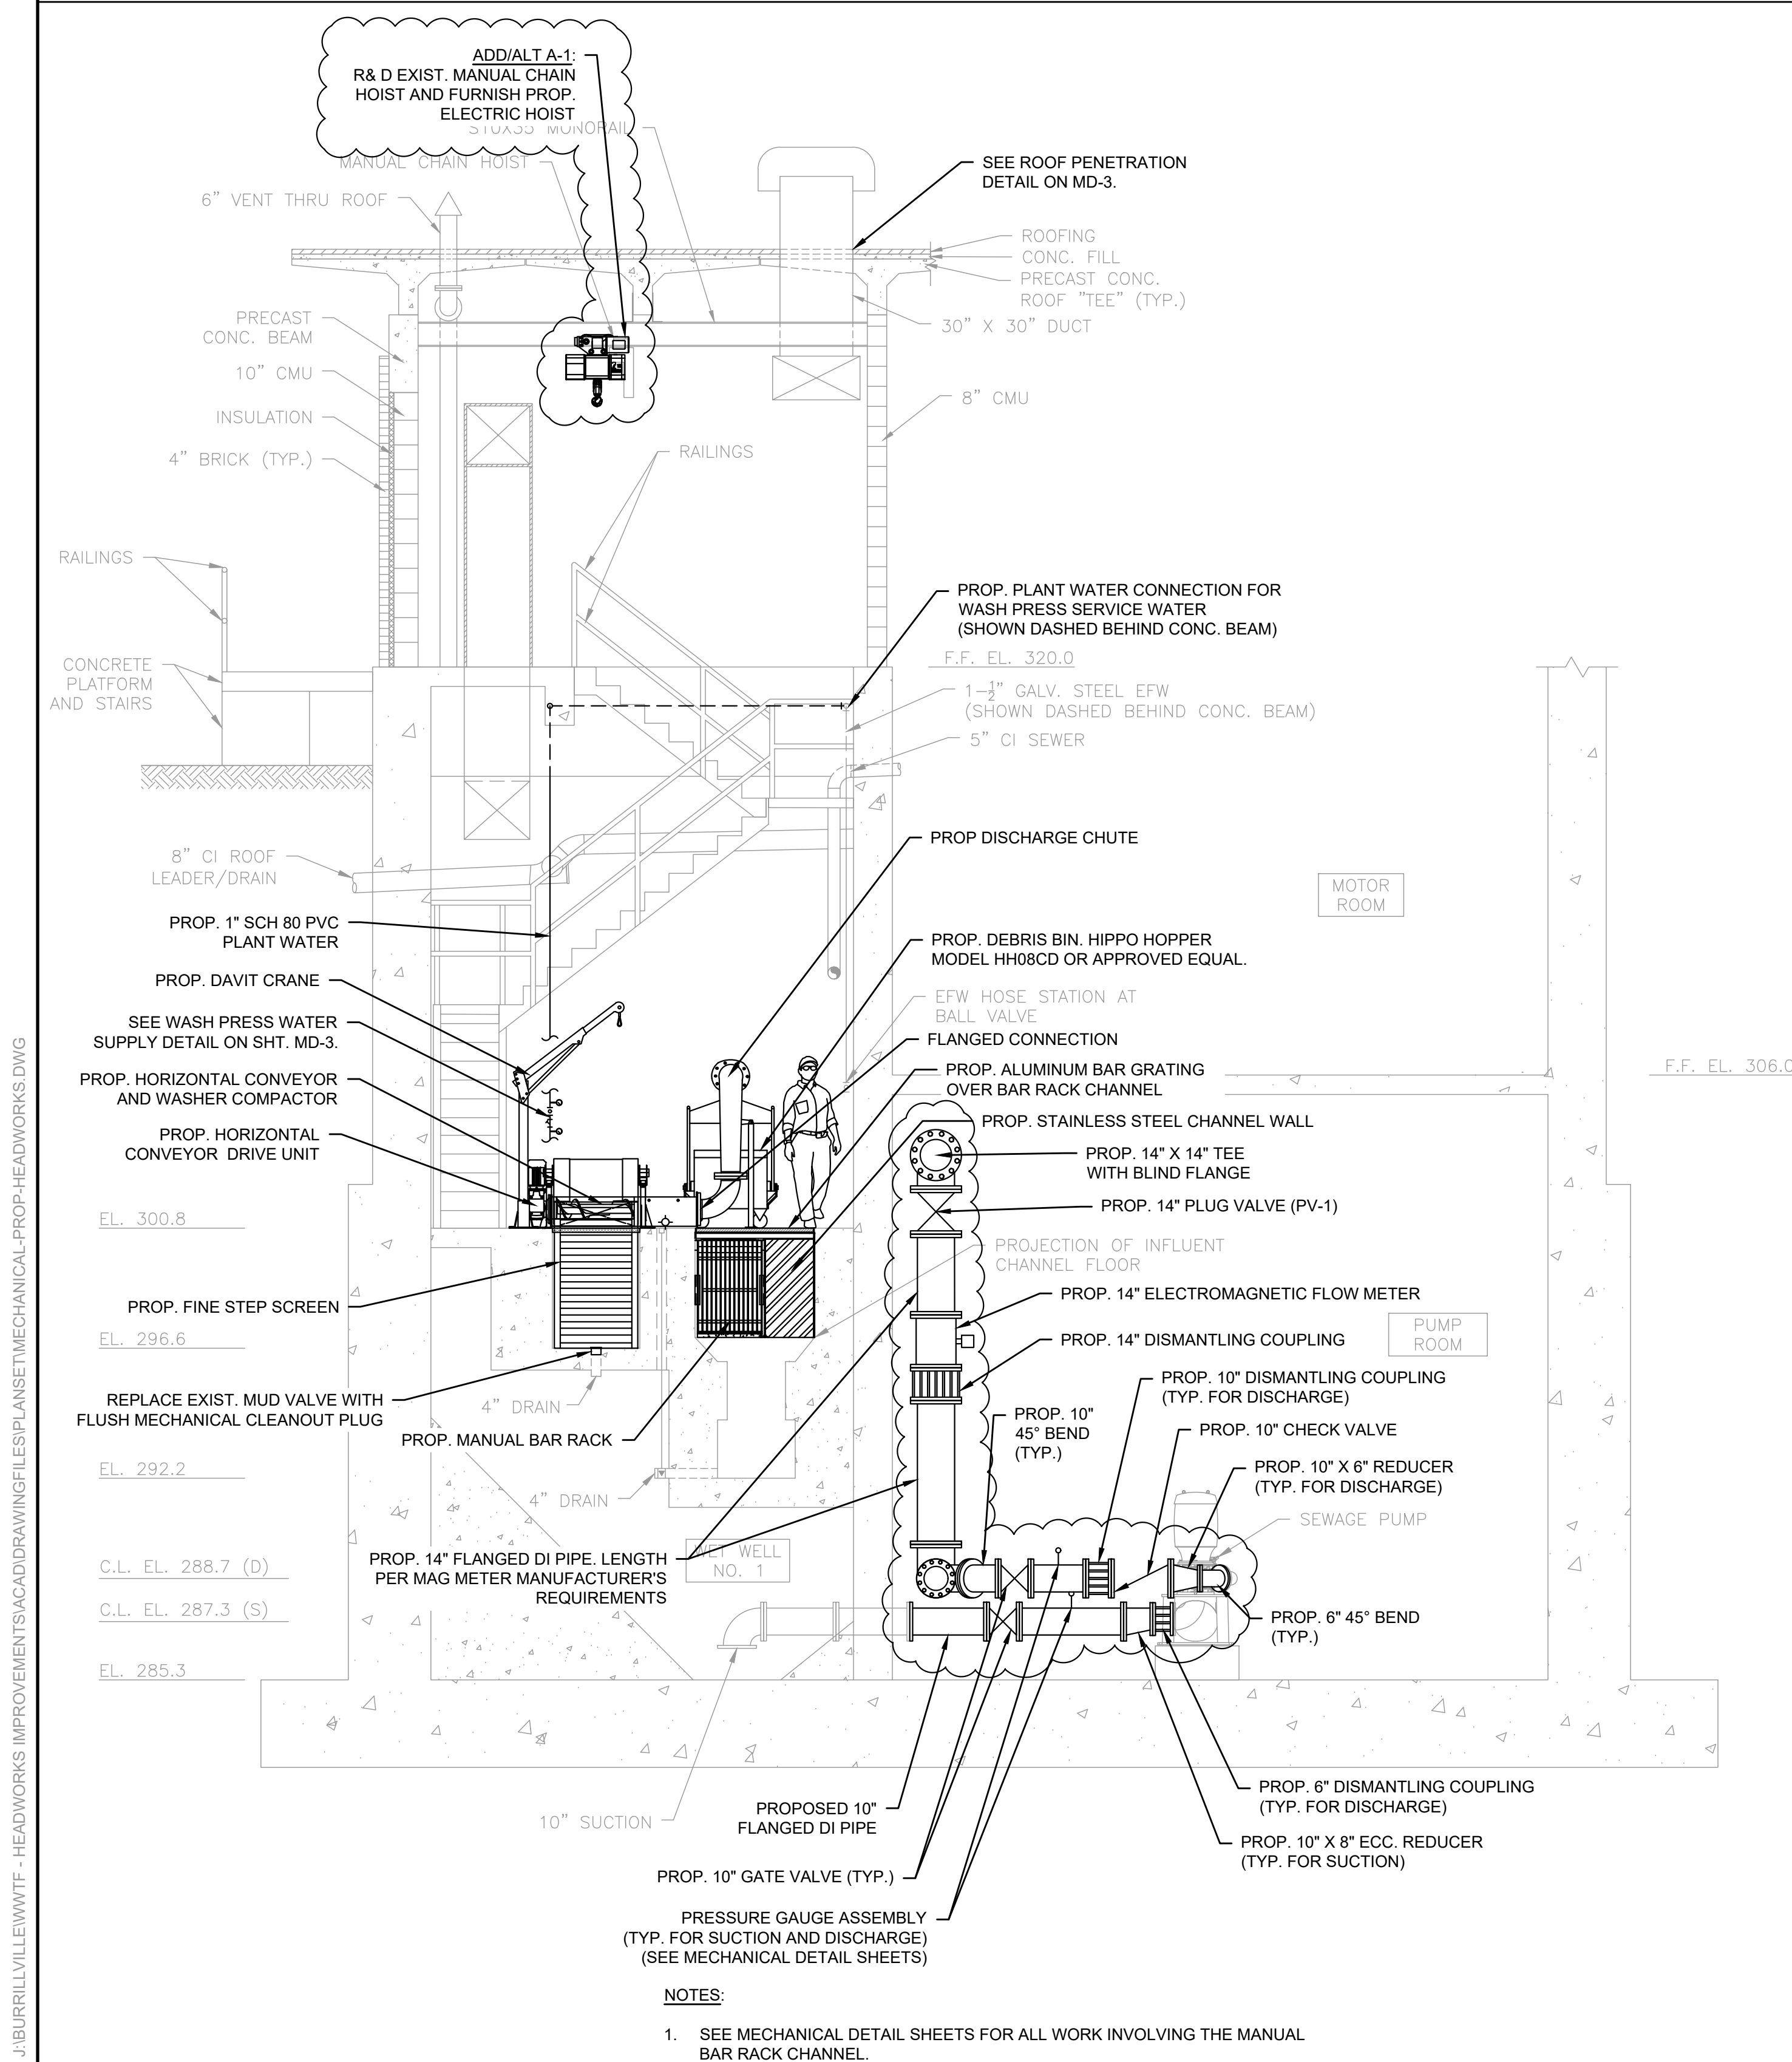
NO.	REVISIONS	DATE

DRAWN BY:	CJM
DESIGNED BY:	AJG
CHECKED BY:	JRD
ISSUE DATE:	MAY 2023
BETA JOB NO.:	6861-105

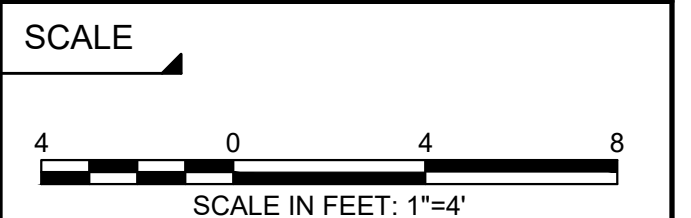


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- GENERAL NOTES:
 INSTALLATION OF NEW EQUIPMENT WITHIN THE HEADWORKS BUILDING IS BROKEN DOWN INTO THE FOLLOWING BASE BID WITH ADD/ALTERNATES:
1. **BASE BID ITEM 1:** INSTALL THE PROPOSED MANUAL BAR RACK, SLUICE GATES, NEW GRATING AND GRATING MODIFICATIONS, DEBRIS BIN, ALL OTHER APPURTENANT WORK, AND THE INFLUENT FINE SCREEN WITH SCREENINGS DISCHARGED TO THE LOWER LEVEL.
 - 1.1. PROPOSED WORK UNDER THE BASE BID ITEM IS SHOWN BOLD ON THIS SHEET.
 2. **ADD/ALTERNATE A-1:** REMOVE AND DISPOSE OF THE EXISTING MANUAL CHAIN HOIST AND INSTALL THE PROPOSED ELECTRIC HOIST.
 - 2.1. PROPOSED WORK UNDER THIS ADD/ALTERNATE ITEM IS NOT SHOWN THIS SHEET.
 3. **ADD/ALTERNATE A-2:** INSTALL THE PROPOSED VERTICAL CONVEYOR WITH SCREENINGS DISCHARGED TO THE UPPER LEVEL AND THE PROPOSED UPPER LEVEL PLATFORM.
 - 3.1. PROPOSED WORK UNDER THIS ADD/ALTERNATE ITEM IS NOT SHOWN THIS SHEET.
 4. **ADD/ALTERNATE A-3:** REMOVE, DISPOSE, AND REPLACEMENT OF PIPING & APPURTENANCES AS SHOWN IN THE PUMP ROOM.
 - 4.1. PROPOSED WORK UNDER THIS ADD/ALTERNATE ITEM IS SHOWN BOLD WITHIN A REV CLOUD ON THIS SHEET.



PROPOSED SECTION C
 SCALE: 1/4" = 1'-0"

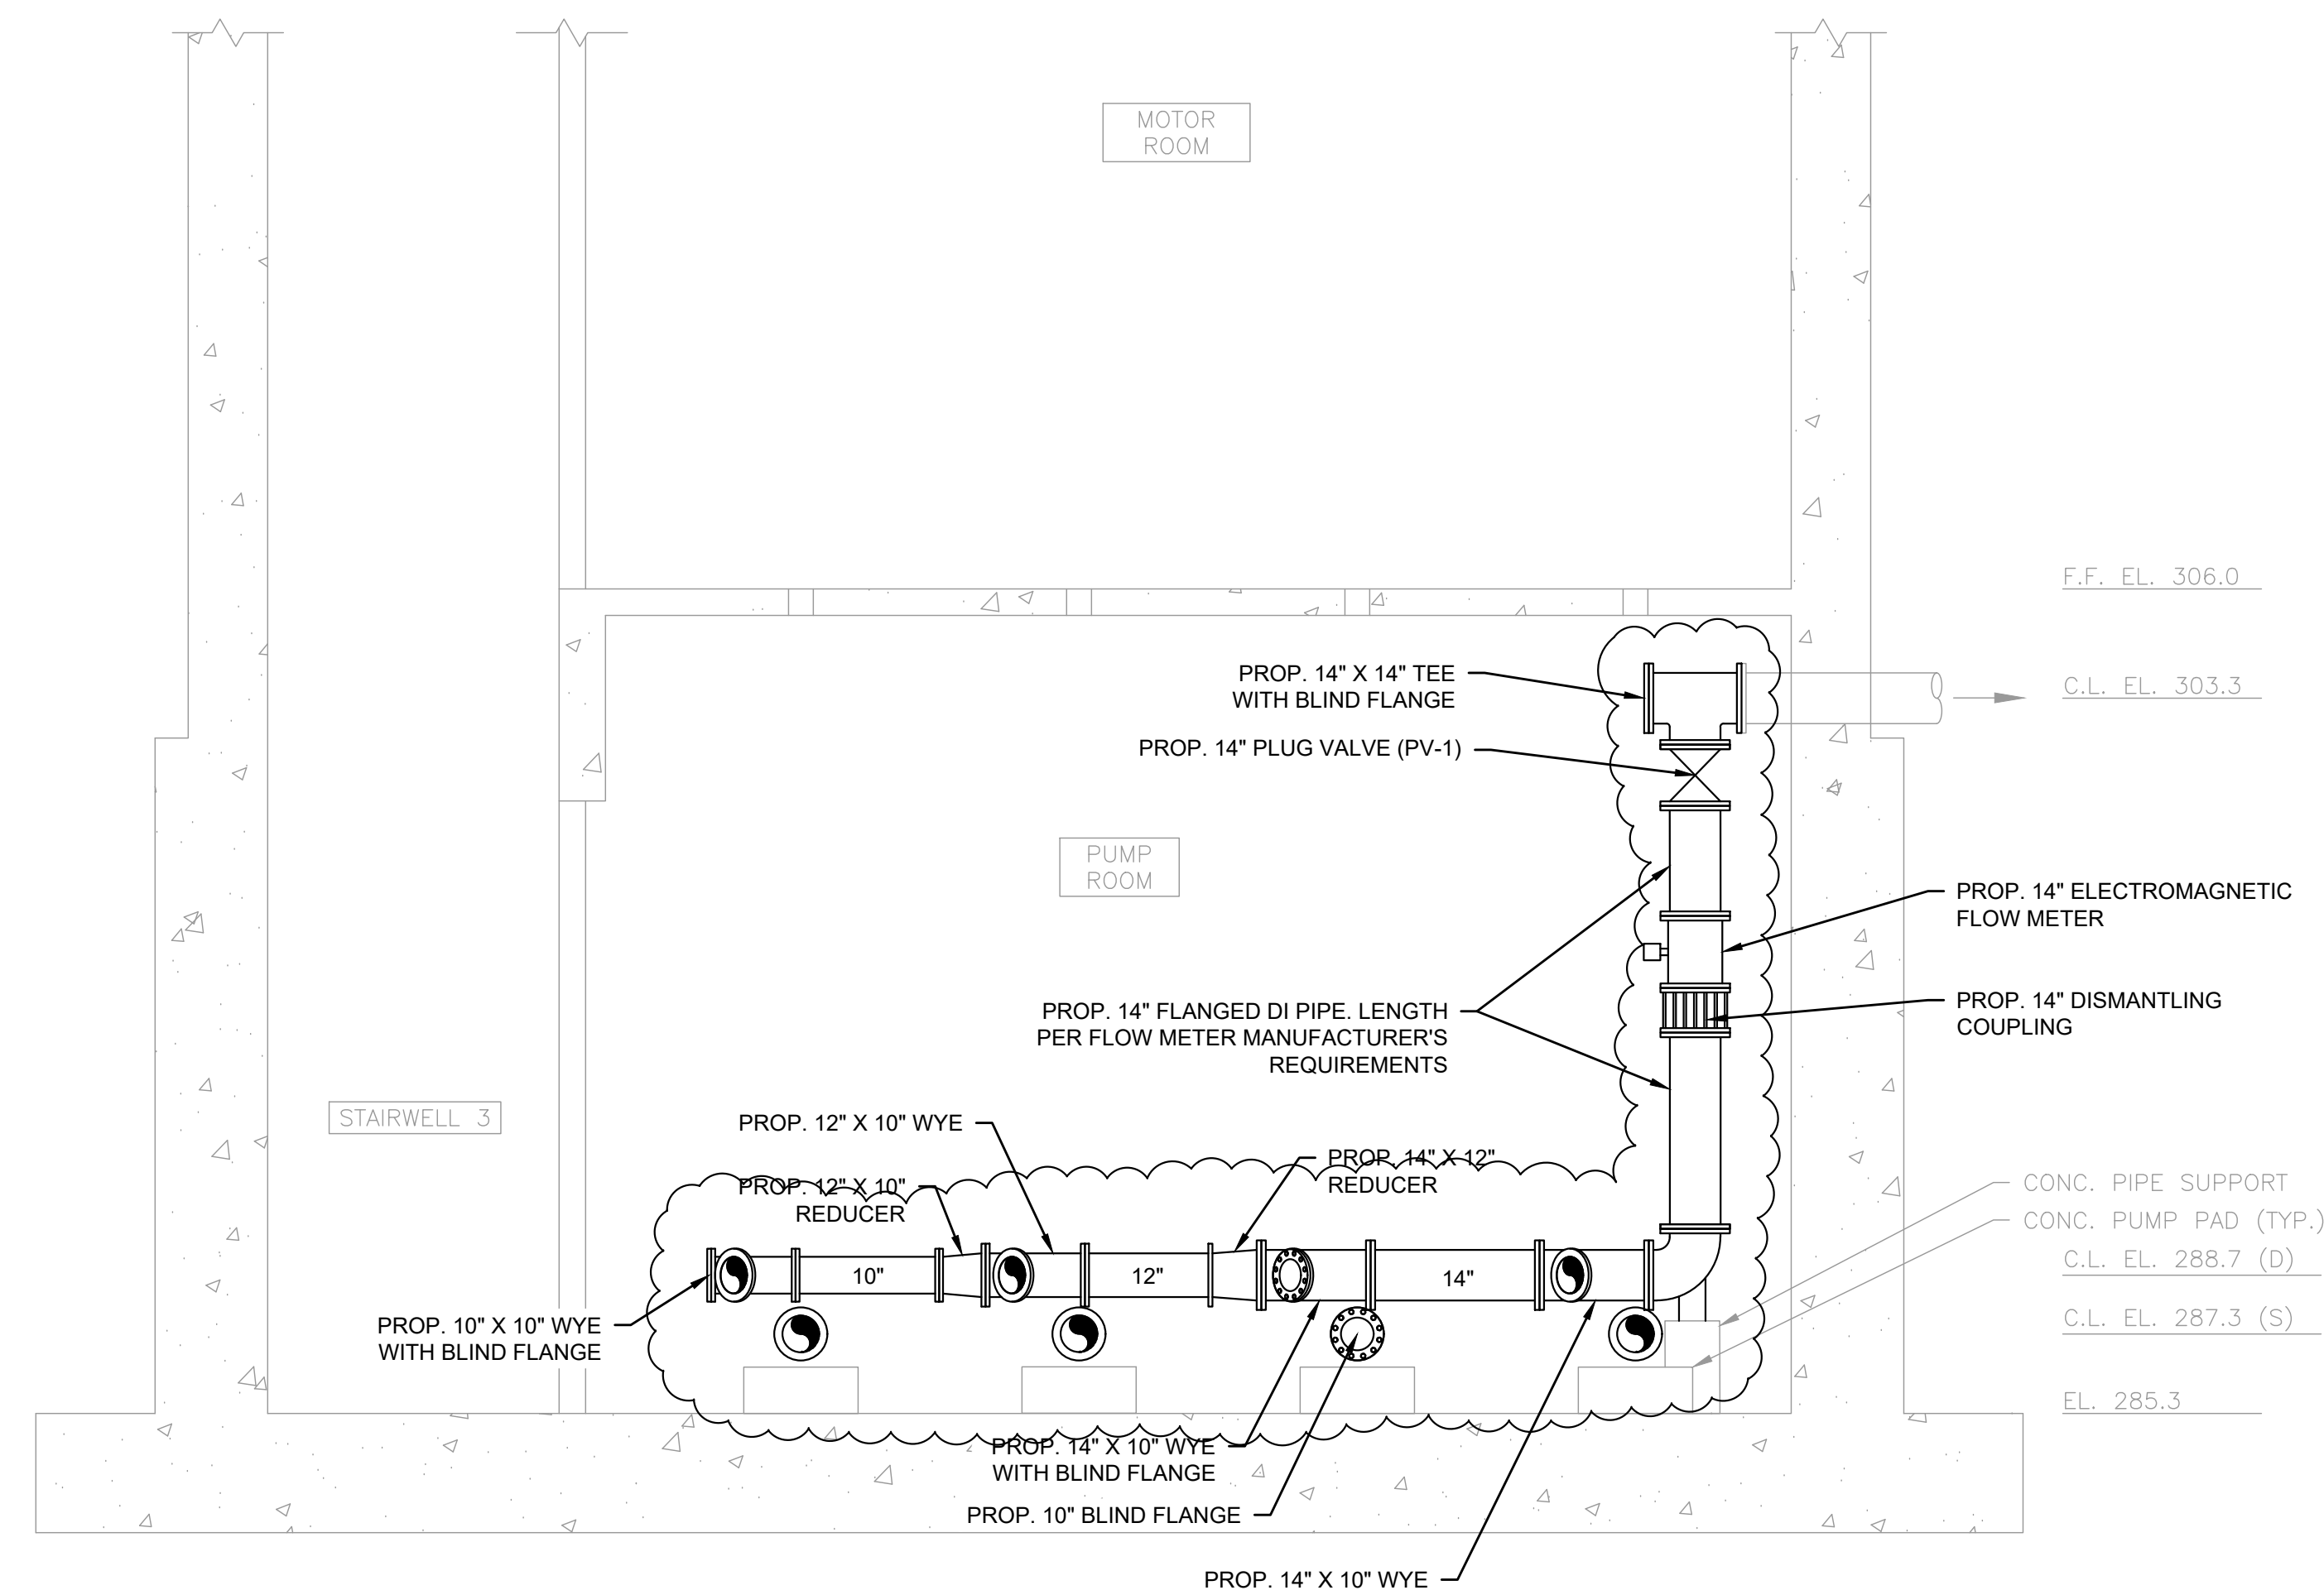

PROPOSED SECTION D
 SCALE: 1/4" = 1'-0"

GENERAL NOTES:


INSTALLATION OF NEW EQUIPMENT WITHIN THE HEADWORKS BUILDING IS BROKEN DOWN INTO THE FOLLOWING BASE BID WITH ADD/ALTERNATES:

1. **BASE BID ITEM 1:** INSTALL THE PROPOSED MANUAL BAR RACK, SLUICE GATES, NEW GRATING AND GRATING MODIFICATIONS, DEBRIS BIN, AND, ALL OTHER APPURTENANT WORK, AND THE INFLUENT FINE SCREEN WITH SCREENINGS DISCHARGED TO THE LOWER LEVEL.
 - 1.1. PROPOSED WORK UNDER THE BASE BID ITEM IS SHOWN SCREENED THIS SHEET.
2. **ADD/ALTERNATE A+1:** REMOVE AND DISPOSE OF THE EXISTING MANUAL CHAIN HOIST AND INSTALL THE PROPOSED ELECTRIC HOIST.
 - 2.1. PROPOSED WORK UNDER THIS ADD/ALTERNATE ITEM IS NOT SHOWN THIS SHEET.
3. **ADD/ALTERNATE A-2:** INSTALL THE PROPOSED VERTICAL CONVEYOR WITH SCREENINGS DISCHARGED TO THE UPPER LEVEL AND THE PROPOSED UPPER LEVEL PLATFORM.
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4. **ADD/ALTERNATE A-3:** REMOVE, DISPOSE, AND REPLACEMENT OF PIPING & APPURTENANCES AS SHOWN IN THE PUMP ROOM.
 - 4.1. PROPOSED WORK UNDER THIS ADD/ALTERNATE ITEM IS NOT SHOWN ON THIS SHEET..

PREPARED BY



REGISTERED PROFESSIONAL

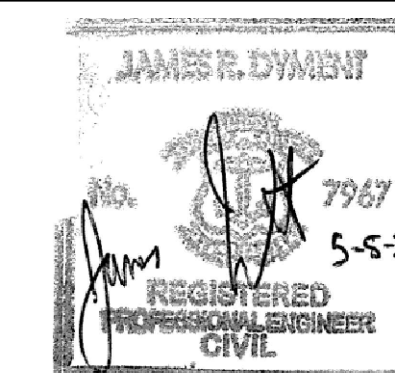

SUBCONSULTANT

PROJECT

**BURRILLVILLE WWTF
HEADWORKS &
OAKLAND PUMP
STATION
IMPROVEMENTS**

BURRILLVILLE, RI

TITLE

**HEADWORKS -
PROPOSED PLANS
(ADD-ALTERNATE
A-2)**

NO.	REVISIONS	DATE

DRAWN BY: CJM

DESIGNED BY: AJG

CHECKED BY: JRD

ISSUE DATE: MAY 2023

BETA JOB NO.: 6861-105

SCALE





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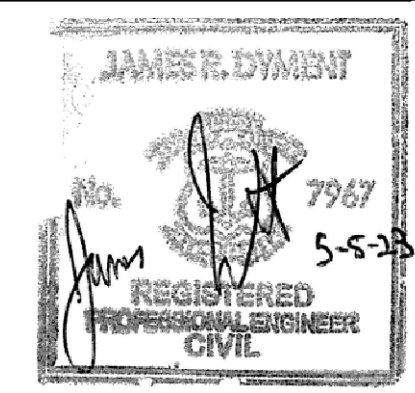
SHEET NO.

M-2.1

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SEWER SERVICE FOR ENTIRE OPERATIONS BUILDING DISCHARGES TO THE INFLUENT CHANNEL. THE CONTRACTOR IS RESPONSIBLE FOR COLLECTING AND TRANSPORTING FLOW TO THE GRIT CHAMBER FOR TREATMENT.



**BURRILLVILLE WWTF
HEADWORKS &
OAKLAND PUMP
STATION
IMPROVEMENTS**

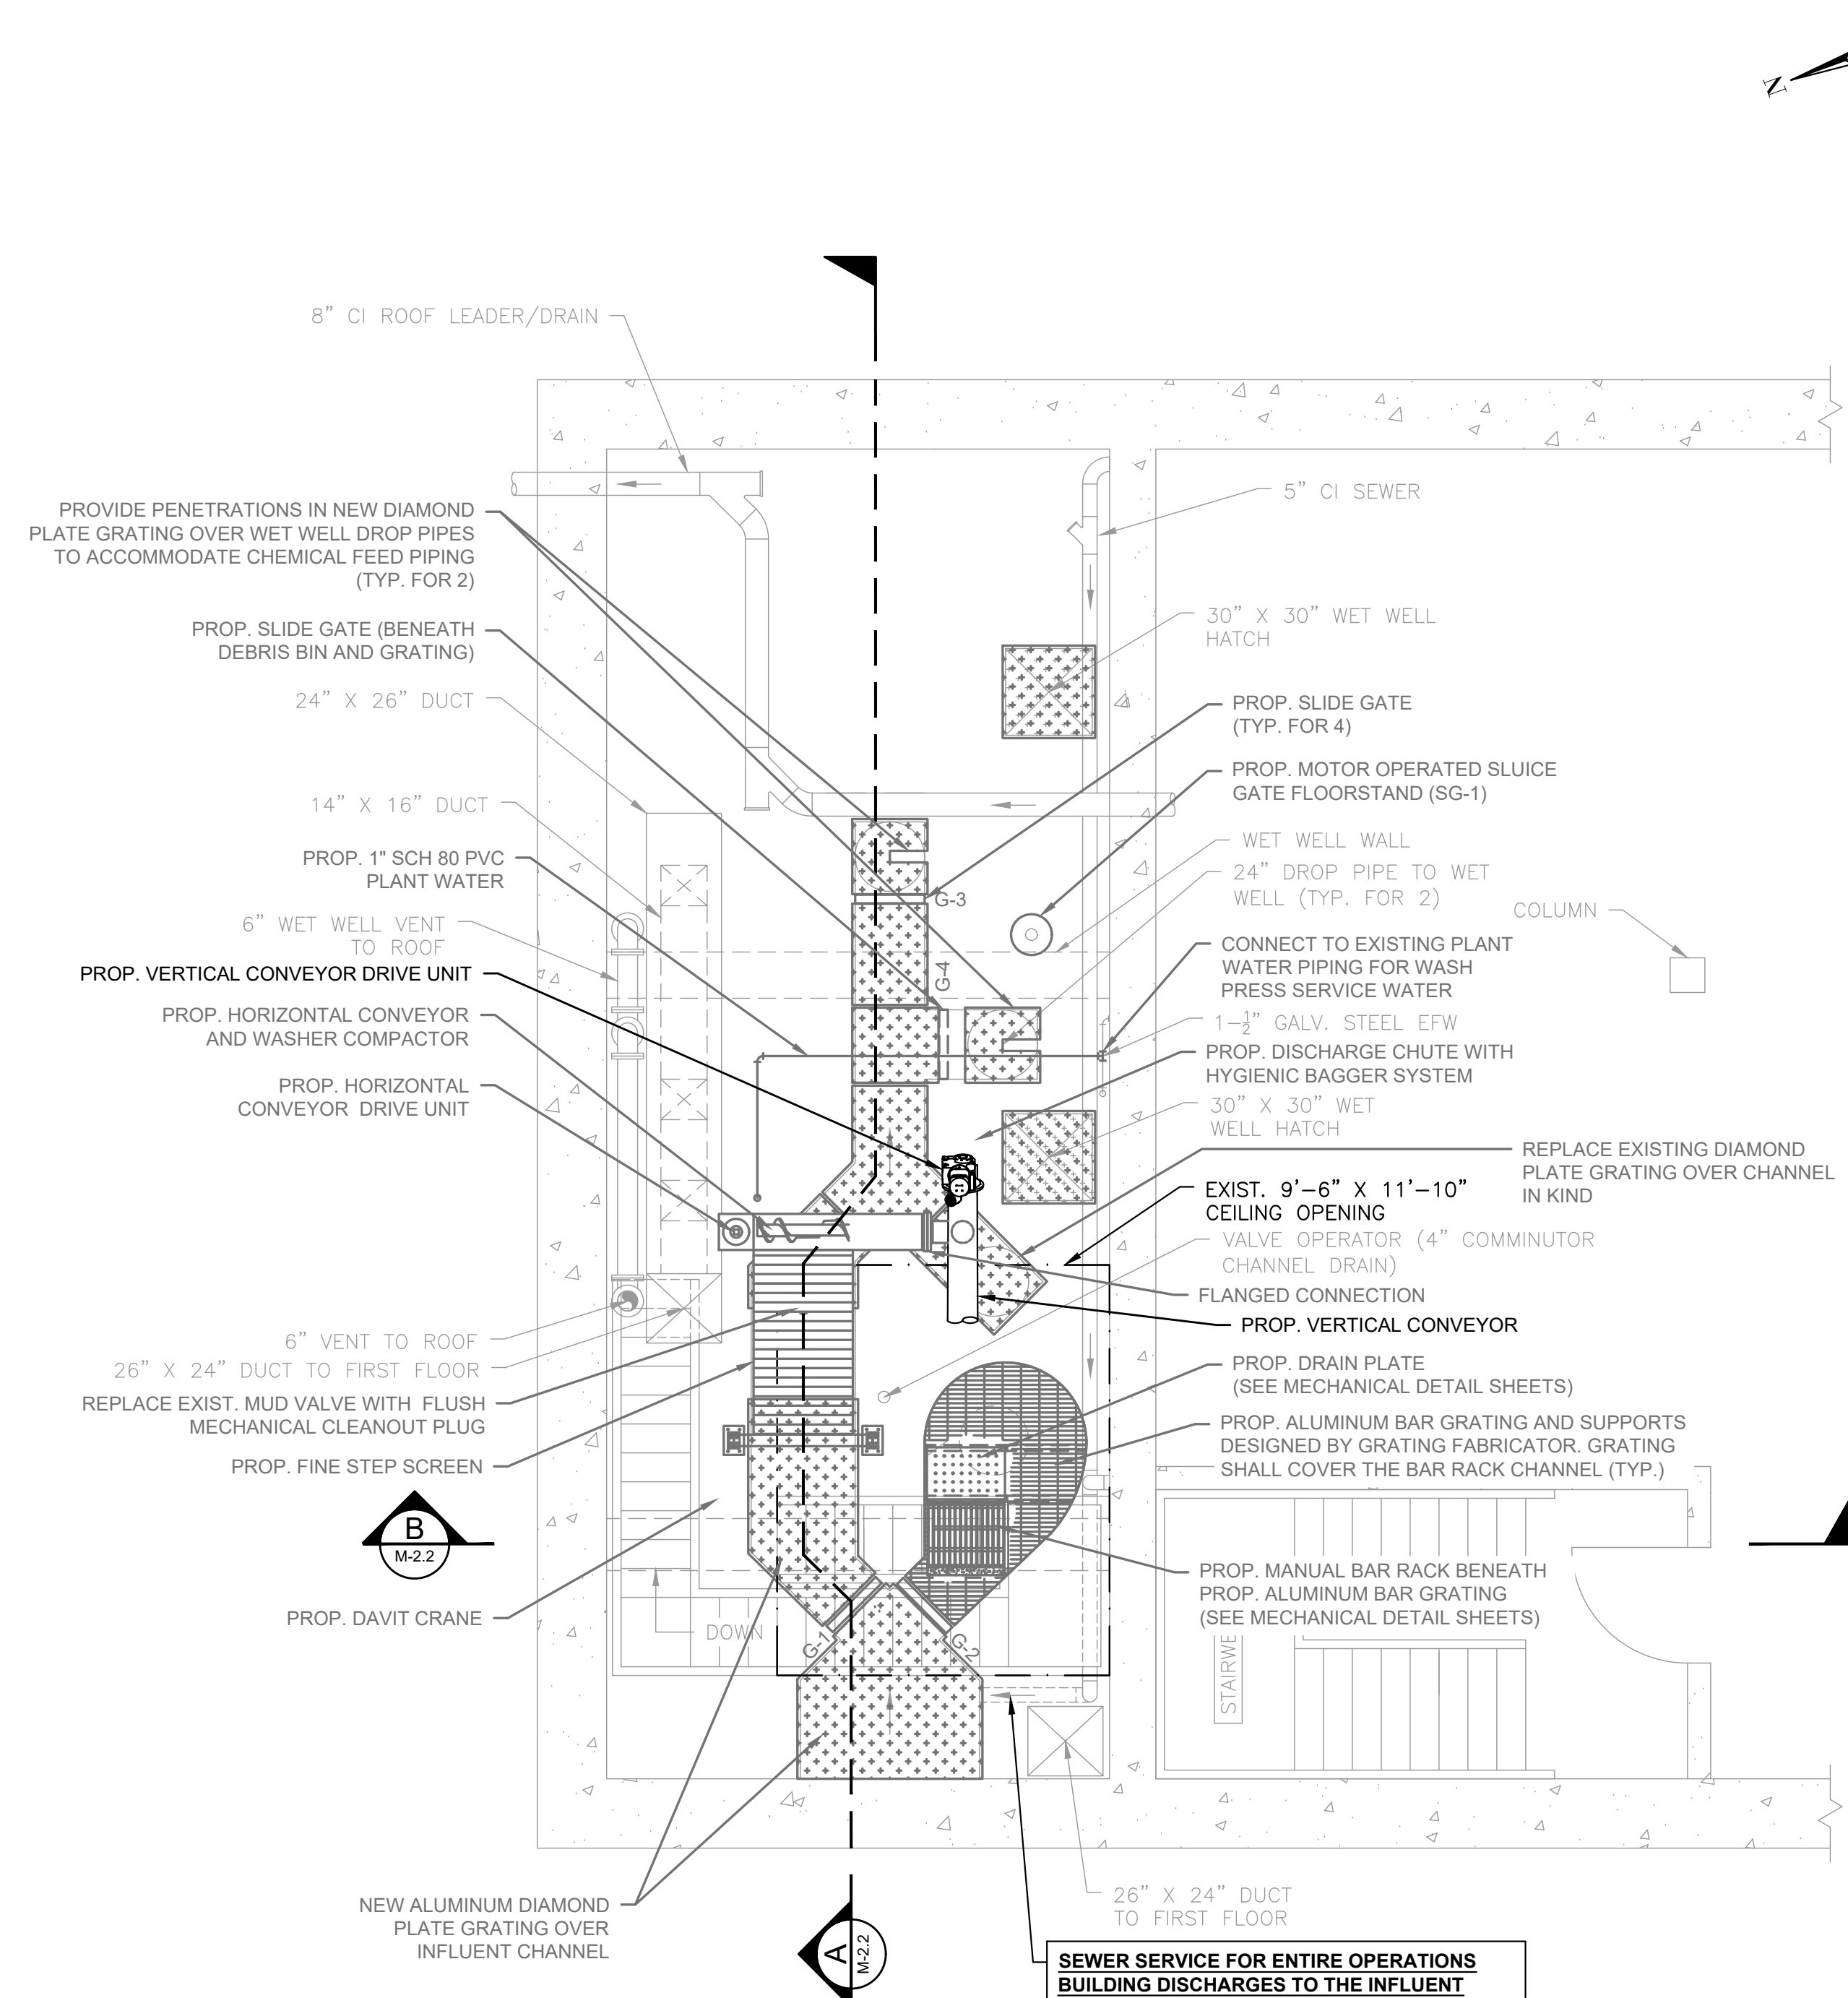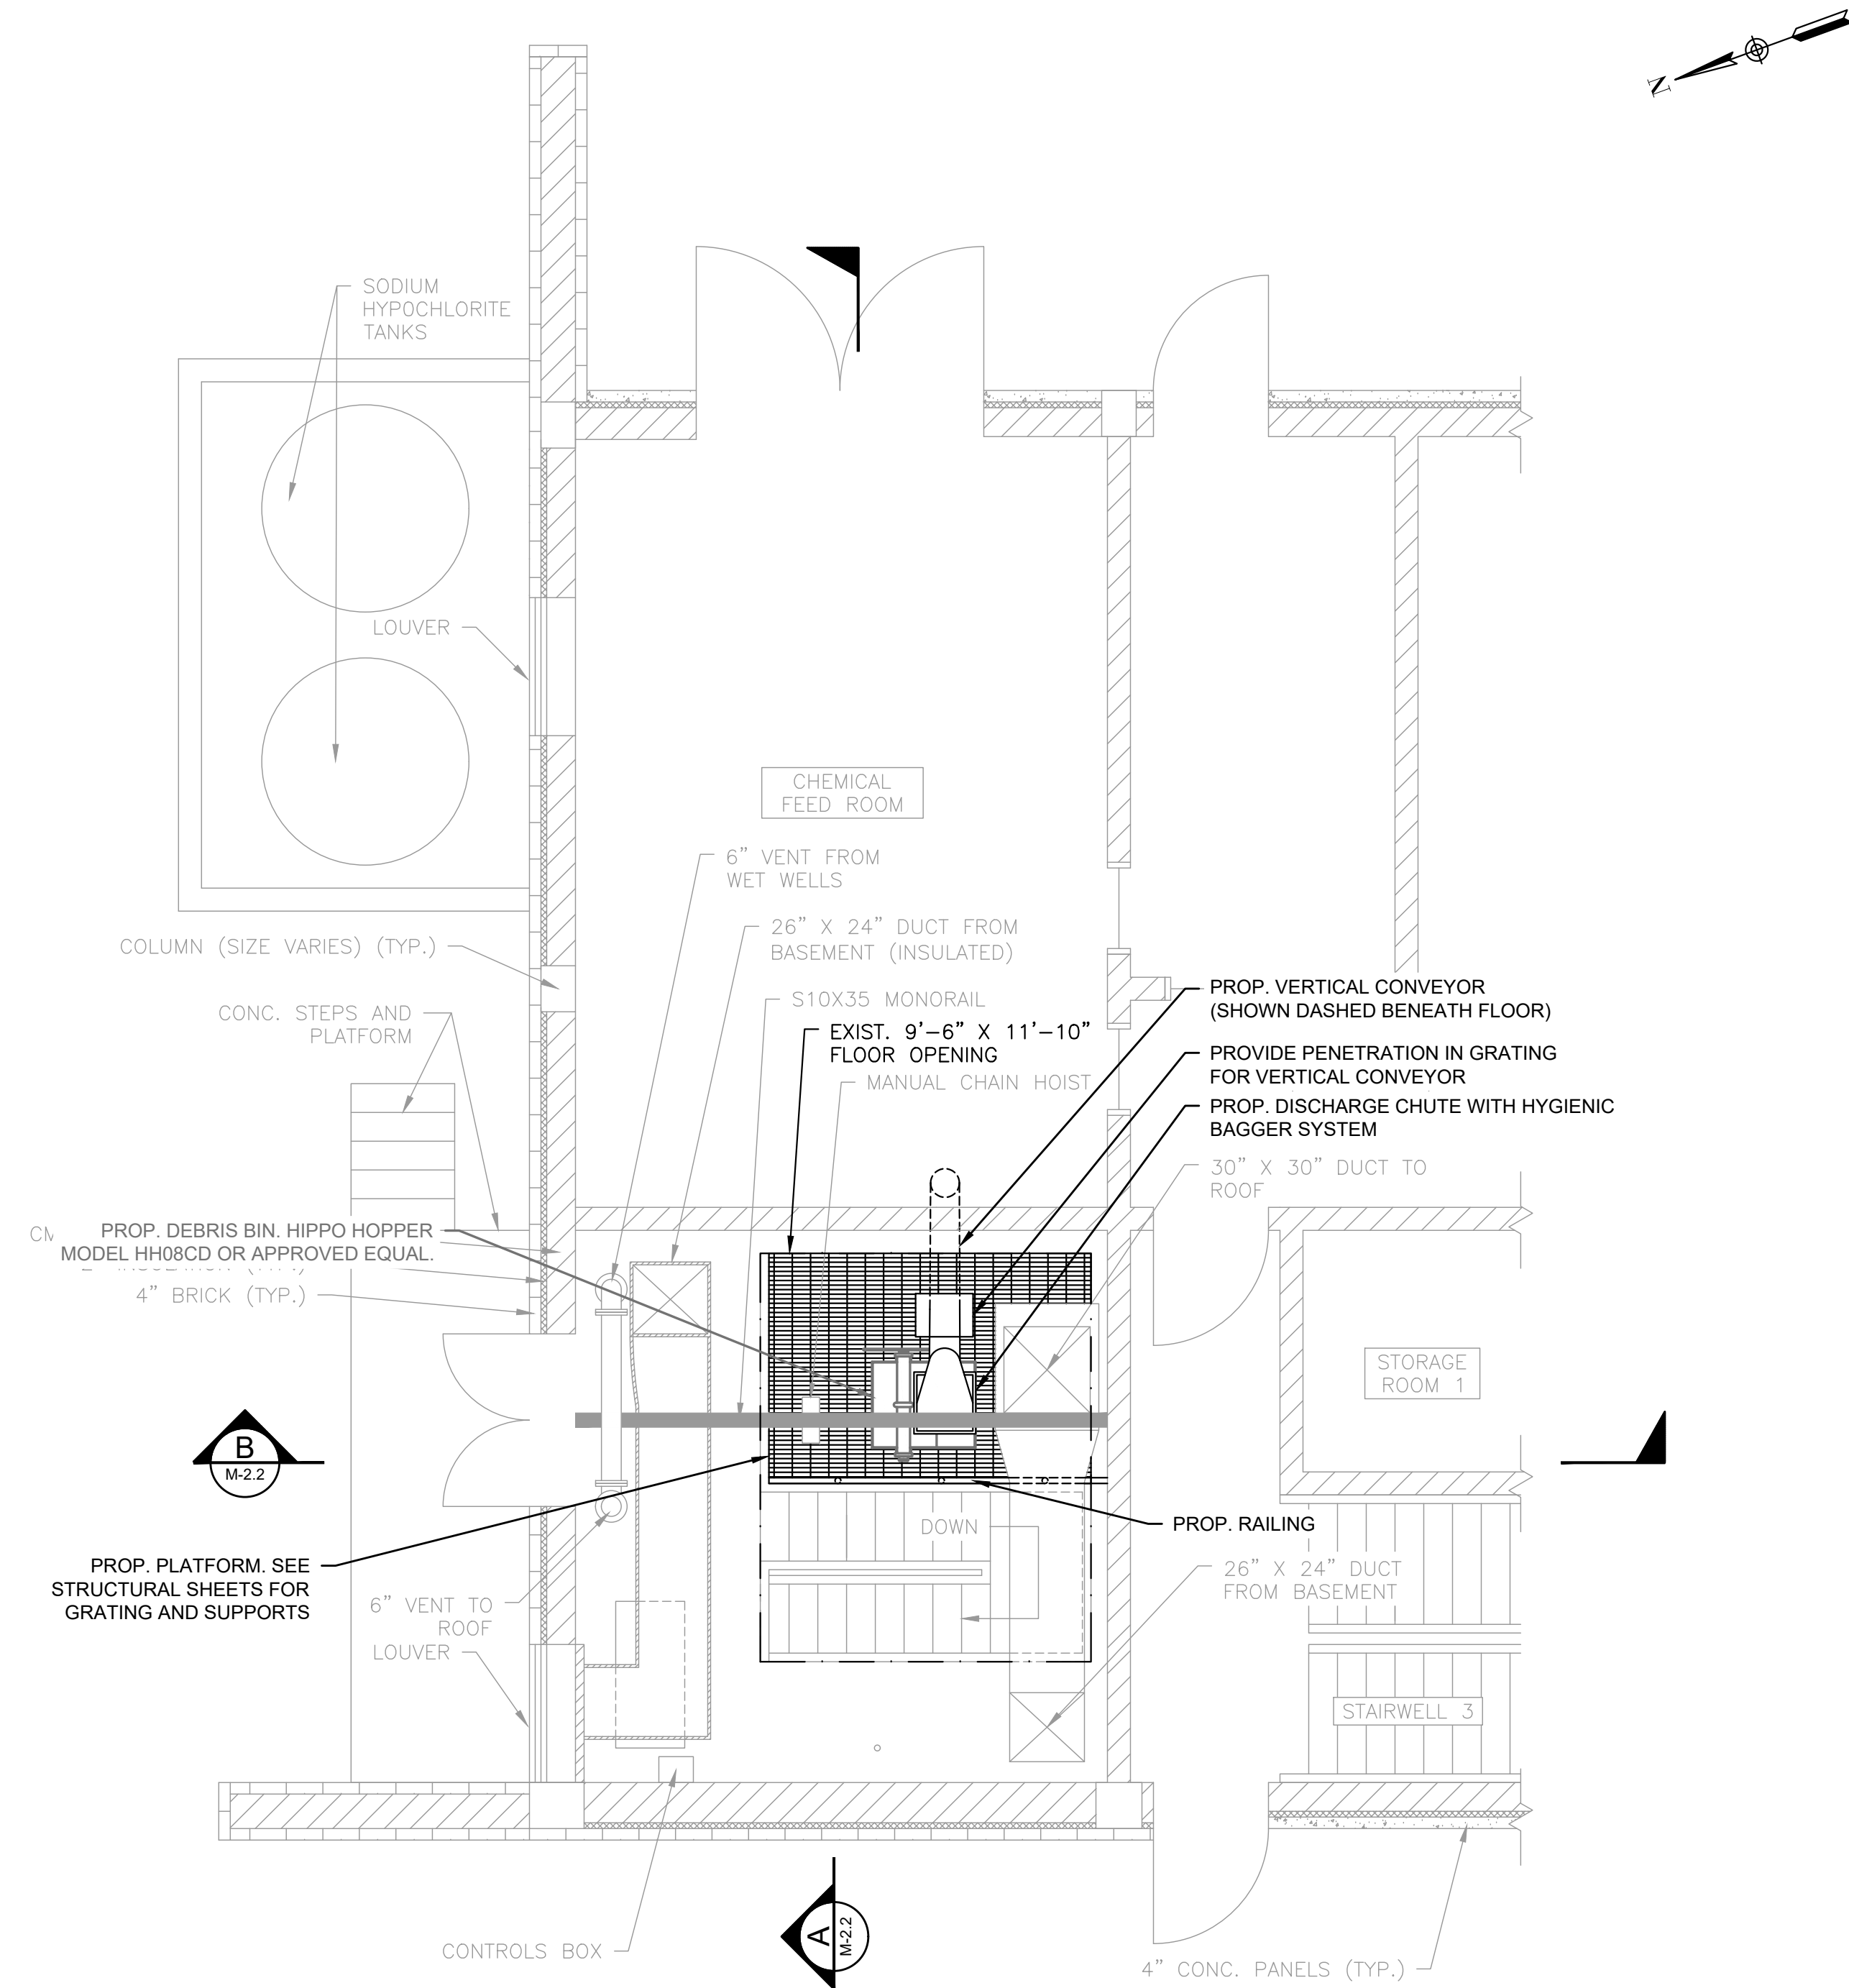**OAKLAND PS -
DEMOLITION
PLAN & SECTION**

NO.	REVISIONS	DATE

DRAWN BY:	CJM
DESIGNED BY:	AJG
CHECKED BY:	JRD
ISSUE DATE:	MAY 2023
BETA JOB NO.:	6861-105

SCALE


SCALE IN FEET: 1"=4'

UNLESS OTHERWISE NOTED OR CHANGED BY REPRODUCTION


For Review Only

MECHANICAL DEMOLITION NOTES:

- ALL DEMOLITION AND REMOVAL OF EXISTING CONSTRUCTION, UTILITIES EQUIPMENT, AND APPURTENANCES SHALL BE ACCOMPLISHED WITHOUT DAMAGING THE INTEGRITY OF EXISTING STRUCTURES, EQUIPMENT, AND APPURTENANCES THAT ARE TO REMAIN. EQUIPMENT DESIGNATED BY THE OWNER TO BE SALVAGED SHALL BE REMOVED AND DELIVERED BY THE CONTRACTOR TO AN AREA AT THE TREATMENT FACILITY, INDICATED BY THE ENGINEER. REFER TO SPECIFICATION SECTION 02050-DEMOLITION.
- ALL DEMOLITION MATERIAL INCLUDING CONCRETE, PIPE, AND BRICK THAT WAS IN CONTACT WITH SEWAGE SHALL BE CLEANED IN ACCORDANCE WITH RIDEM REQUIREMENTS AND DISPOSED OF ACCORDINGLY. ONCE CLEANED, DEMOLITION MATERIALS SHALL NOT BE CONSIDERED SPECIAL WASTE.
- MATERIALS TO BE REMOVED THAT ARE NOT DESIGNATED TO BE SALVAGED SHALL BECOME THE PROPERTY OF THE CONTRACTOR AND SHALL BE REMOVED OFF-SITE AND DISPOSED OF AT THE CONTRACTORS' EXPENSE.
- THE CONTRACTOR IS RESPONSIBLE FOR THE LEGAL AND PROPER DISPOSAL OF ALL DEMOLITION MATERIAL ACCORDING TO ANY RELEVANT LAWS OF THE STATE OF RHODE ISLAND.
- ADDITIONAL DEMOLITION WORK IS SHOWN ON THE STRUCTURAL, PLUMBING, H&V, I&C, AND ELECTRICAL DRAWINGS.
- ALL REQUIRED DEMOLITION WORK SHALL BE DONE ACCORDING TO THE SEQUENCE OF OPERATIONS PLAN SUBMITTED BY THE CONTRACTOR AND APPROVED BY THE ENGINEER.
- PLANS OF THE EXISTING HEADWORKS FACILITY WERE BASED ON THE EXISTING DRAWINGS. THE DRAWINGS SHOW OVERALL DIMENSIONS OF THE STRUCTURE, AND THE LOCATION OF MAJOR EQUIPMENT AND PIPING. MISCELLANEOUS EQUIPMENT, PIPING, CONCRETE EQUIPMENT PADS, PIPE SUPPORTS, AND MATERIALS ARE NOT NECESSARILY SHOWN BUT ARE INCLUDED IN THE DEMOLITION. THE CONTRACTOR SHALL INSPECT THE HEADWORKS FACILITY DURING THE BIDDING PHASE OF THE PROJECT TO FAMILIARIZE THEMSELVES WITH THE EXTENT OF THE DEMOLITION WORK REQUIRED.

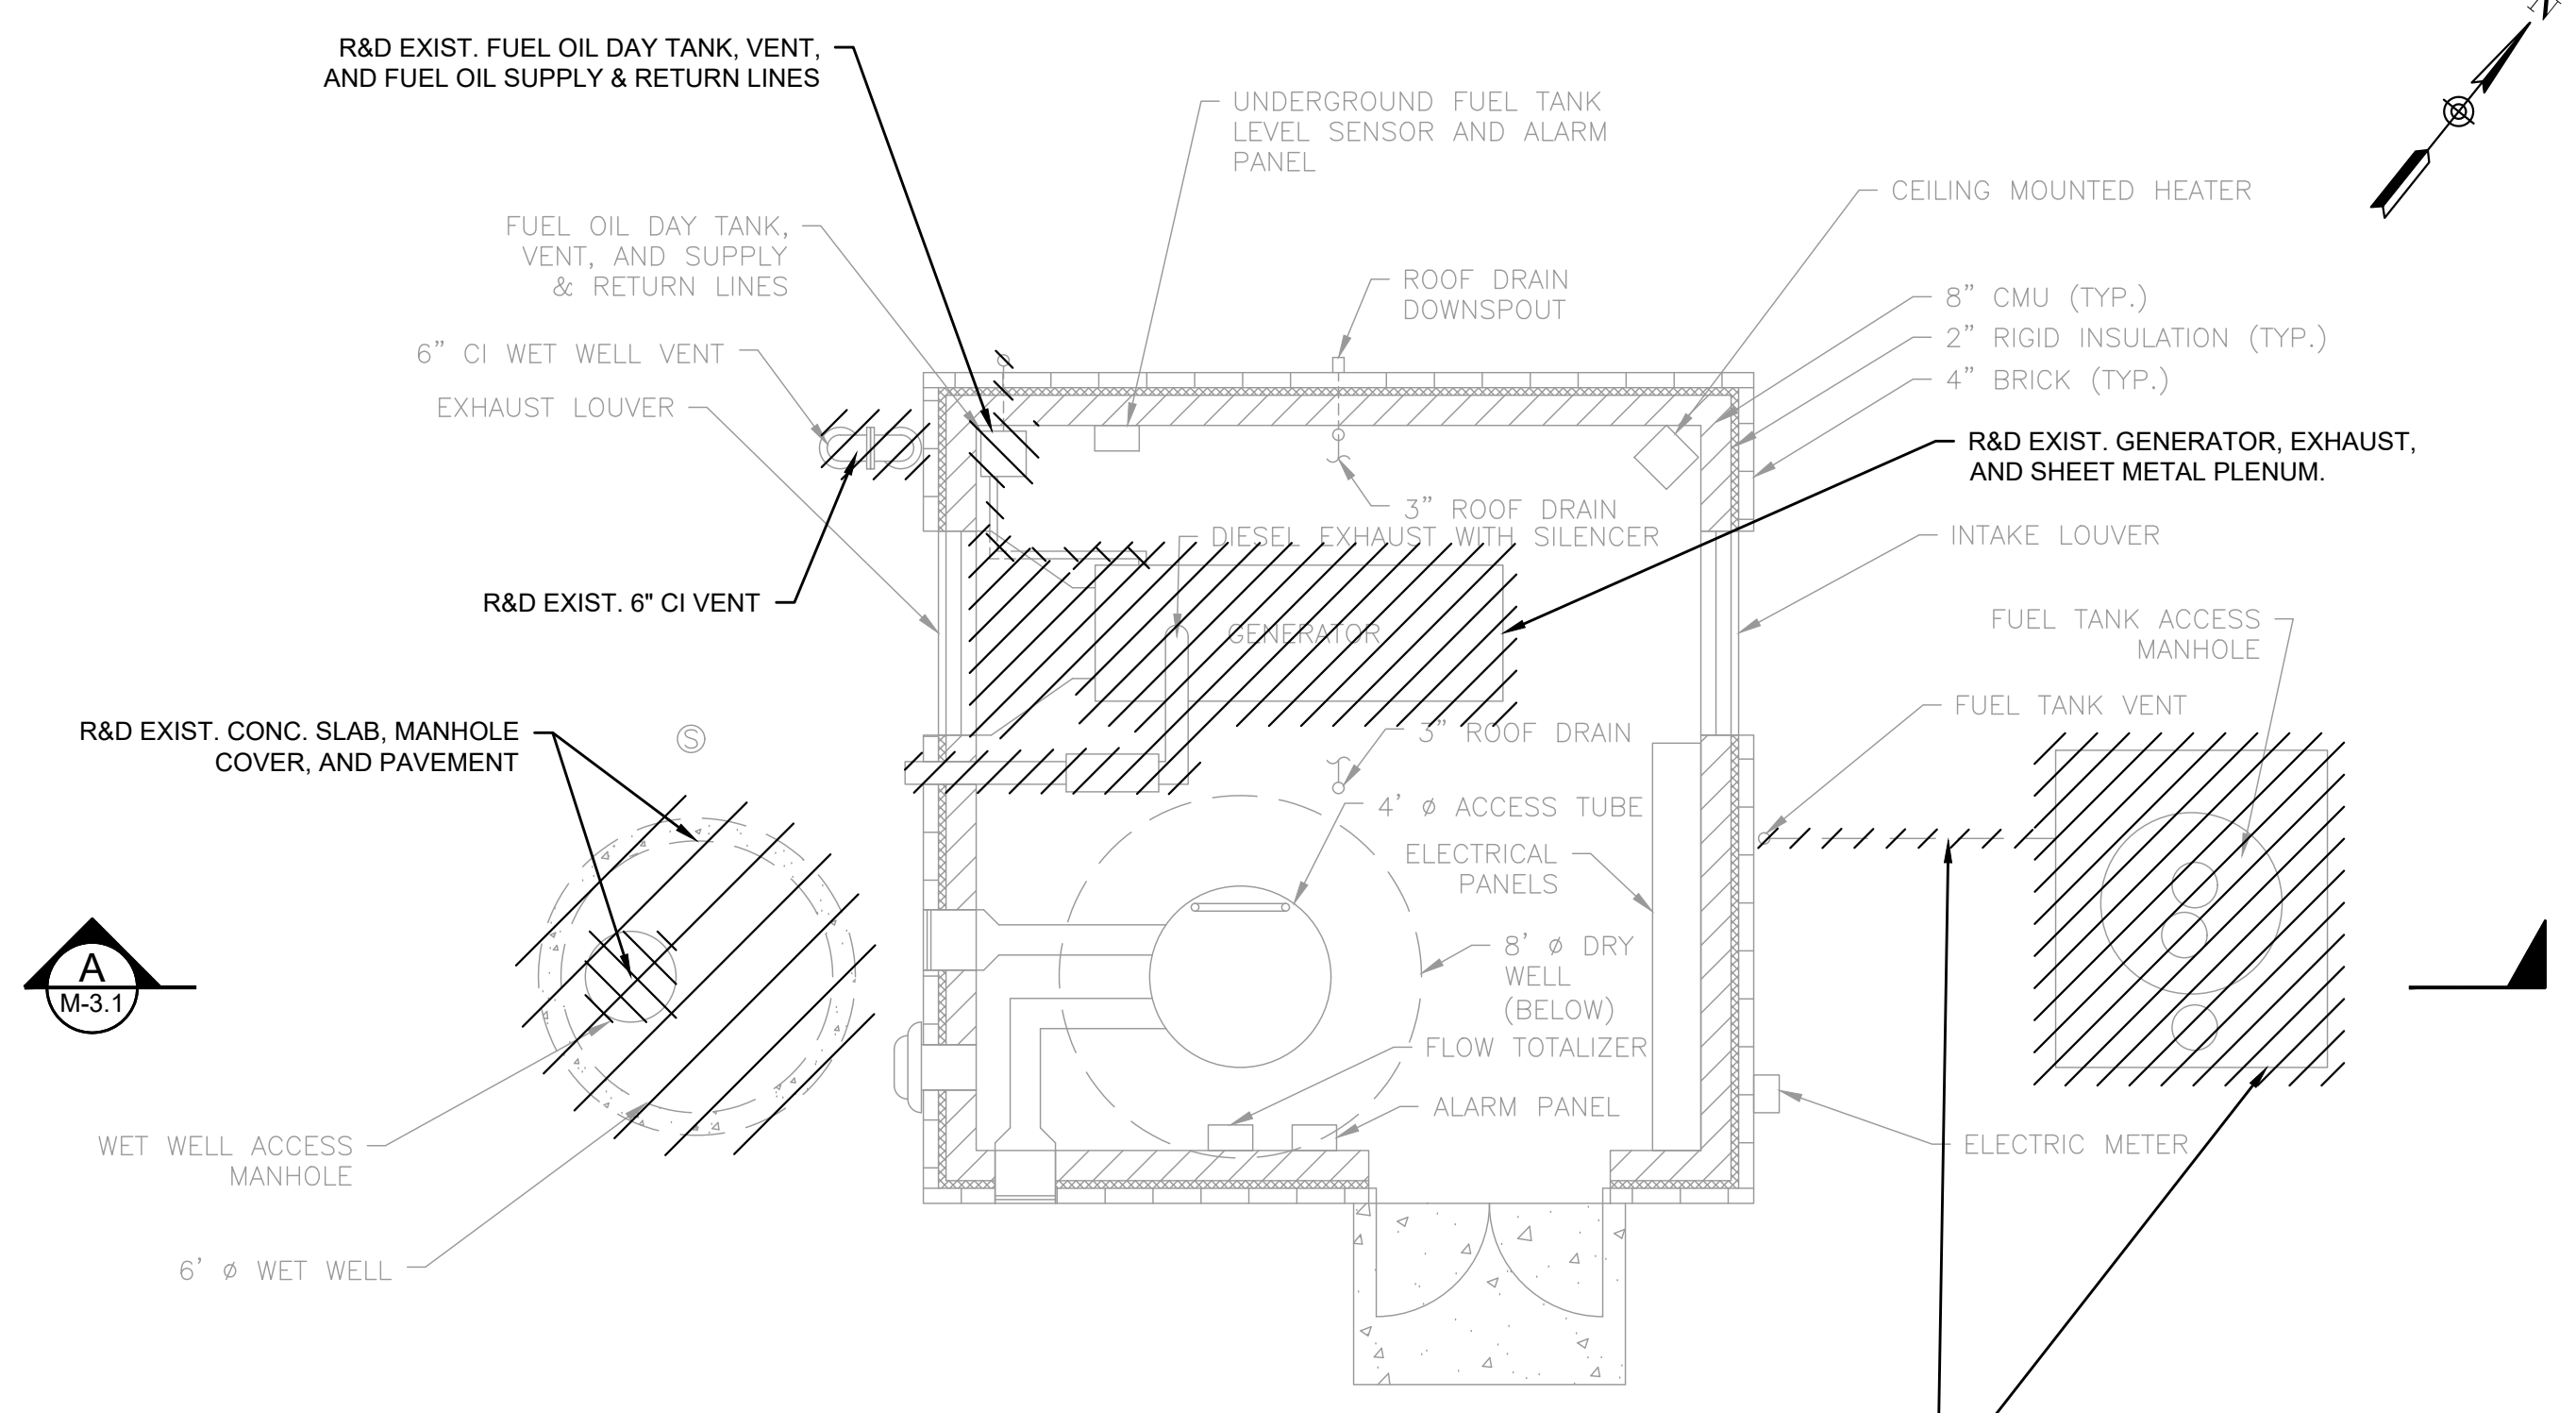


PUMP STATION PLAN (ABOVE GRADE) - DEMOLITION
SCALE: 1/4" = 1'-0"

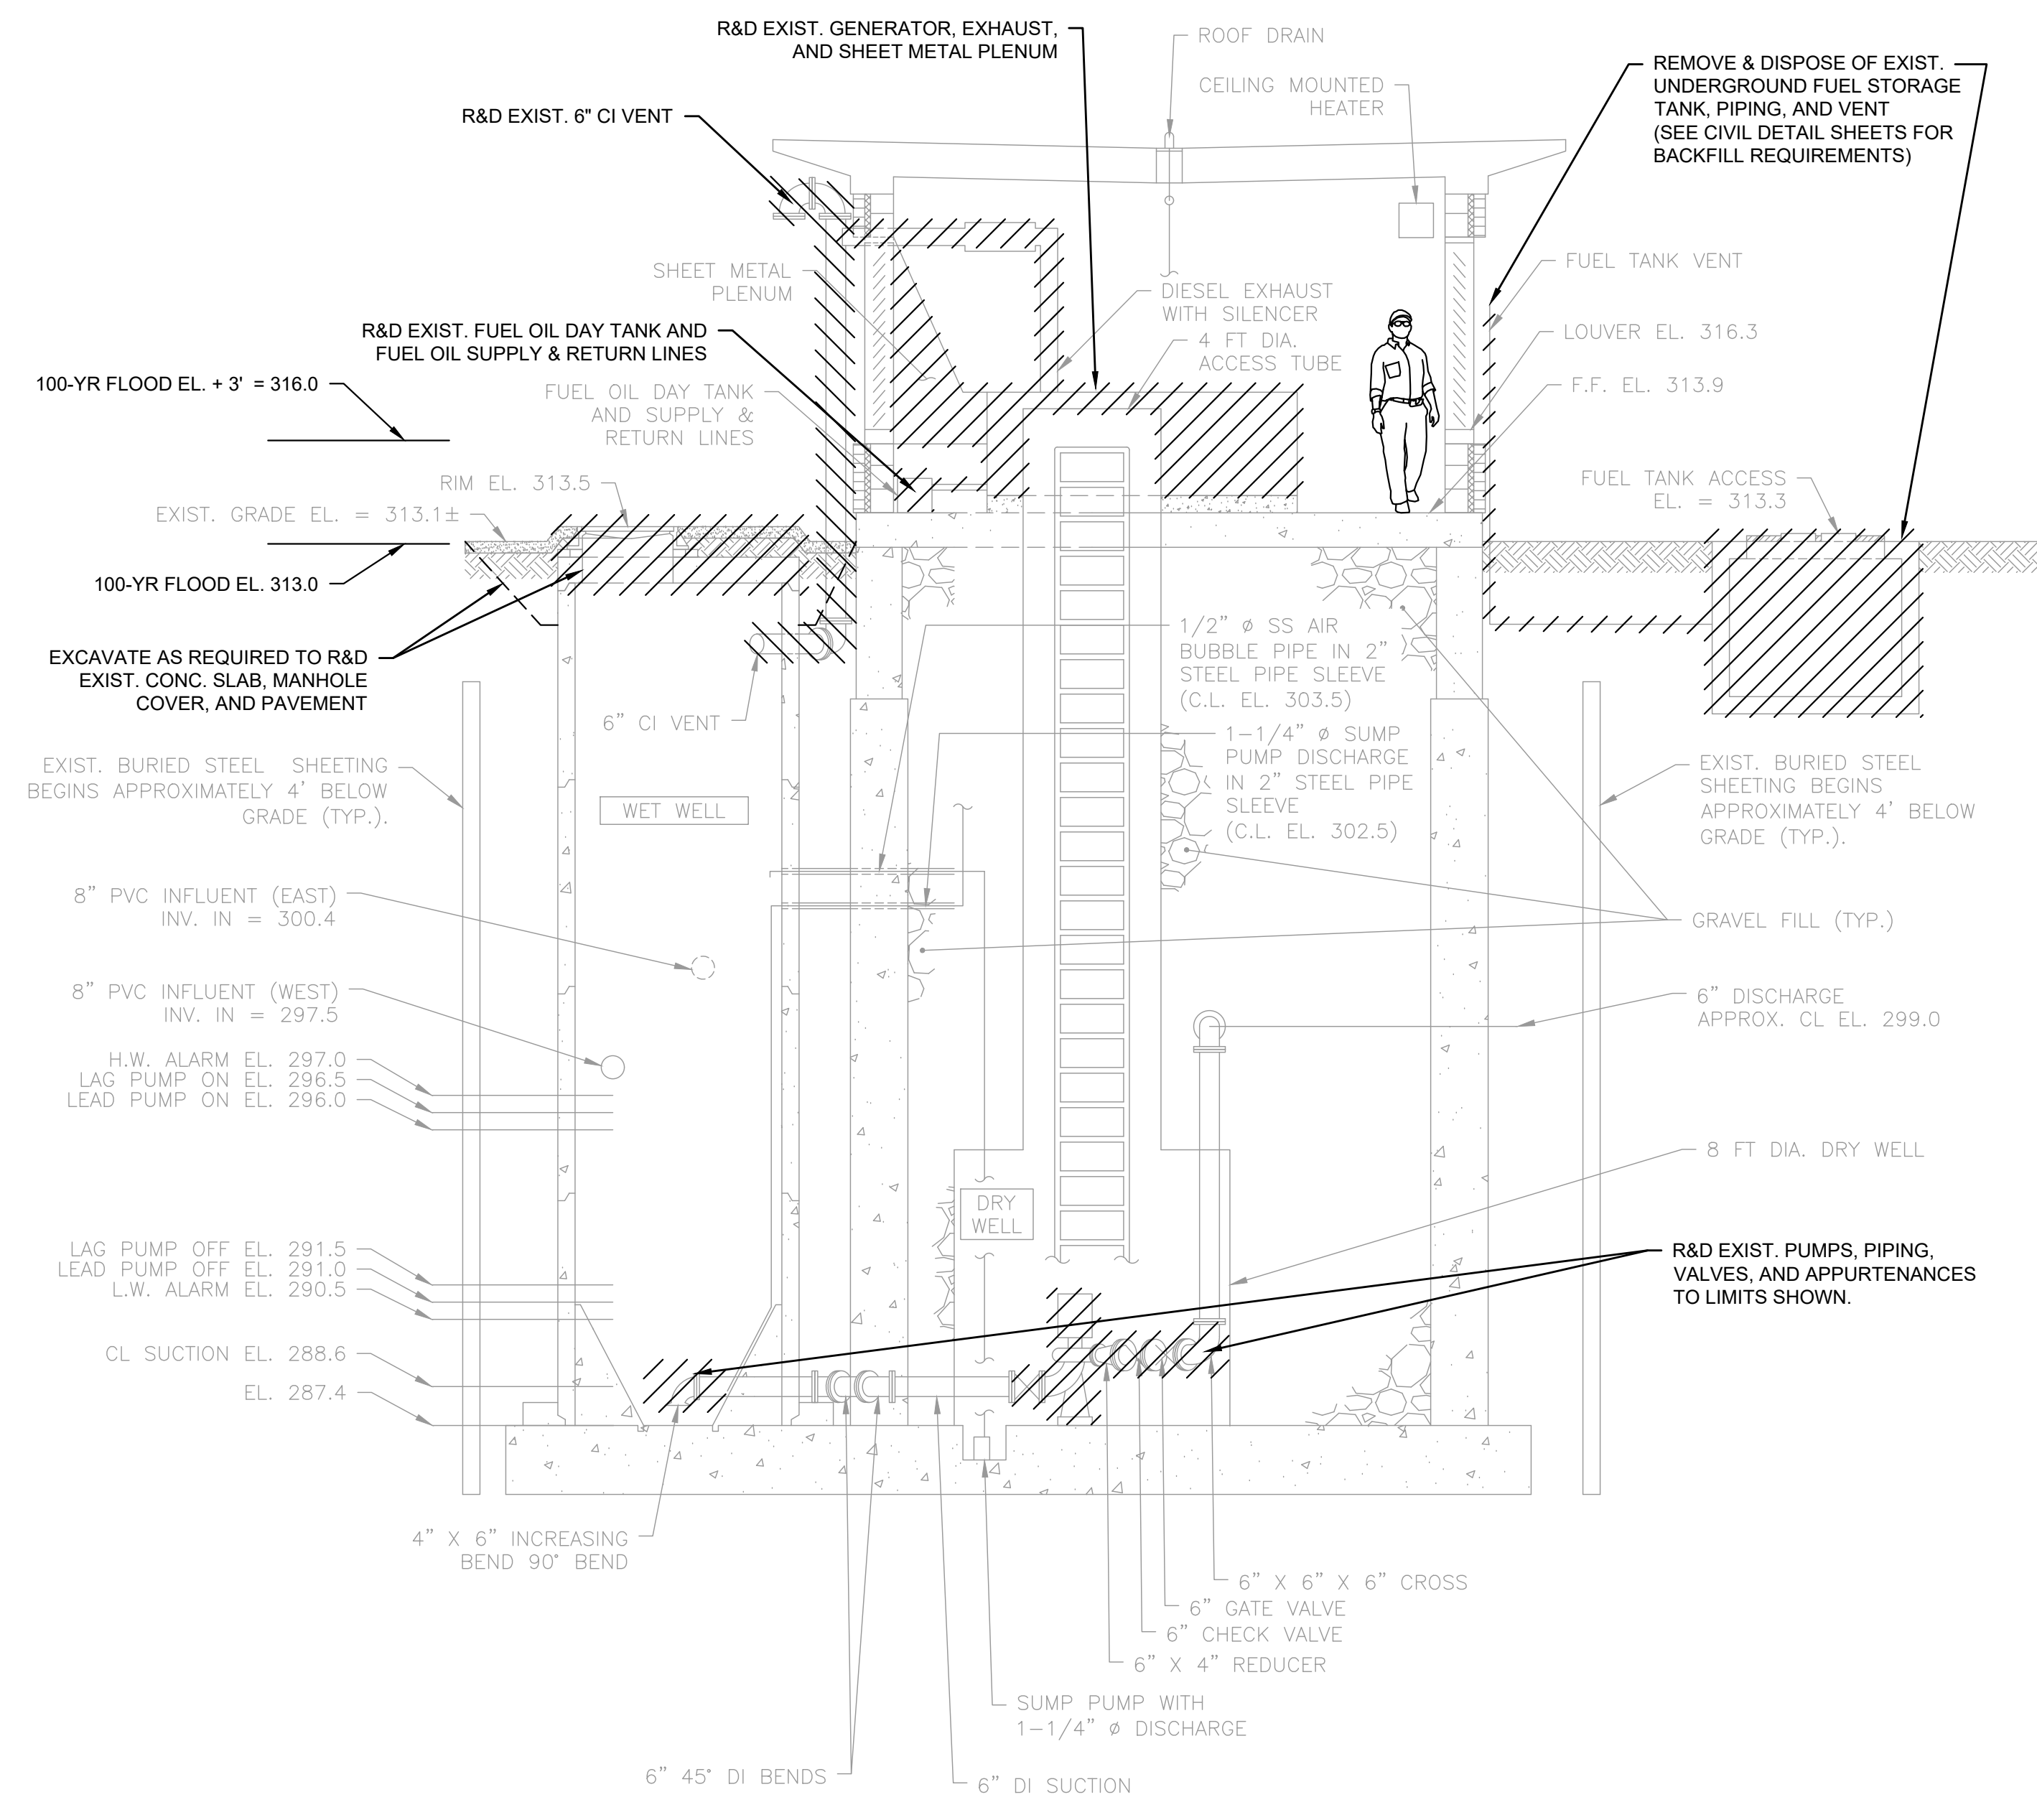


DEMOLITION SECTION A-M-3.1
SCALE: 1/4" = 1'-0"

- NOTES:**
- SEAL PENETRATIONS THROUGH EXTERIOR WALLS AFTER REMOVAL OF GENERATOR EXHAUST PIPE AND DAY TANK VENT.

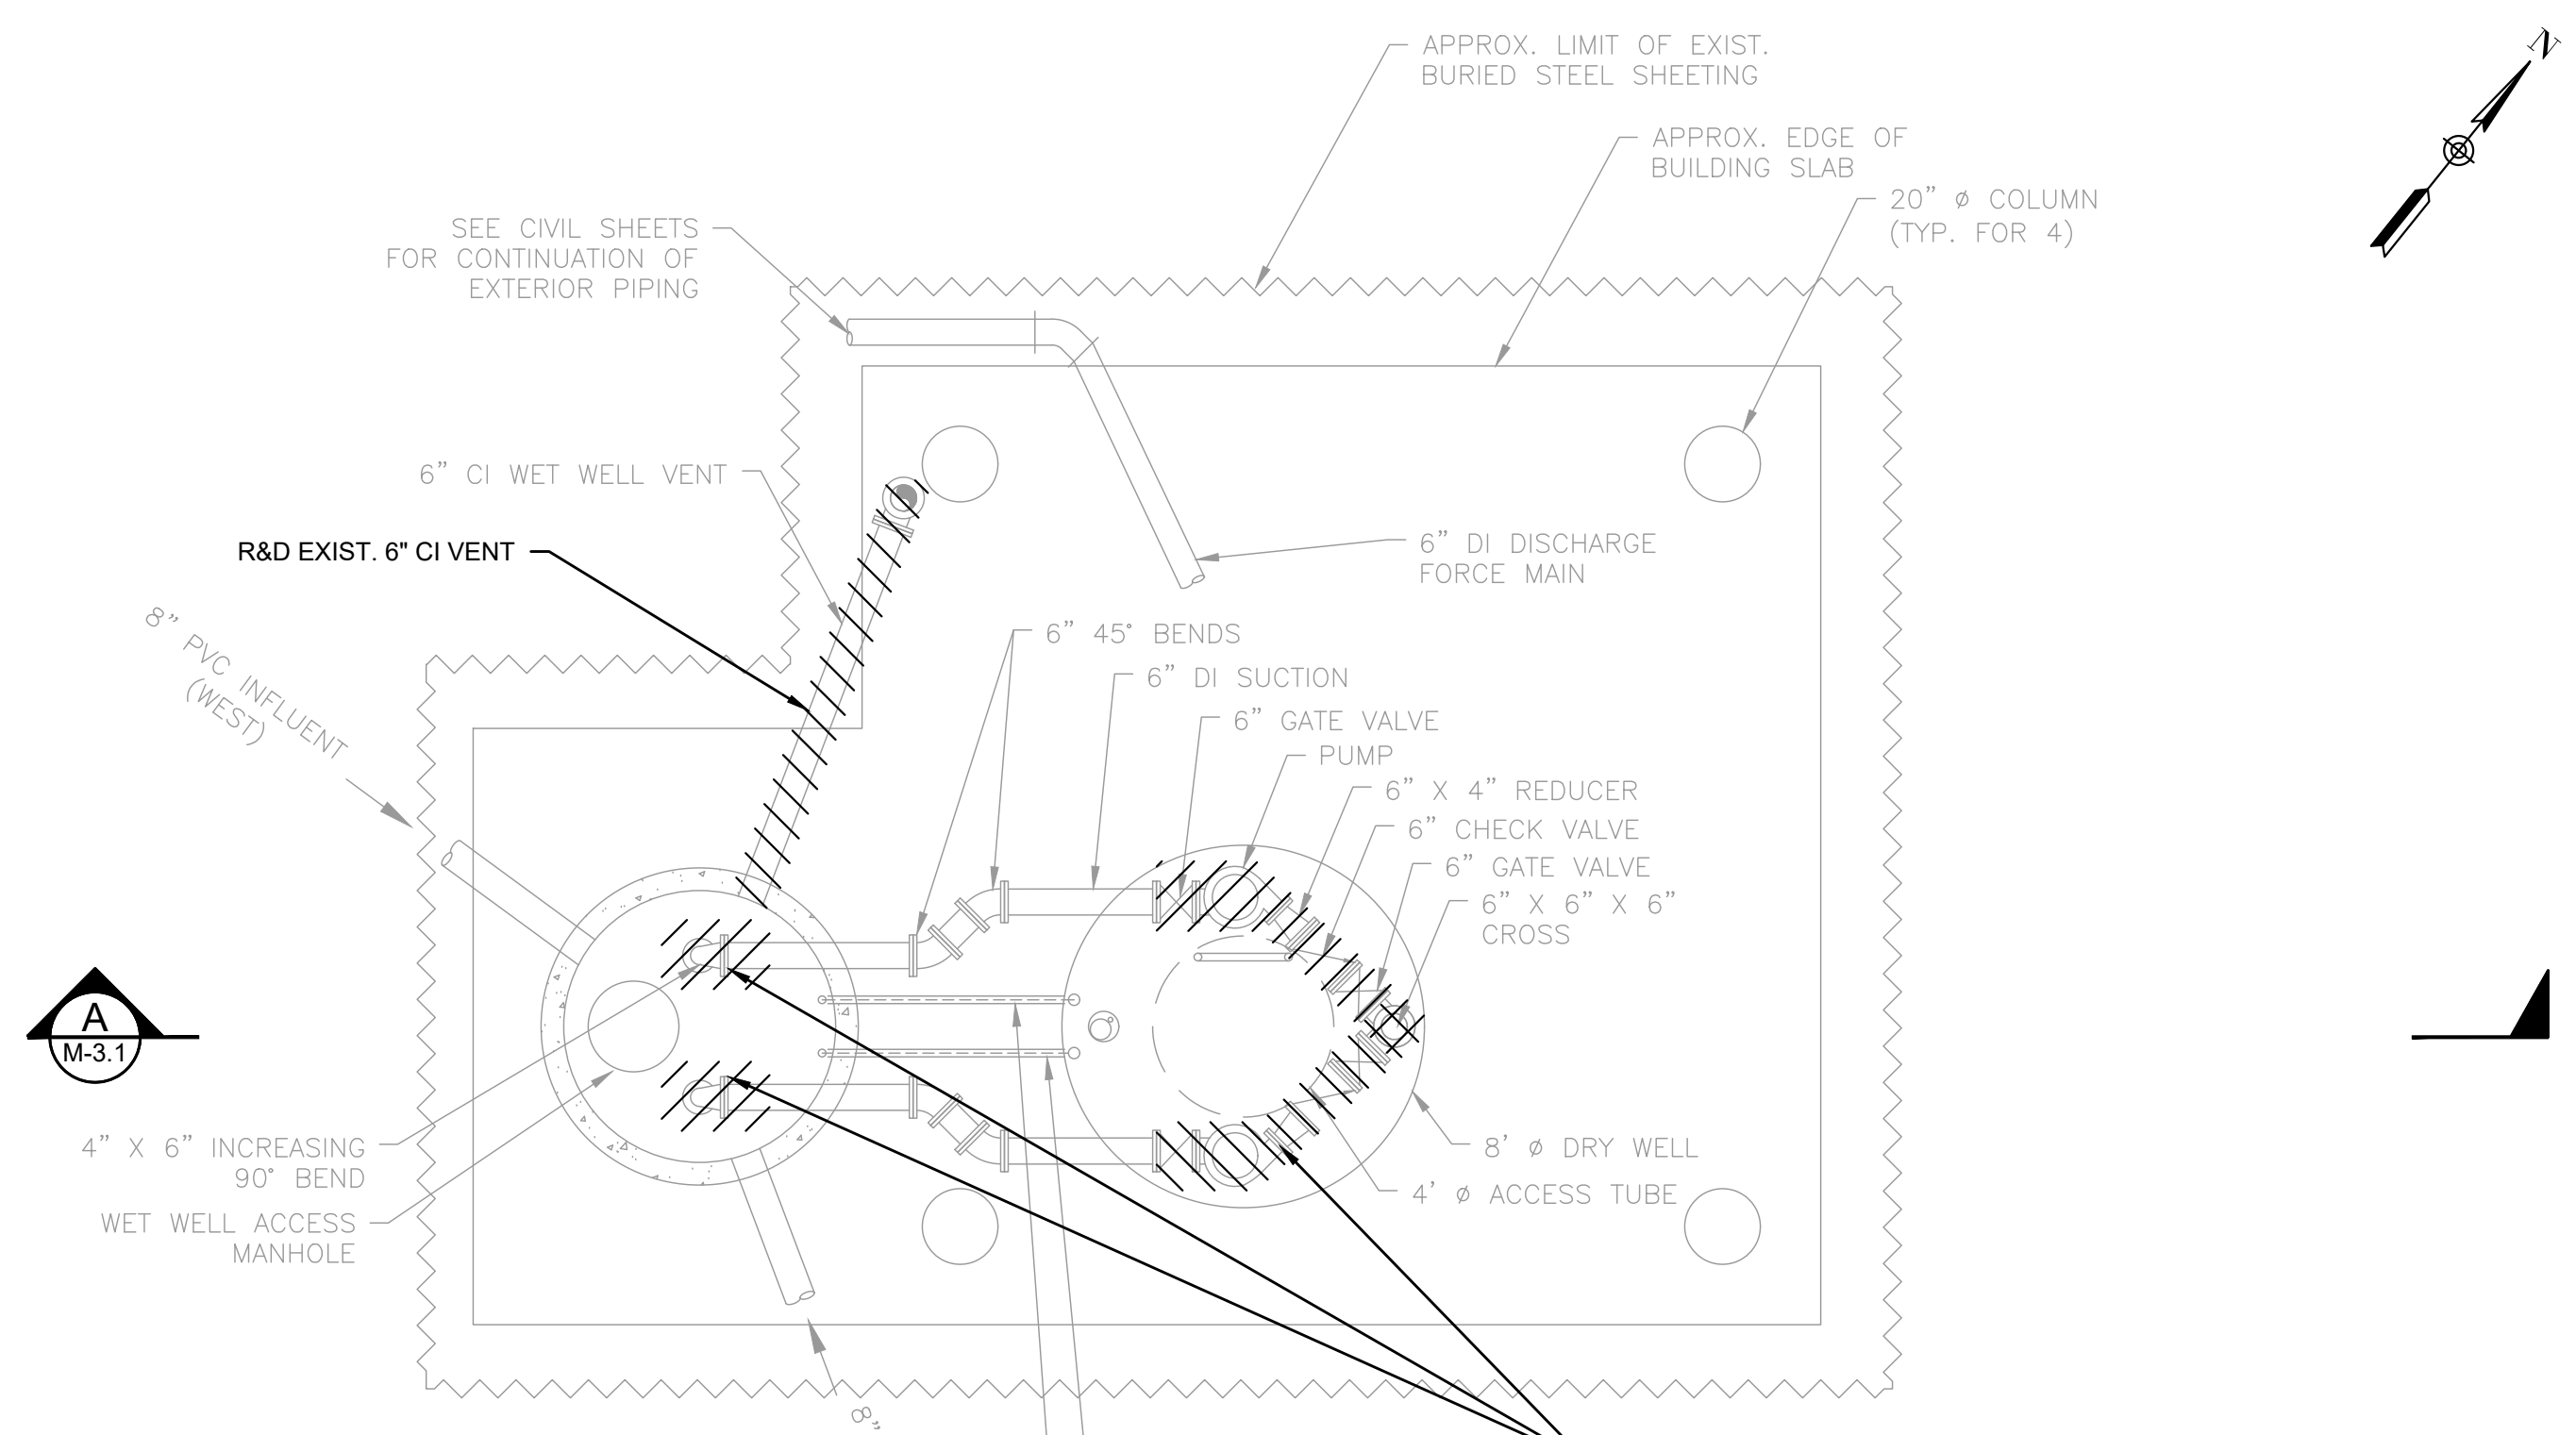

PUMP STATION PLAN (BELOW GRADE) - DEMOLITION
SCALE: 1/4" = 1'-0"

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**BURRILLVILLE WWTF
HEADWORKS &
OAKLAND PUMP
STATION
IMPROVEMENTS**

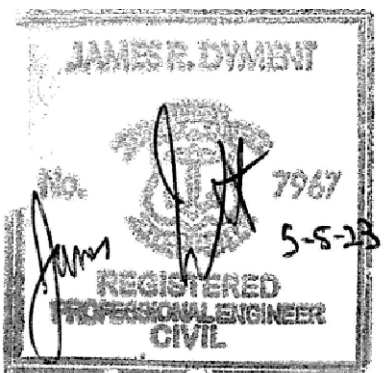**OAKLAND PS -
PROPOSED
PLAN & SECTION**

NO.	REVISIONS	DATE

DRAWN BY: CJM

DESIGNED BY: AJG

CHECKED BY: JRD

ISSUE DATE: MAY 2023

BETA JOB NO.: 6861-105

SCALE




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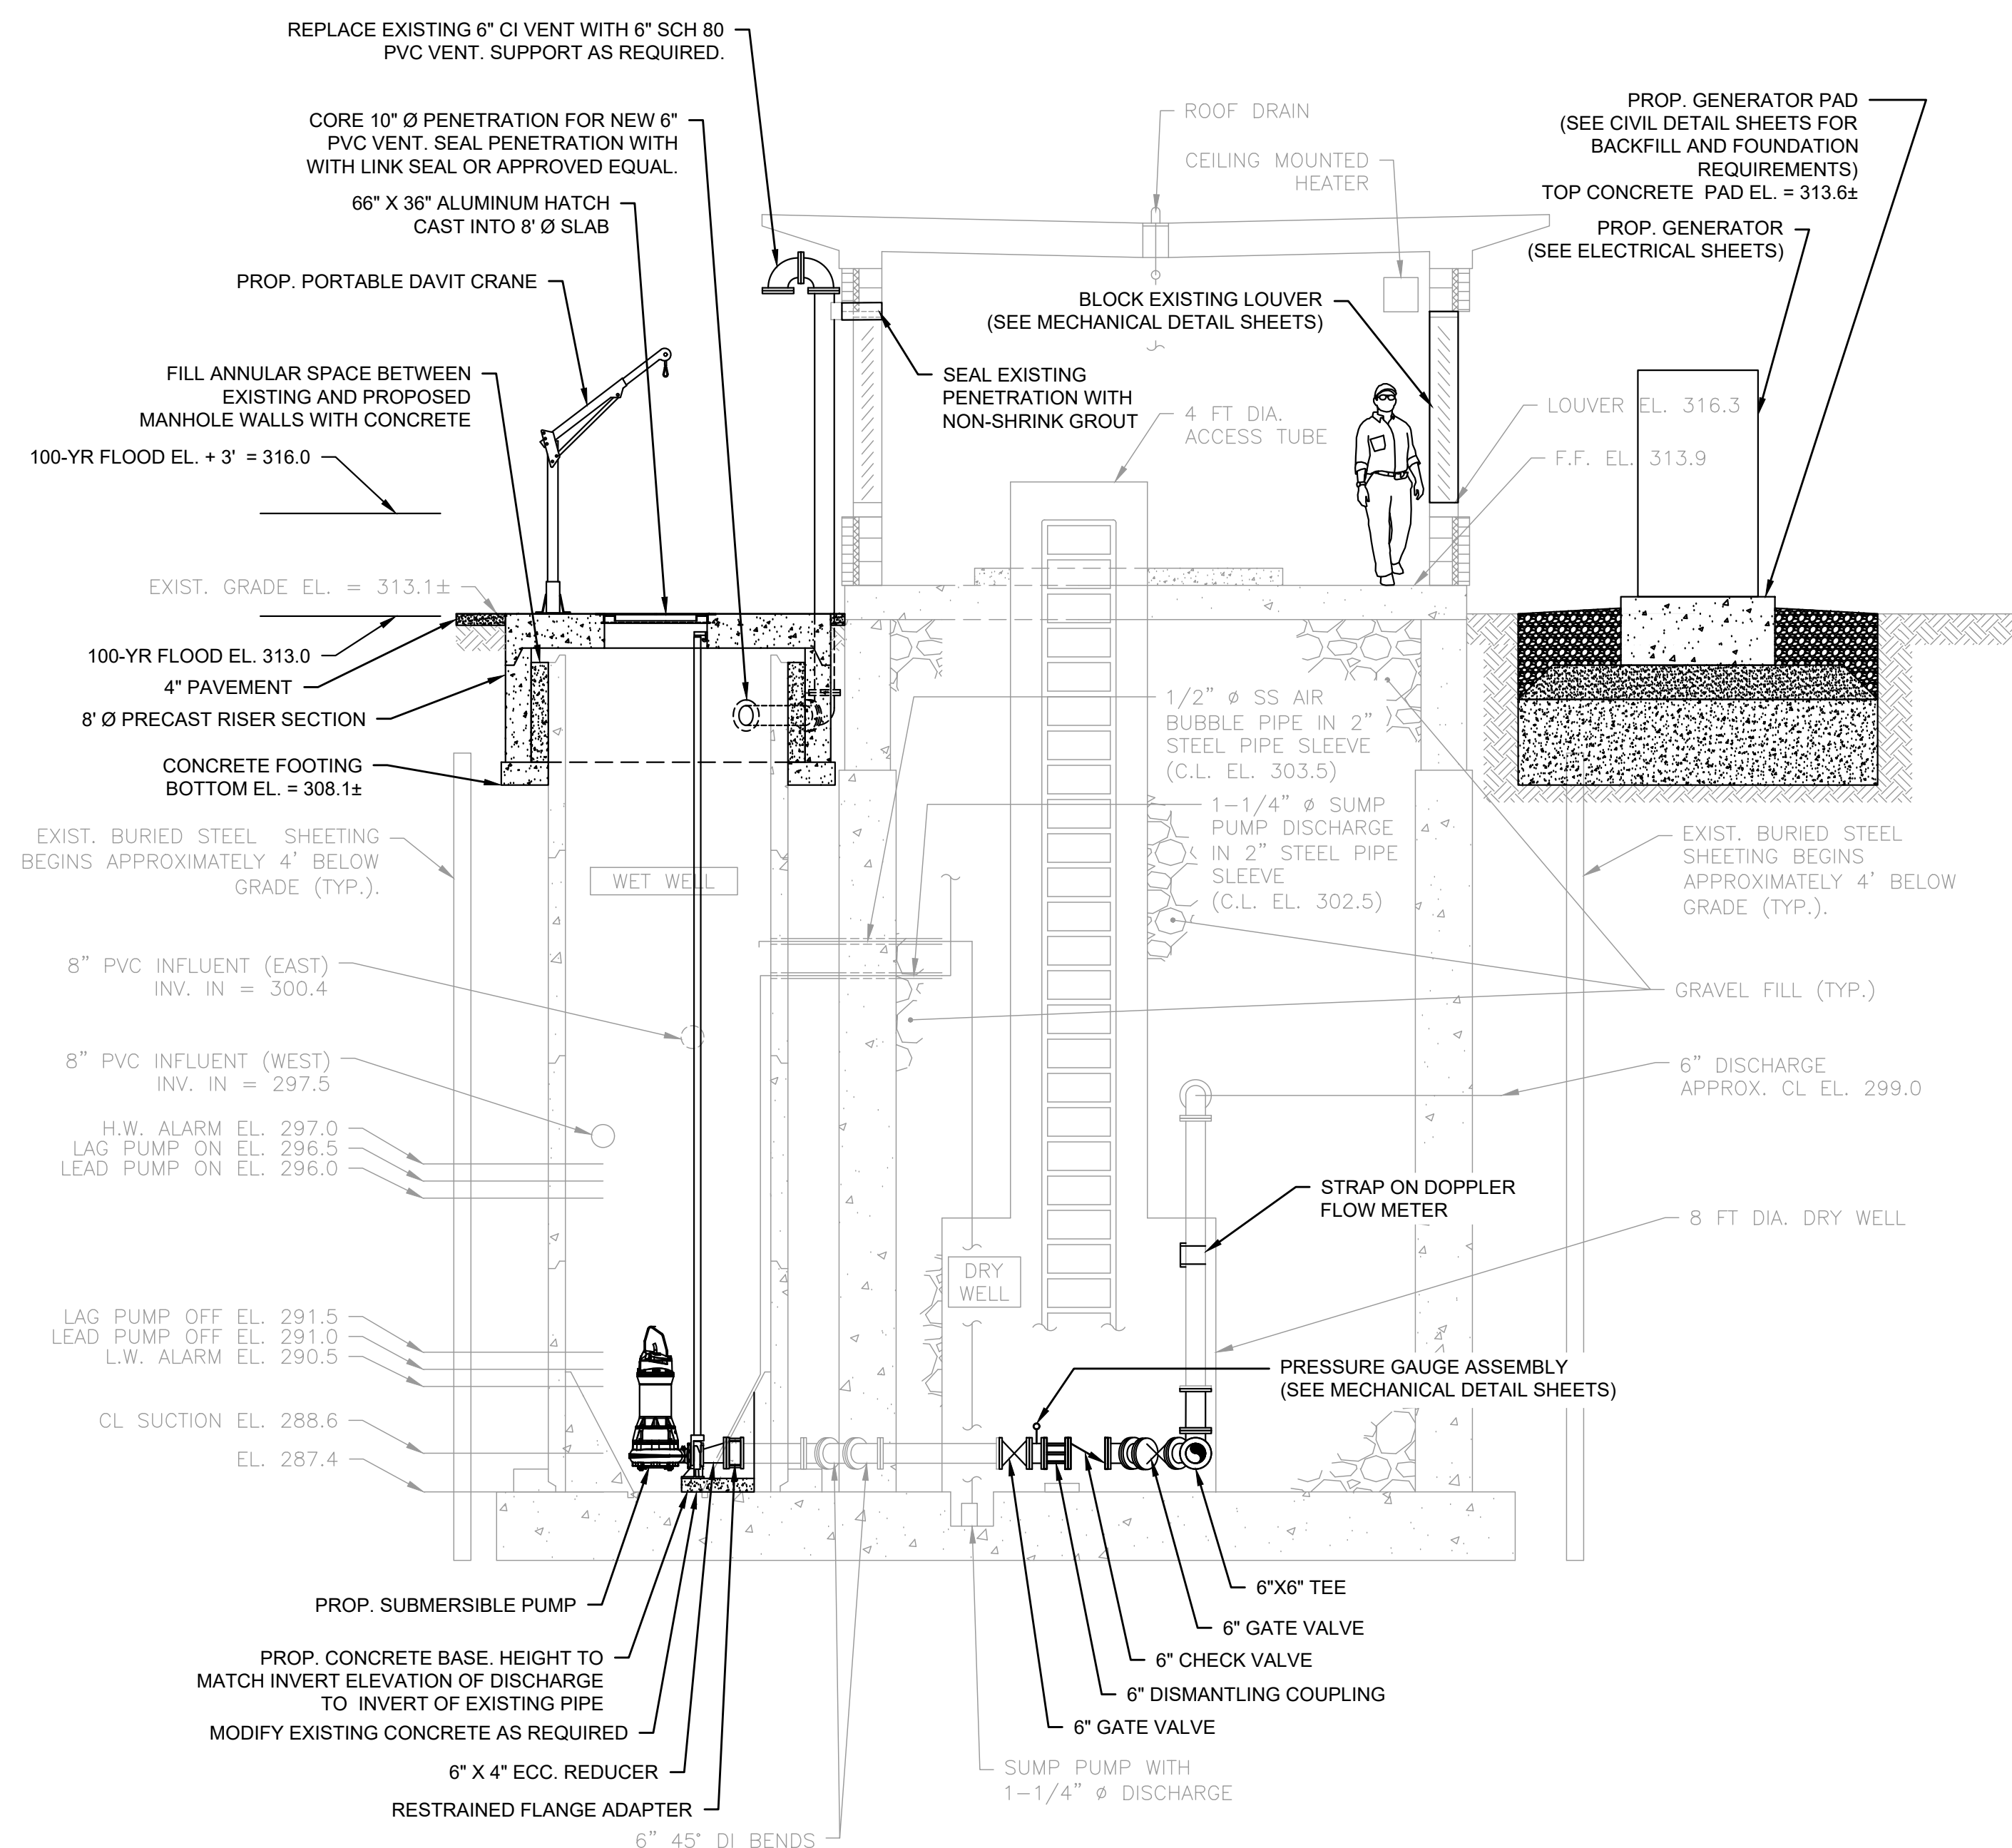
SHEET NO.

M-3.2





PUMP STATION PLAN (ABOVE GRADE) - PROPOSED

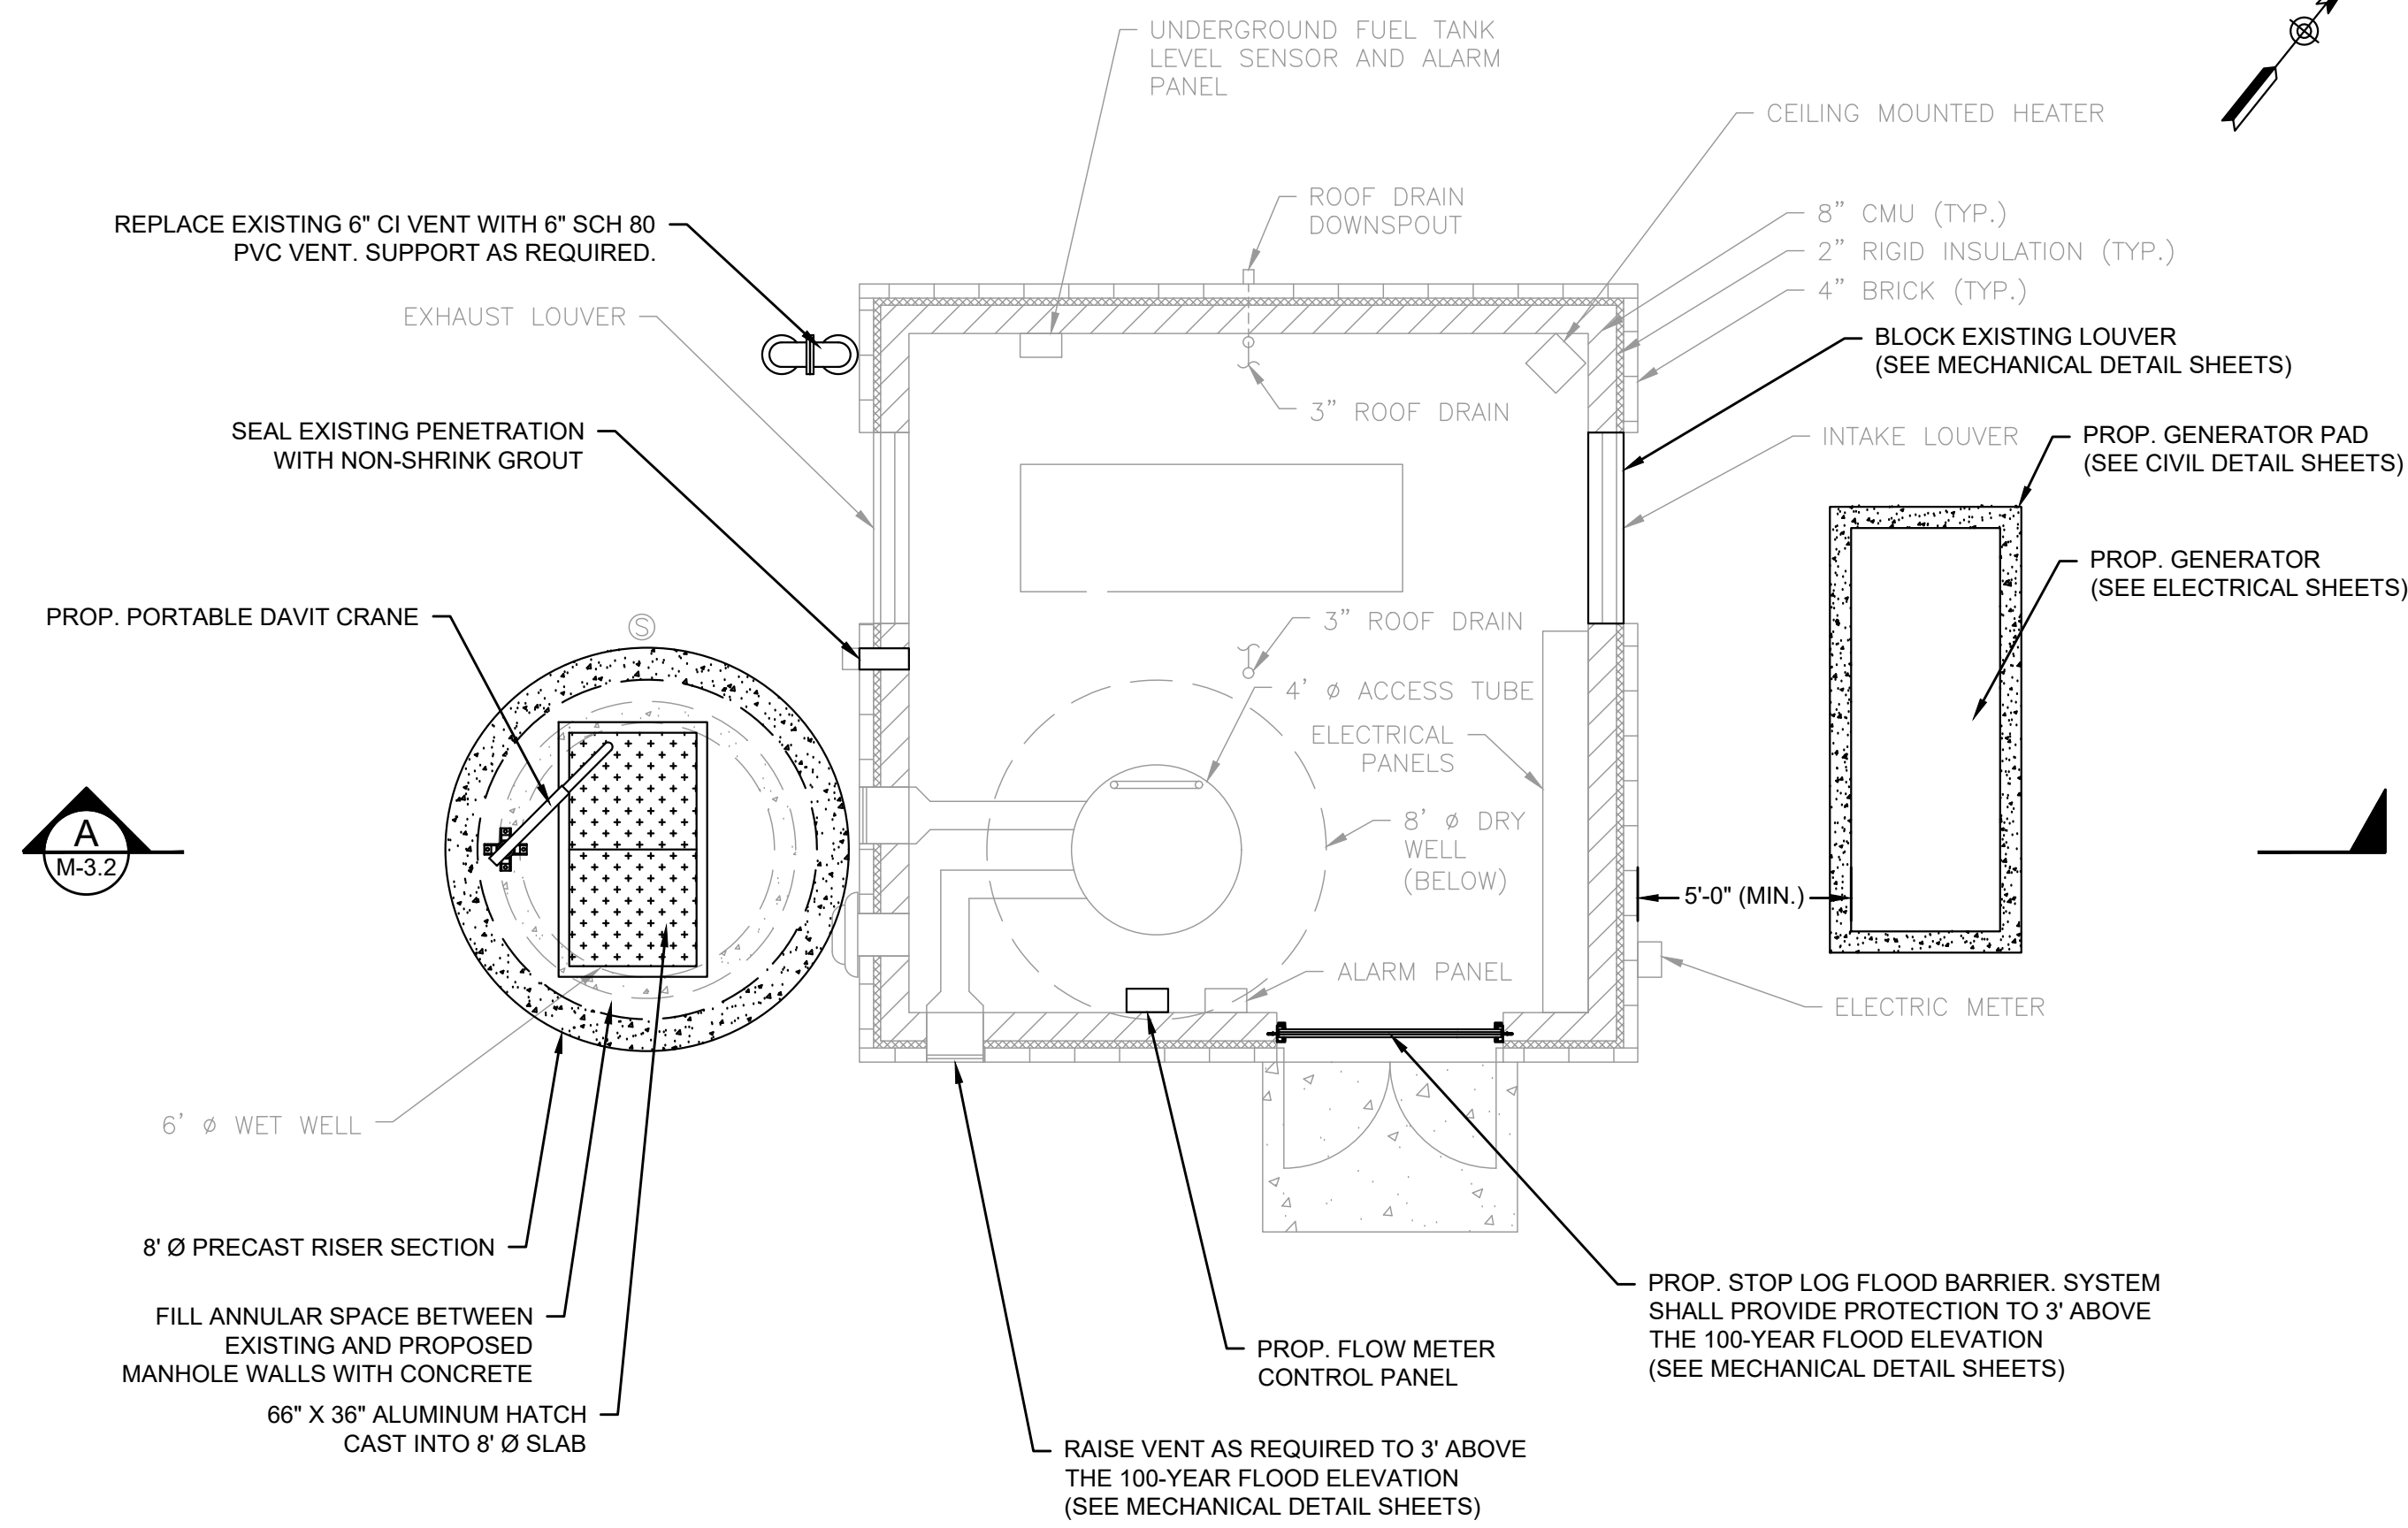SCALE: 1/4" = 1'-0"



PROPOSED SECTION A

SCALE: 1/4" = 1'-0"

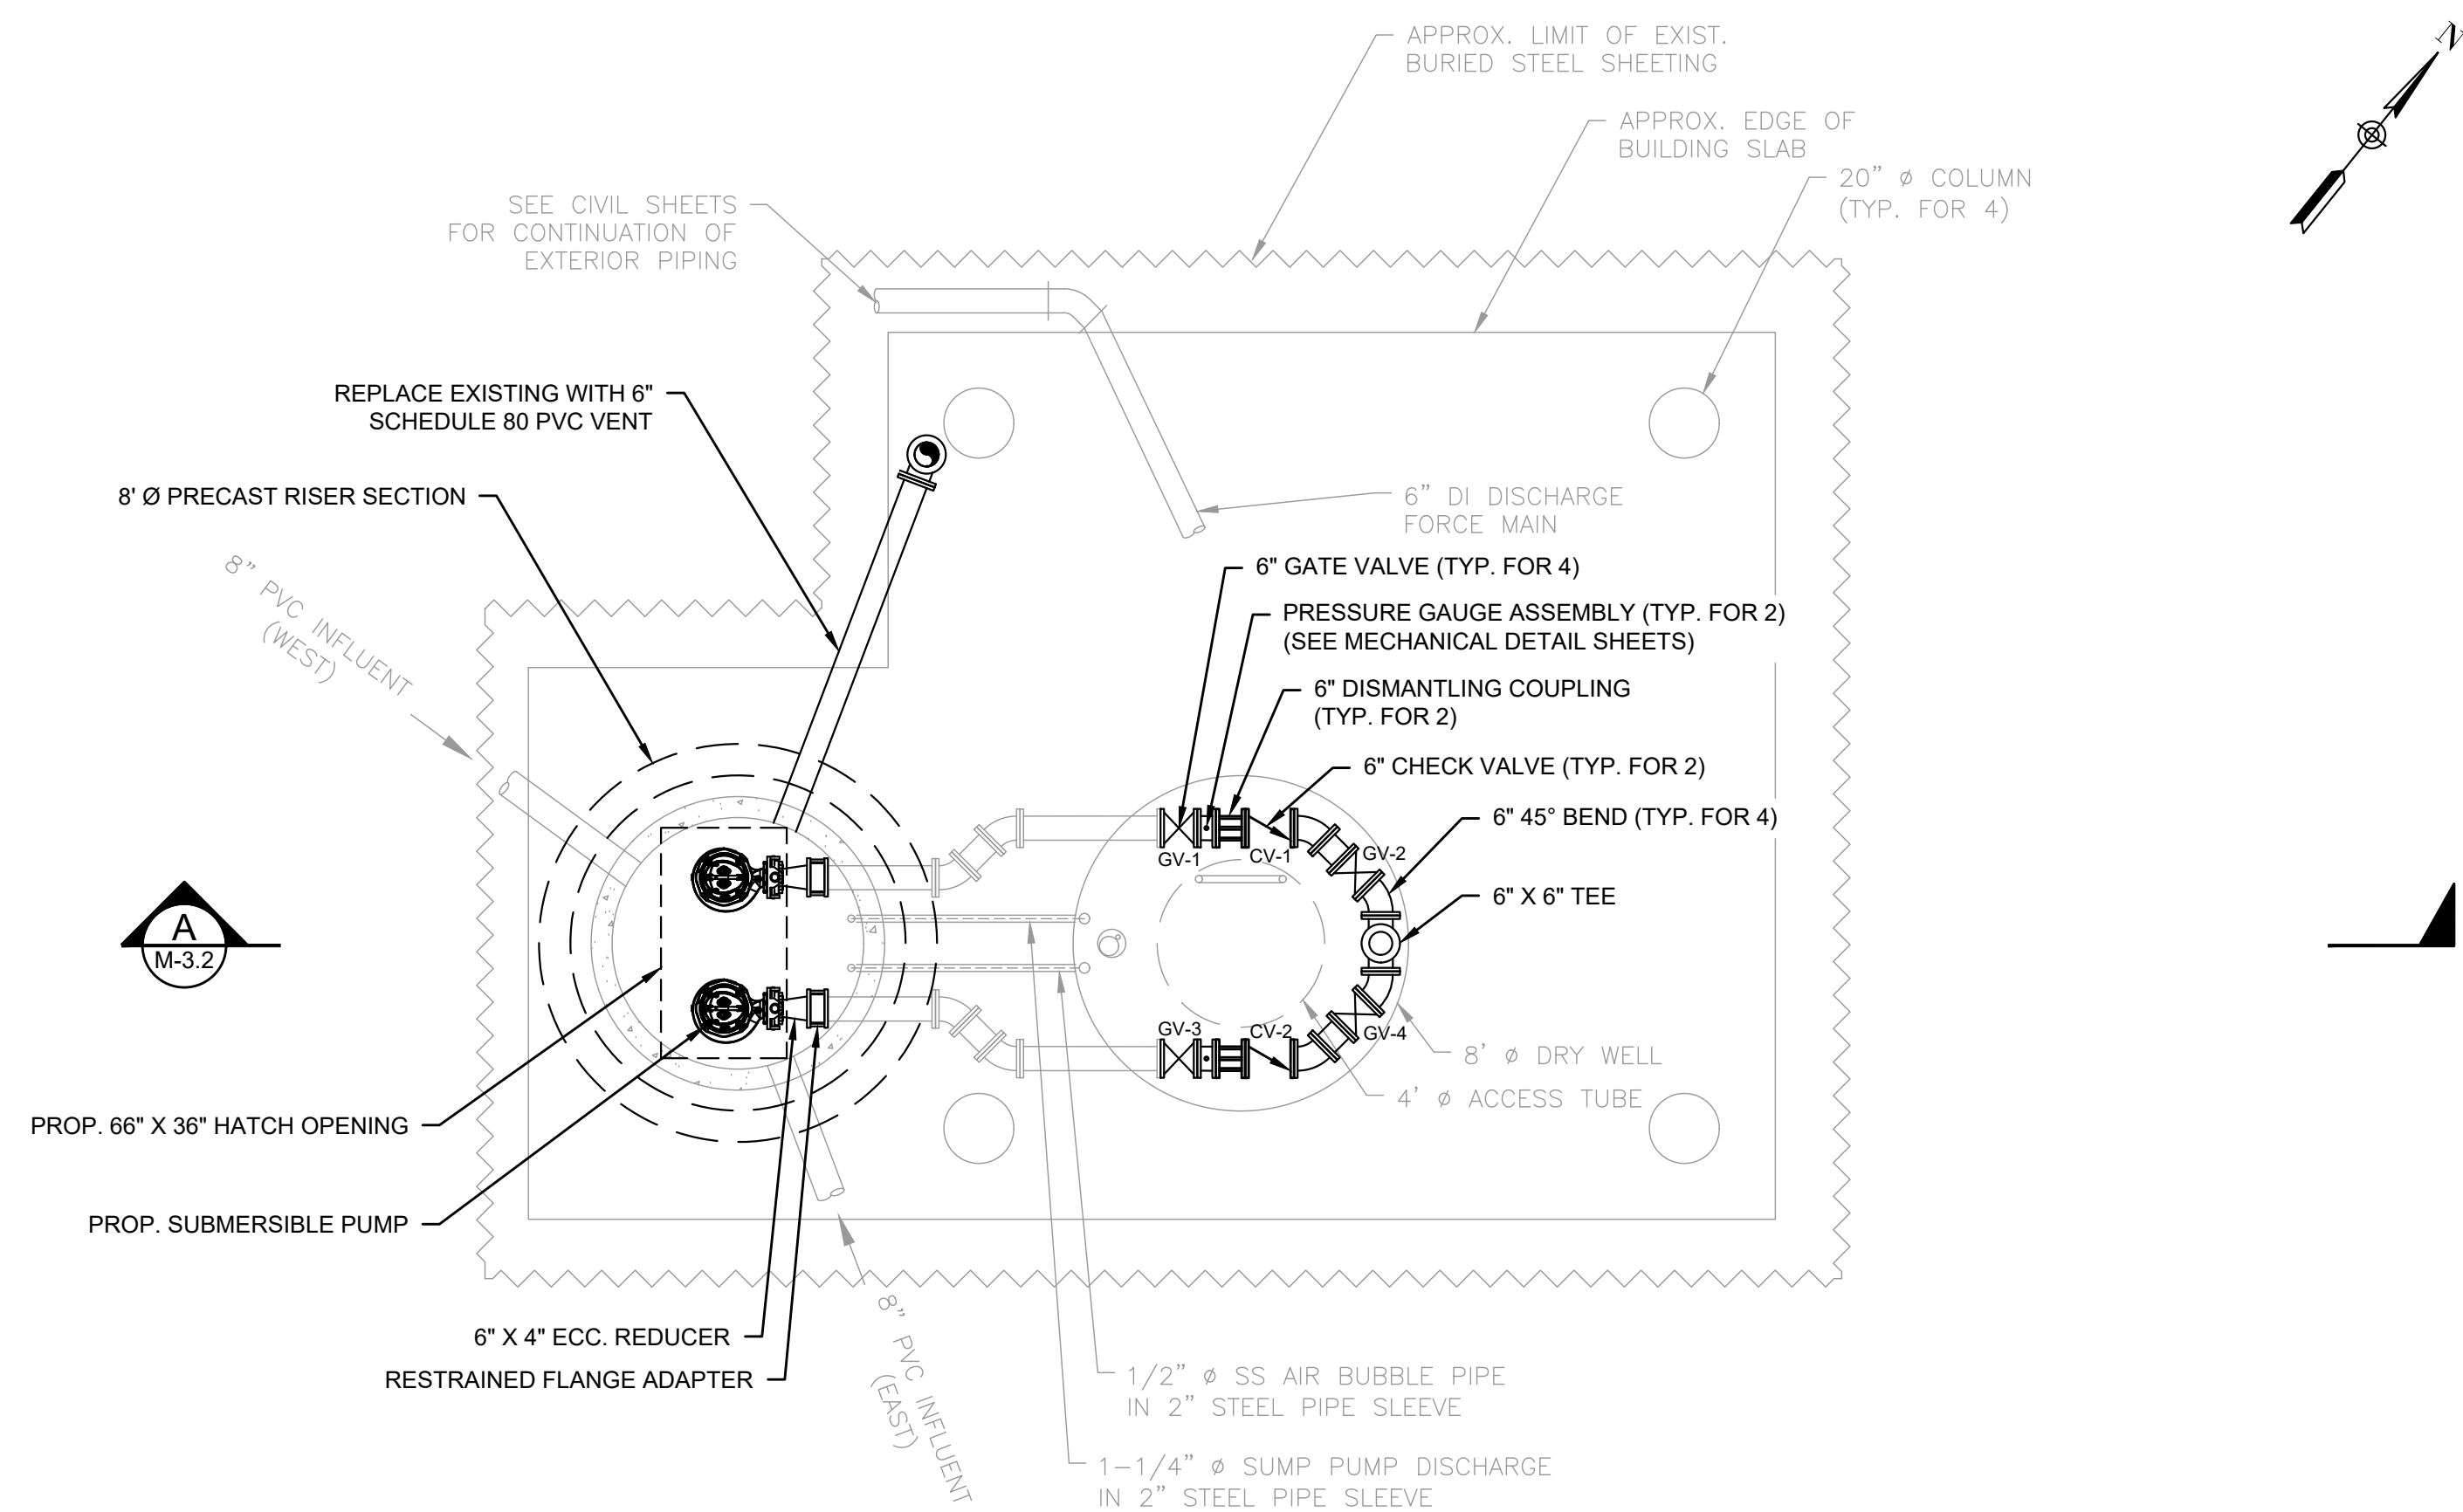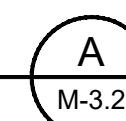

PUMP STATION PLAN (BELOW GRADE) - PROPOSED


SCALE: 1/4" = 1'-0"

5/16/2023 J:\BURRILLVILLE\WTF-HEADWORKS IMPROVEMENTS\CAD\DRAWINGFILES\PLANSET\MECHANICAL-DETAILS.DWG

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PROJECT

**BURRILLVILLE WWTF
HEADWORKS &
OAKLAND PUMP
STATION
IMPROVEMENTS**

BURRILLVILLE, RI

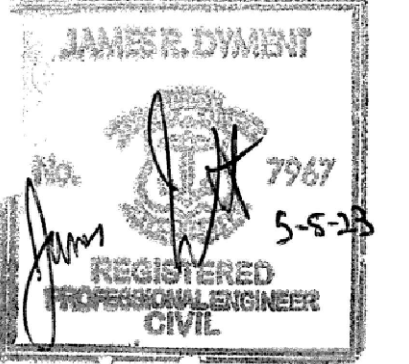TITLE

**MECHANICAL
DETAILS - I**

NO.	REVISIONS	DATE


DRAWN BY:	CJM
DESIGNED BY:	AJG
CHECKED BY:	JRD
ISSUE DATE:	MAY 2023
BETA JOB NO.:	6861-105

SCALE
AS SHOWN

UNLESS OTHERWISE NOTED OR CHANGED BY REPRODUCTION

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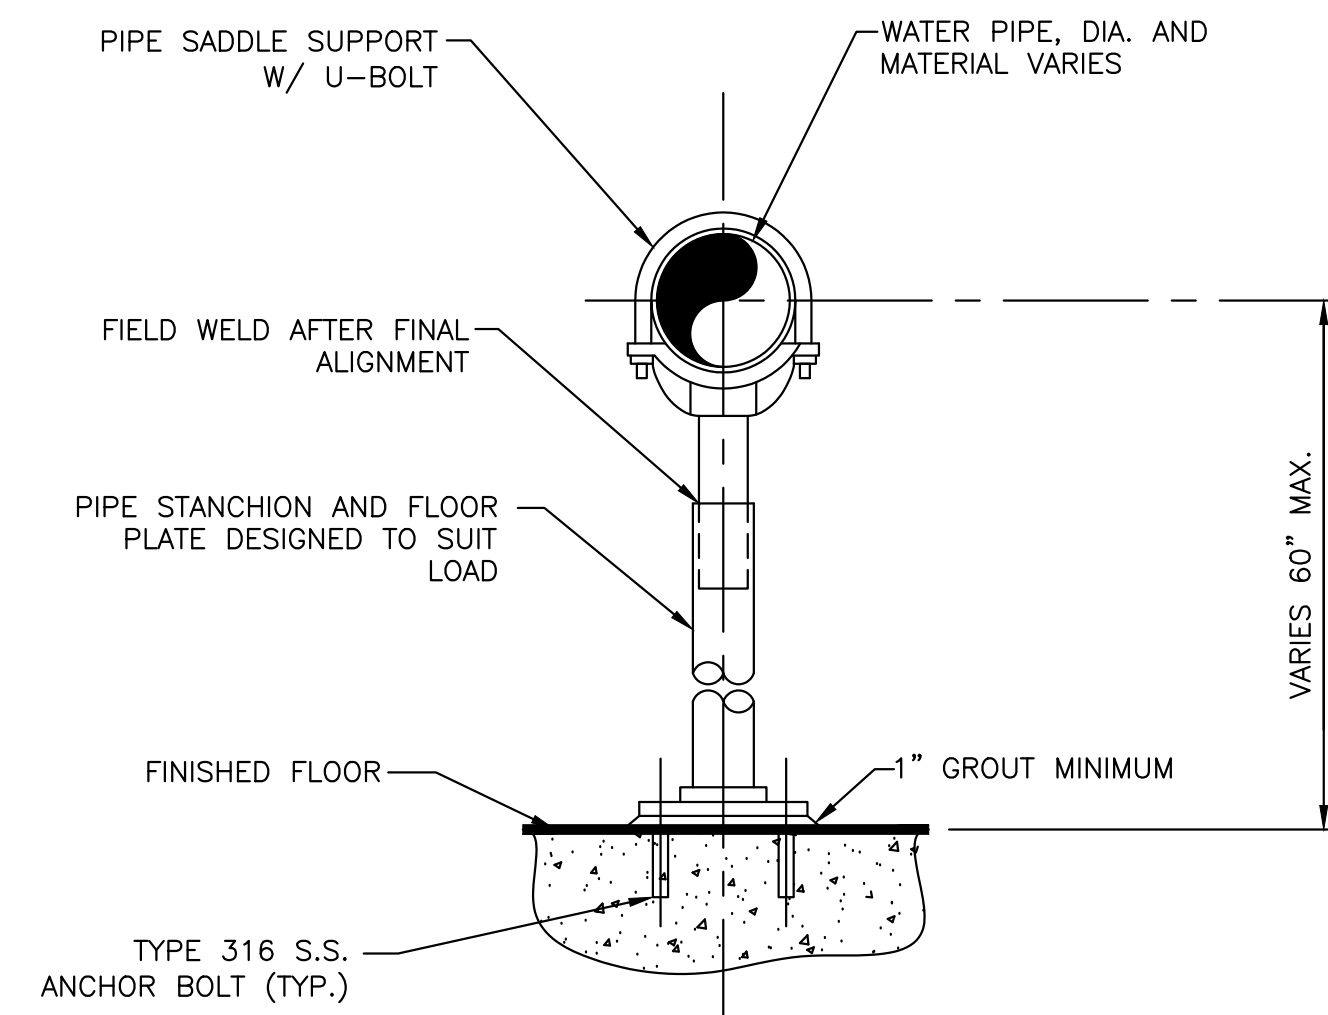
SHEET NO.
MD-1

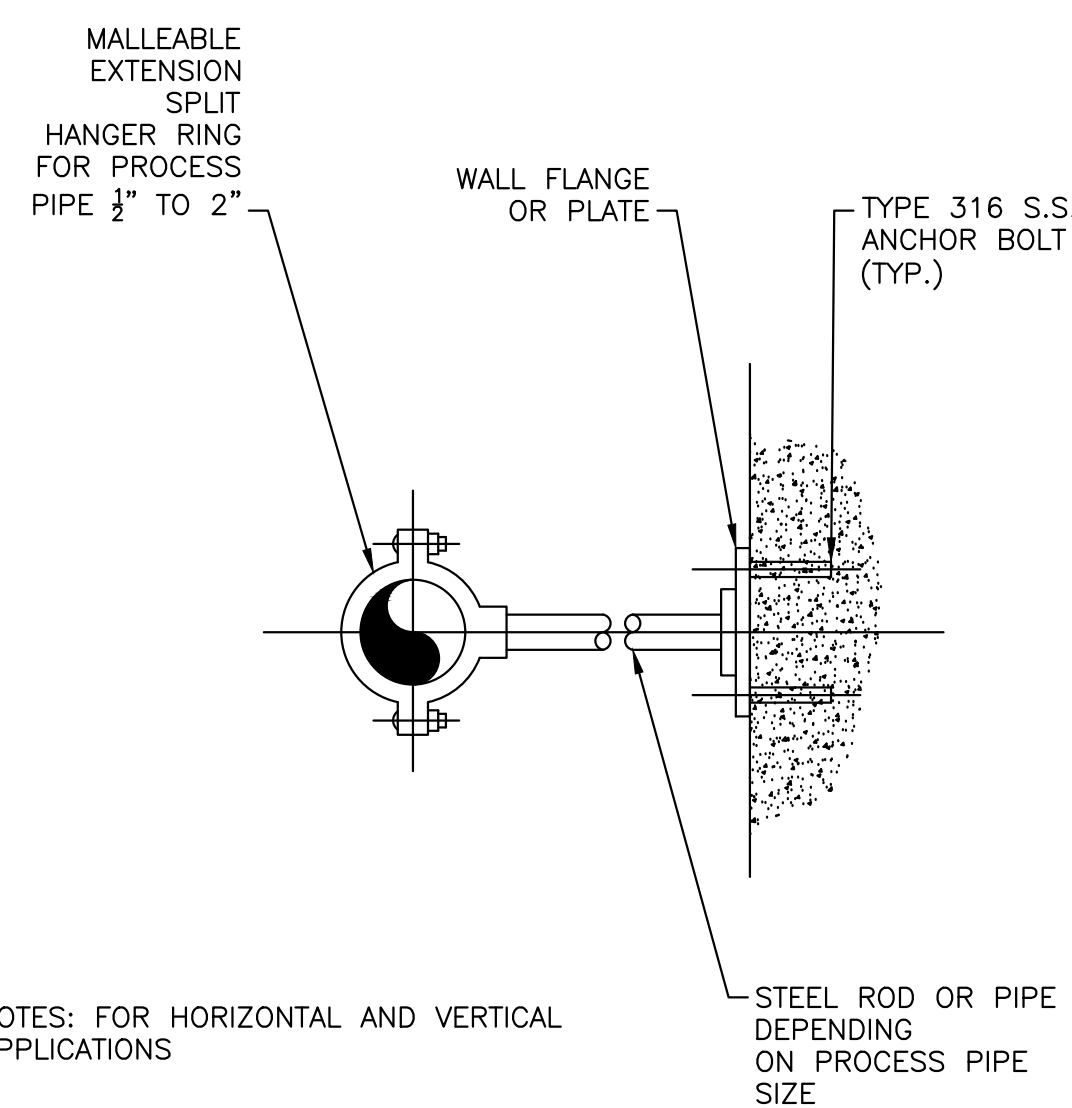

NOTES: FOR HORIZONTAL AND VERTICAL APPLICATIONS

GRINNELL FIGURE 138 OR EQUAL


WALL PIPE SUPPORT
NOT TO SCALE



NOTES:


1. PROVIDE HALF-ROUND RIGID INSULATION WAND INSULATION SHIELD FOR INSULATED PIPING.
2. PROVIDE NEOPRENE ISOLATION PAD UNDER SUPPORT FOOT FOR ISOLATED PIPING OR WHEN SUPPORT IS ADJACENT TO MECHANICAL EQUIPMENT.

FLOOR PIPE SUPPORT
NOT TO SCALE

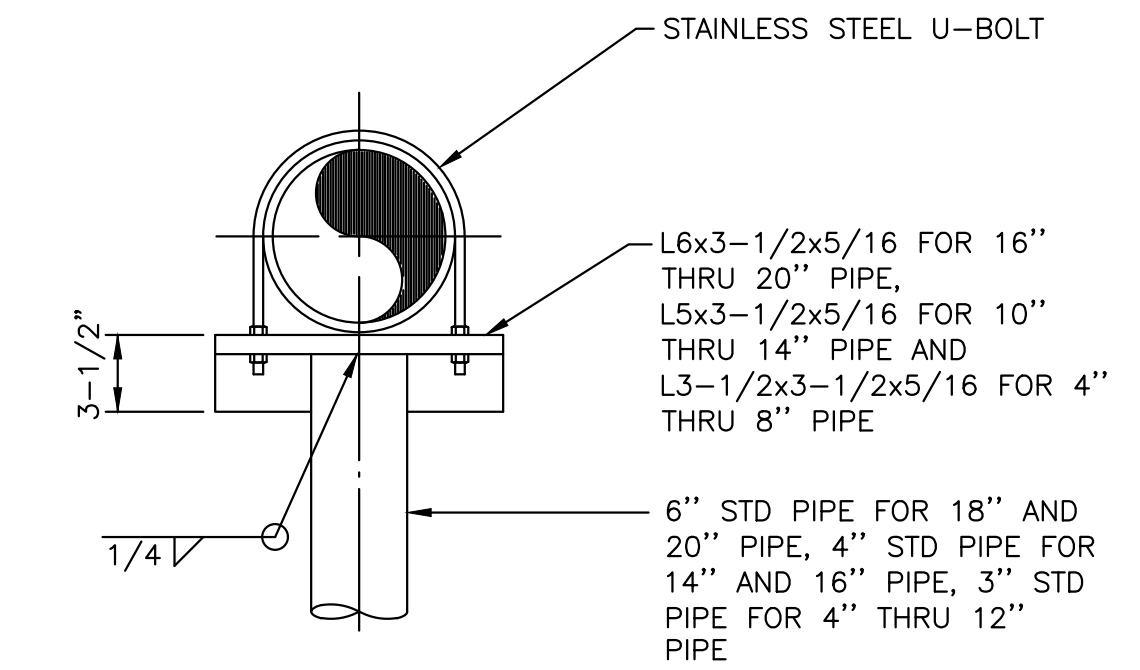


NOTE: USE STANDARD AWWA RING FLANGE FOR BASE.

PIPE SUPPORT
NOT TO SCALE

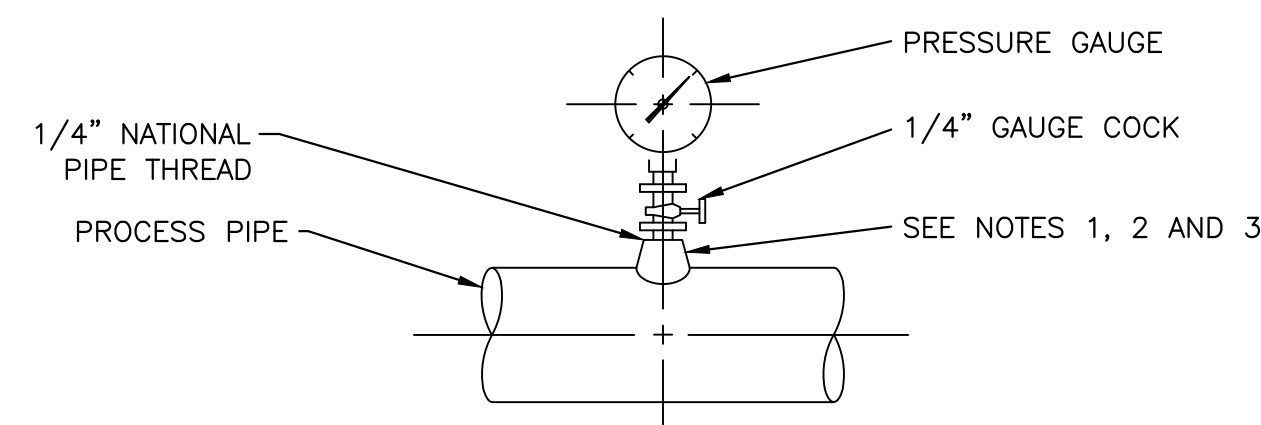

PRESSURE GAUGE

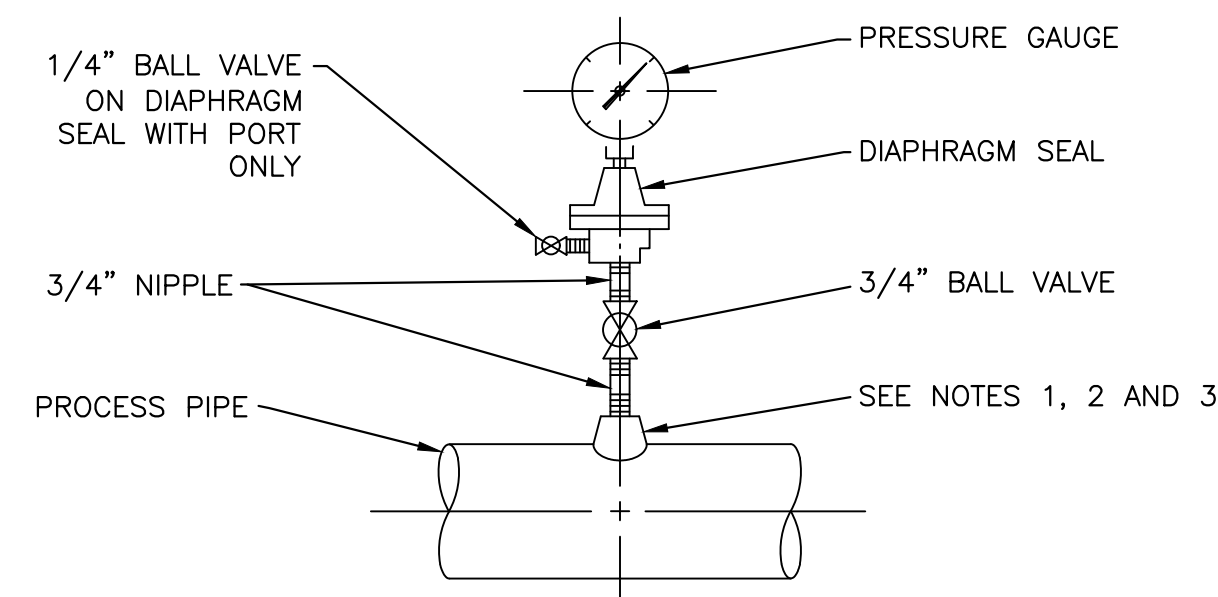


DIAPHRAGM PRESSURE GAUGE


NOTES:

1. FOR STEEL, GALVANIZED STEEL, AND PVC 2 1/2" AND SMALLER, USE A BUSHING IN A TEE.
2. FOR DUCTILE IRON AND FIBERGLASS REINFORCED PLASTIC PIPE. ALL SIZES, USE PIPE SADDLE WITH BUSHING.
3. FOR STEEL AND STAINLESS STEEL PIPES 3" AND LARGER, AND PRESSURE VESSELS, USE THRED-O-LET AS SHOWN.
4. PROVIDE SNUBBER FOR POSITIVE DISPLACEMENT PUMP INSTALLATIONS.


PRESSURE GAUGE MOUNTING DETAILS
NOT TO SCALE

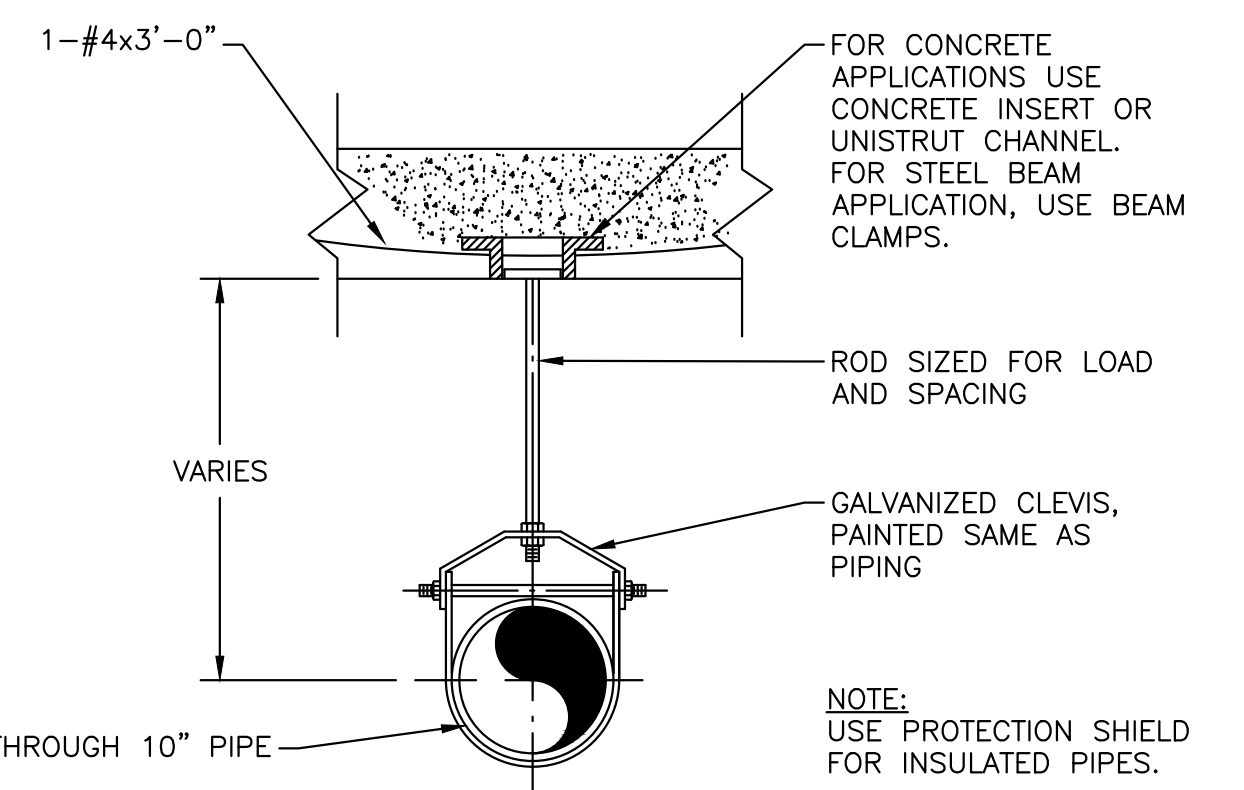

PIPE HANGER
NOT TO SCALE

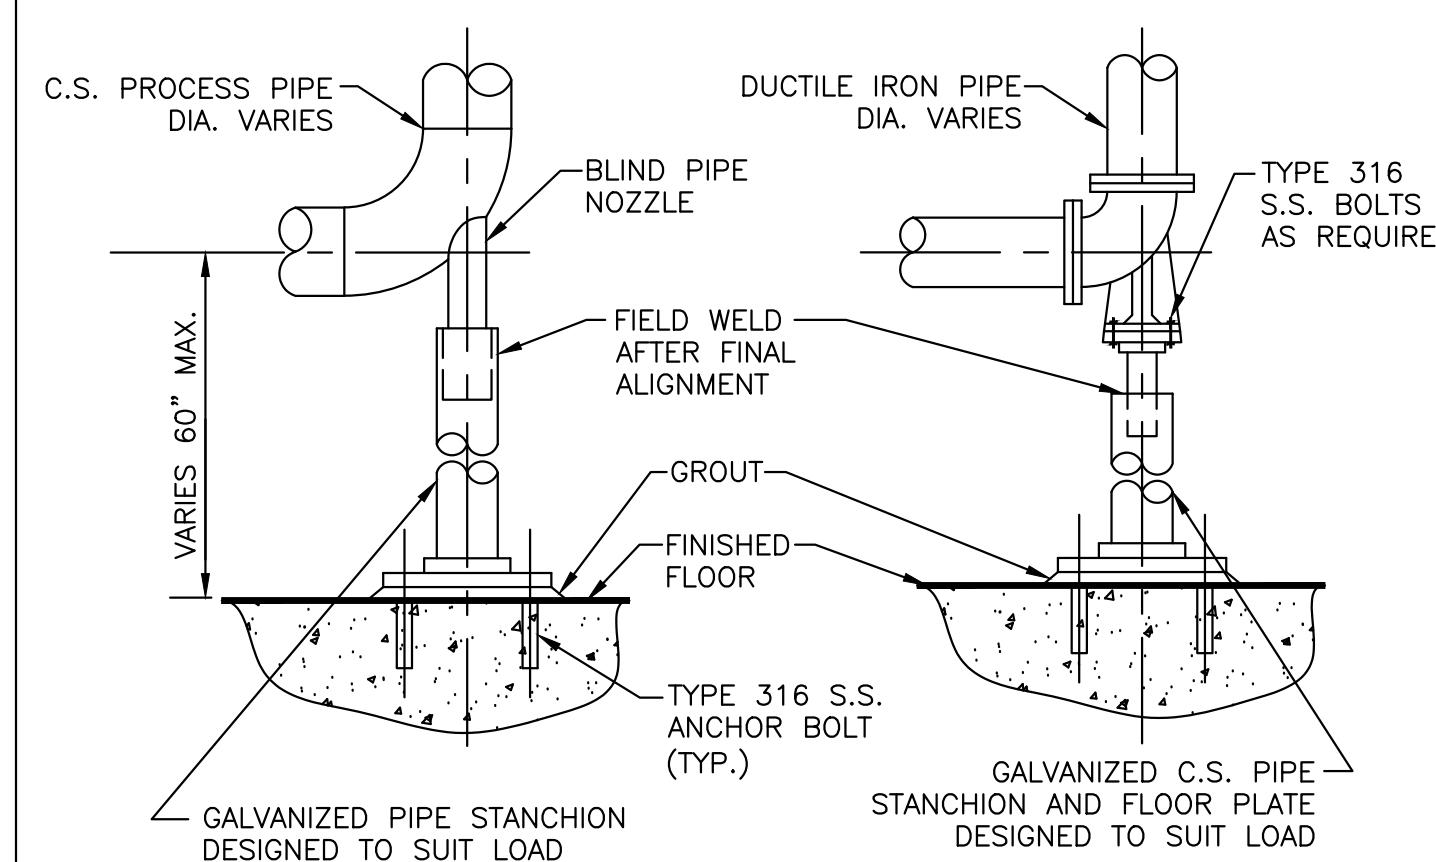


FLOOR PIPE SADDLE
NOT TO SCALE

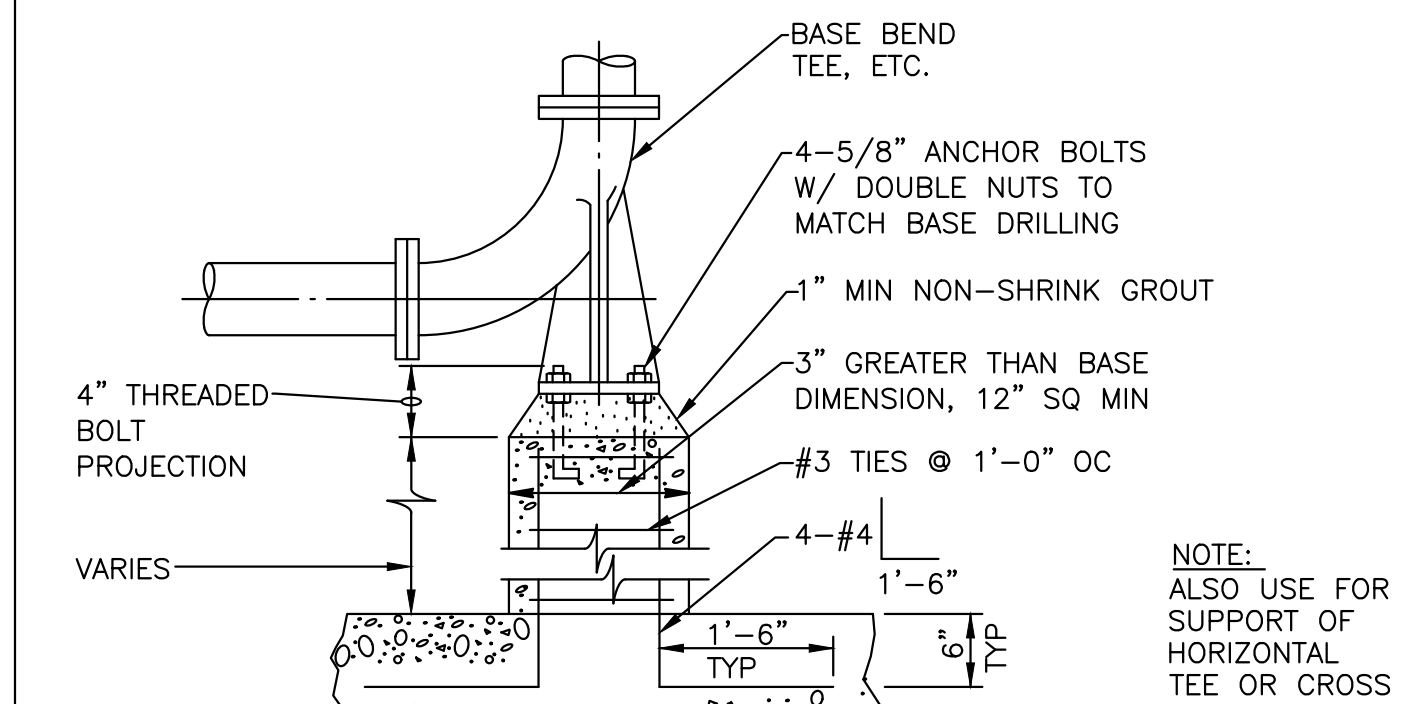

BASE BEND
NOT TO SCALE


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PROPOSED ALUMINUM BAR GRATING AND SUPPORTS TO BE DESIGNED BY GRATING FABRICATOR (TYP.)

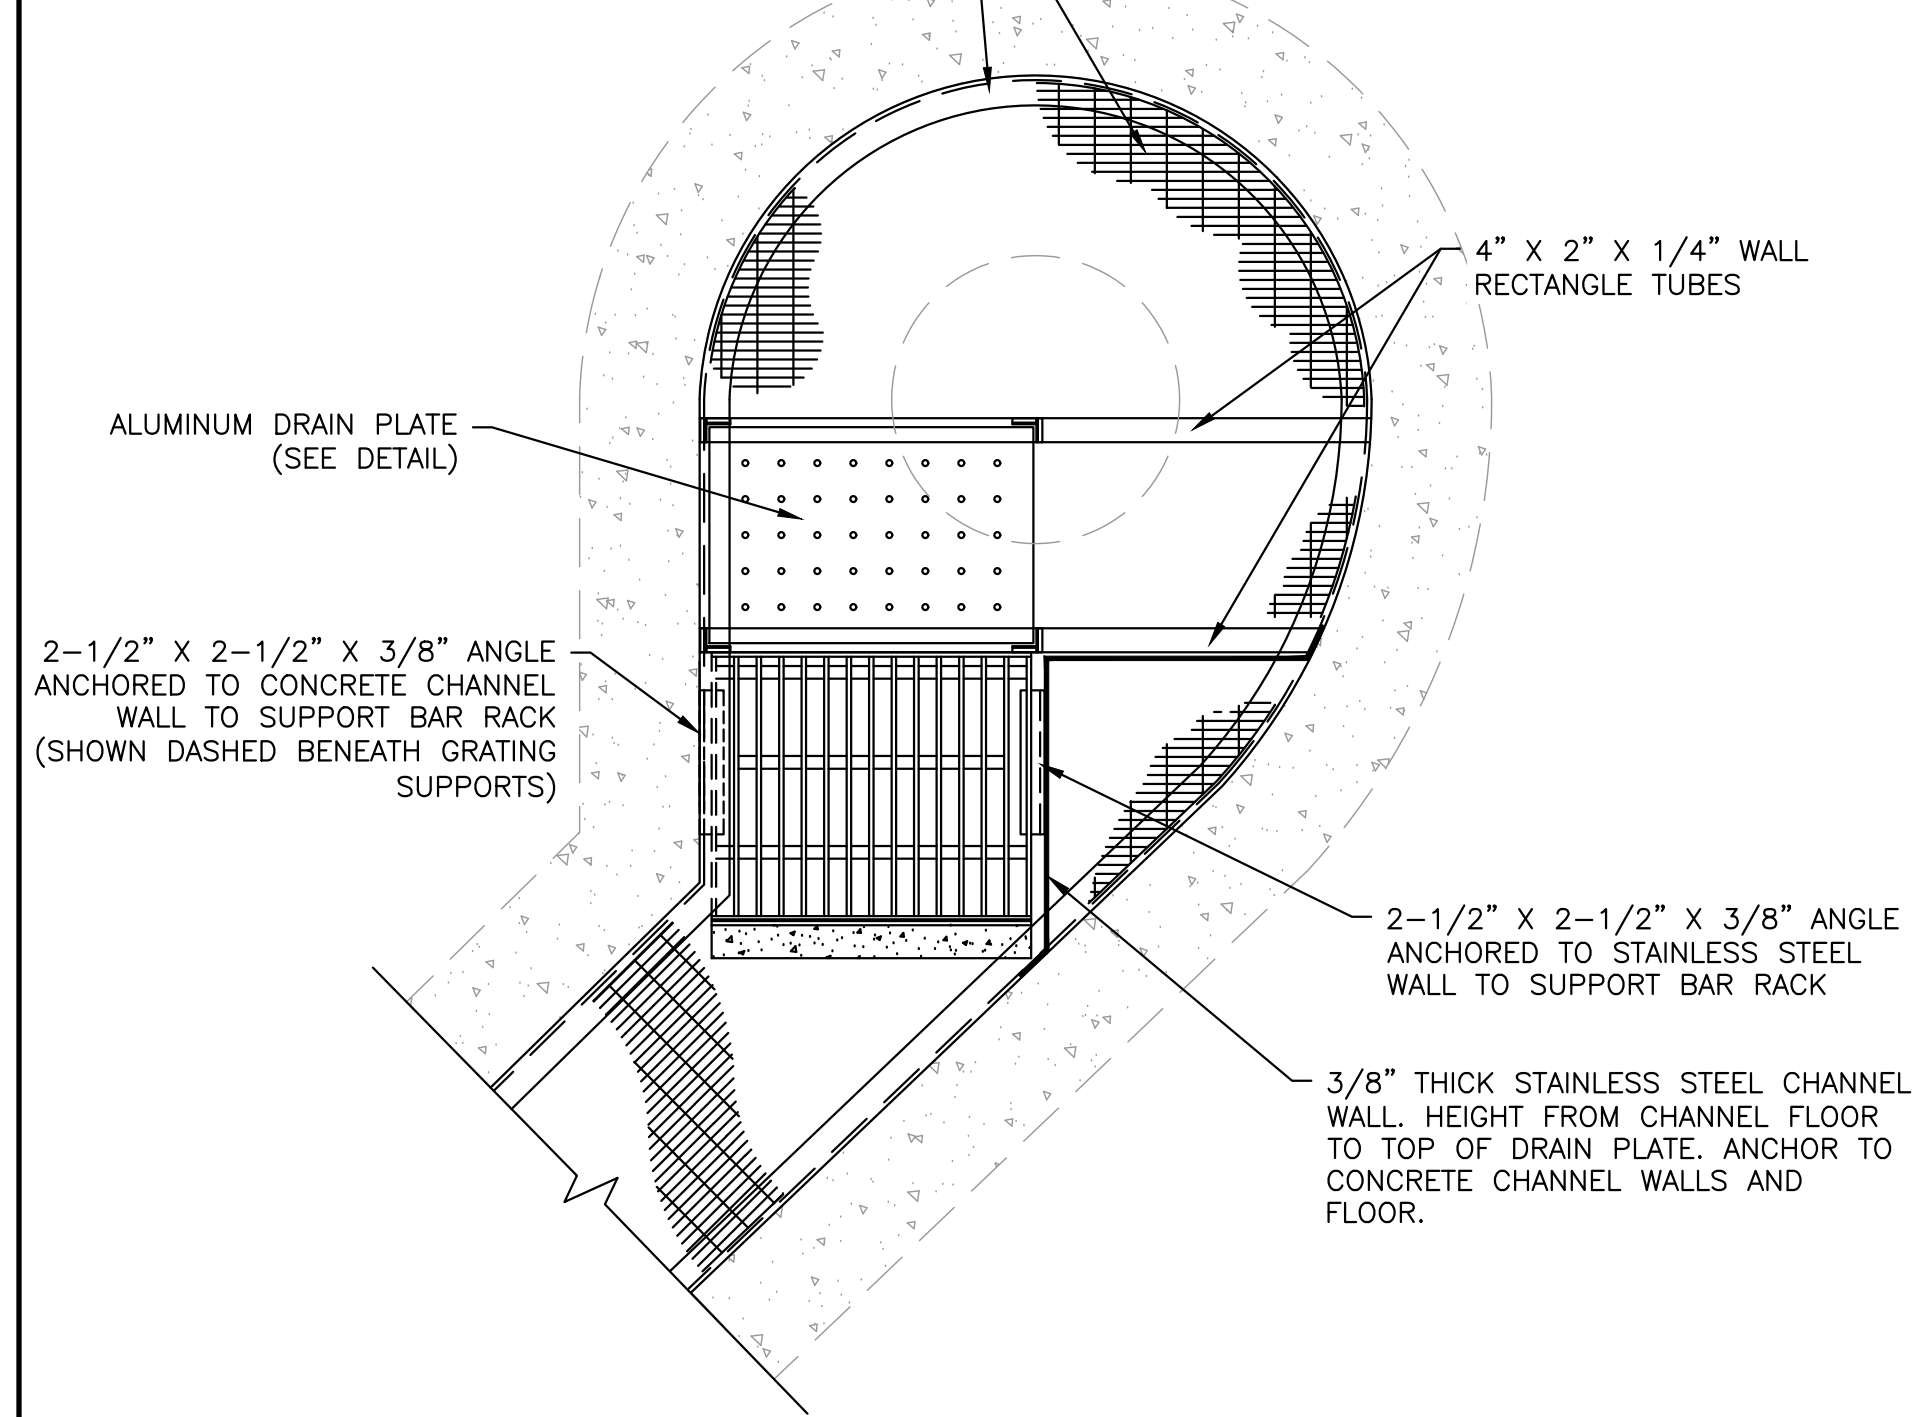

BAR RACK DETAIL - PLAN
NOT TO SCALE


DRAIN PLATE LOCATED BELOW BOTTOM OF GRATING SUPPORTS

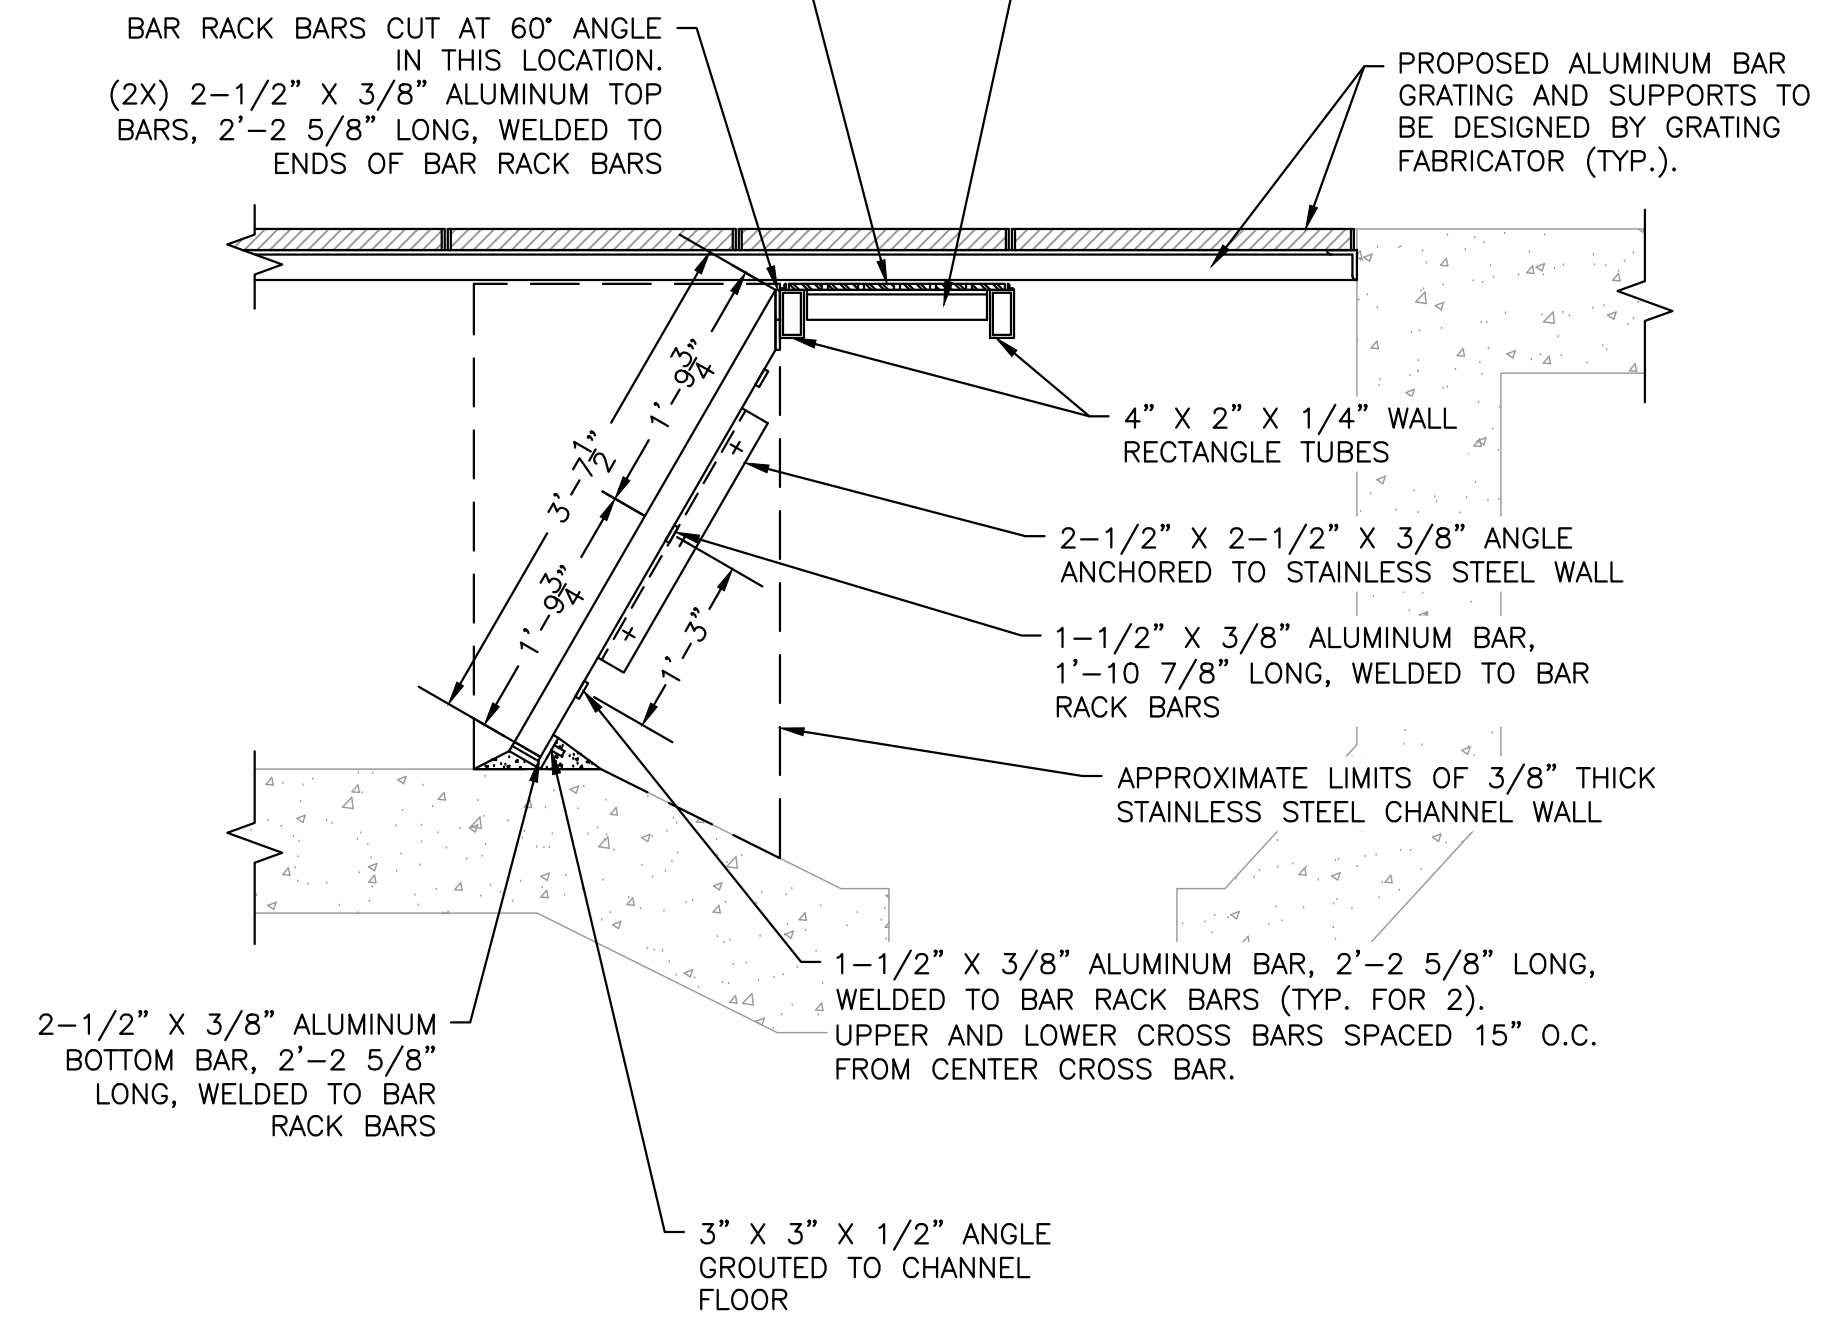


BAR RACK DETAIL - PROFILE
NOT TO SCALE

NOTES:
1. ANGLE OF THE BAR RACK IS 30° FROM THE VERTICAL AXIS.
2. BAR RACK SHALL NOT EXTEND BEYOND THE BOTTOM OF THE ALUMINUM BAR GRATING.


BAR RACK BARS CUT AT 60° ANGLE IN THIS LOCATION. (2X) 2-1/2" X 3/8" ALUMINUM TOP BARS, 2'-2 5/8" LONG, WELDED TO ENDS OF BAR RACK BARS

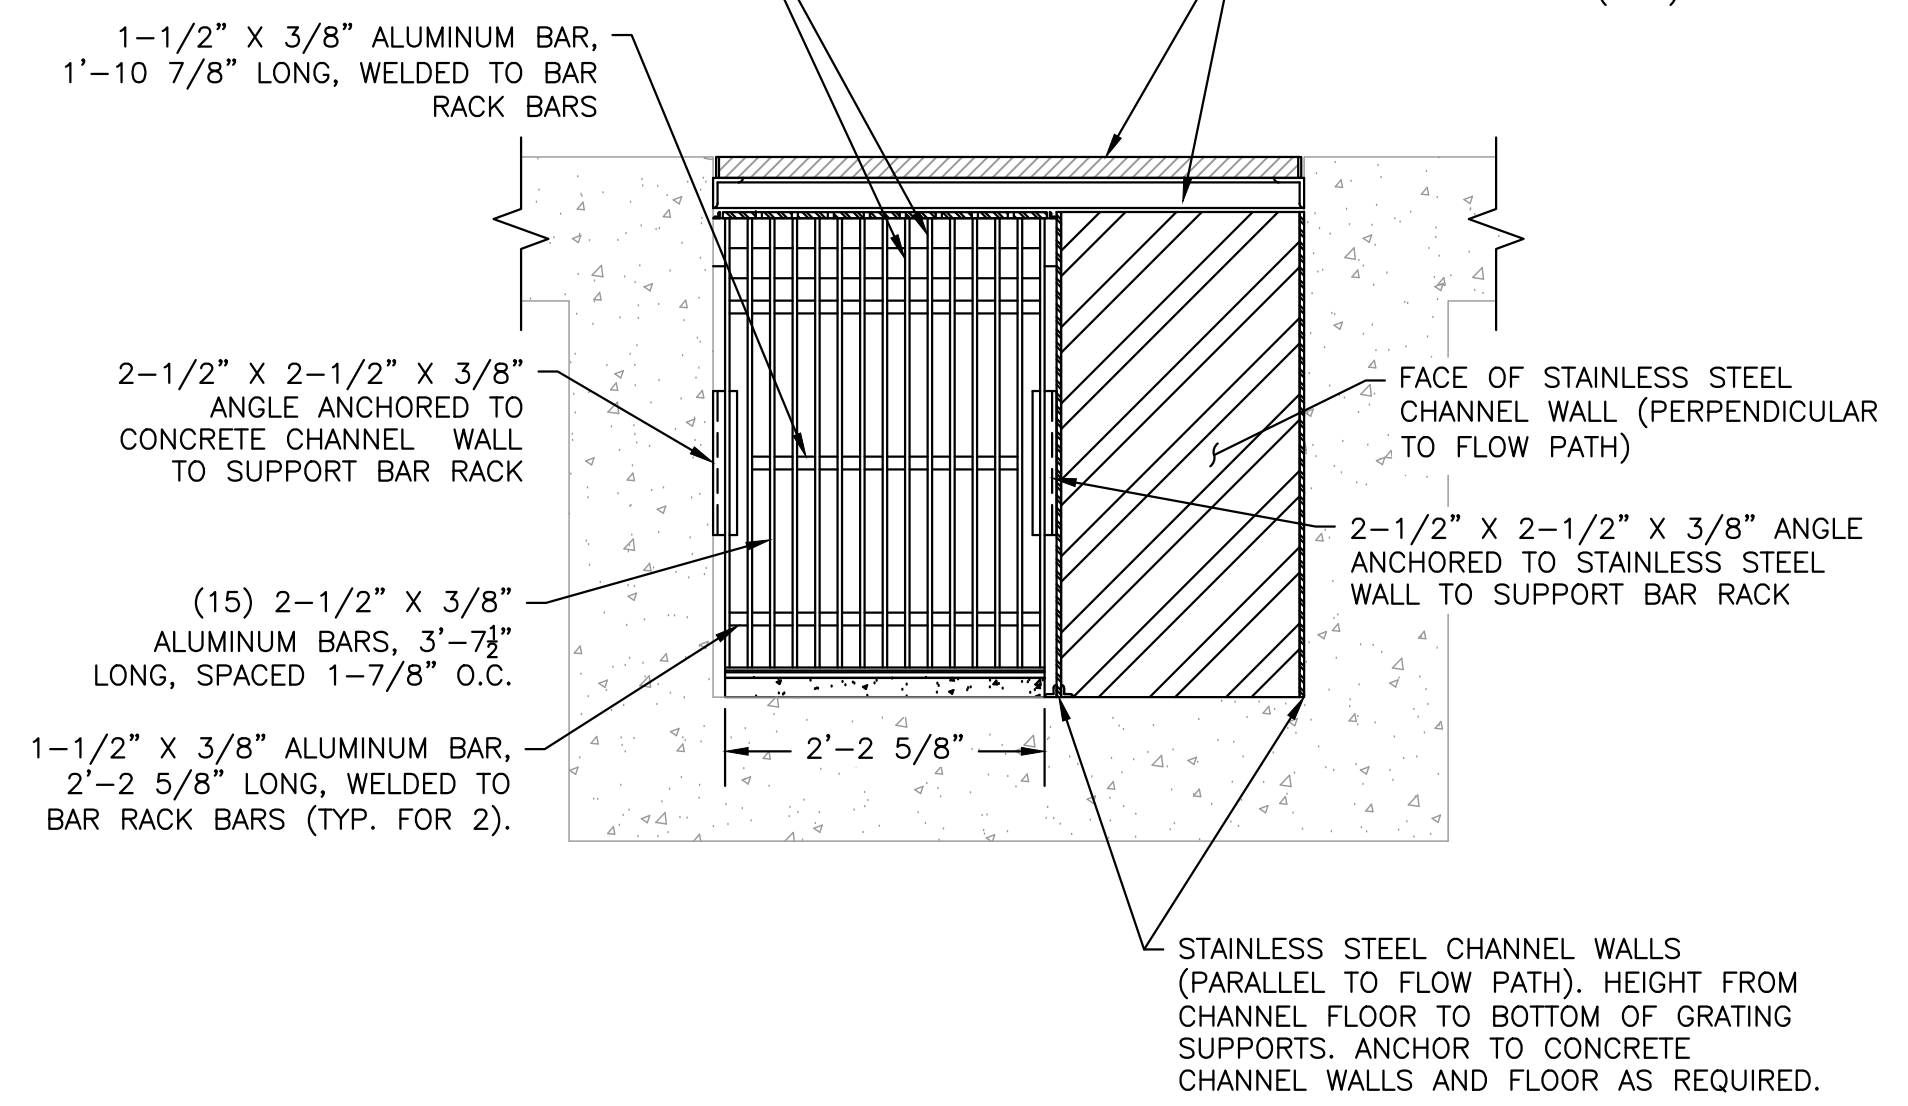


BAR RACK DETAIL - ELEVATION
NOT TO SCALE

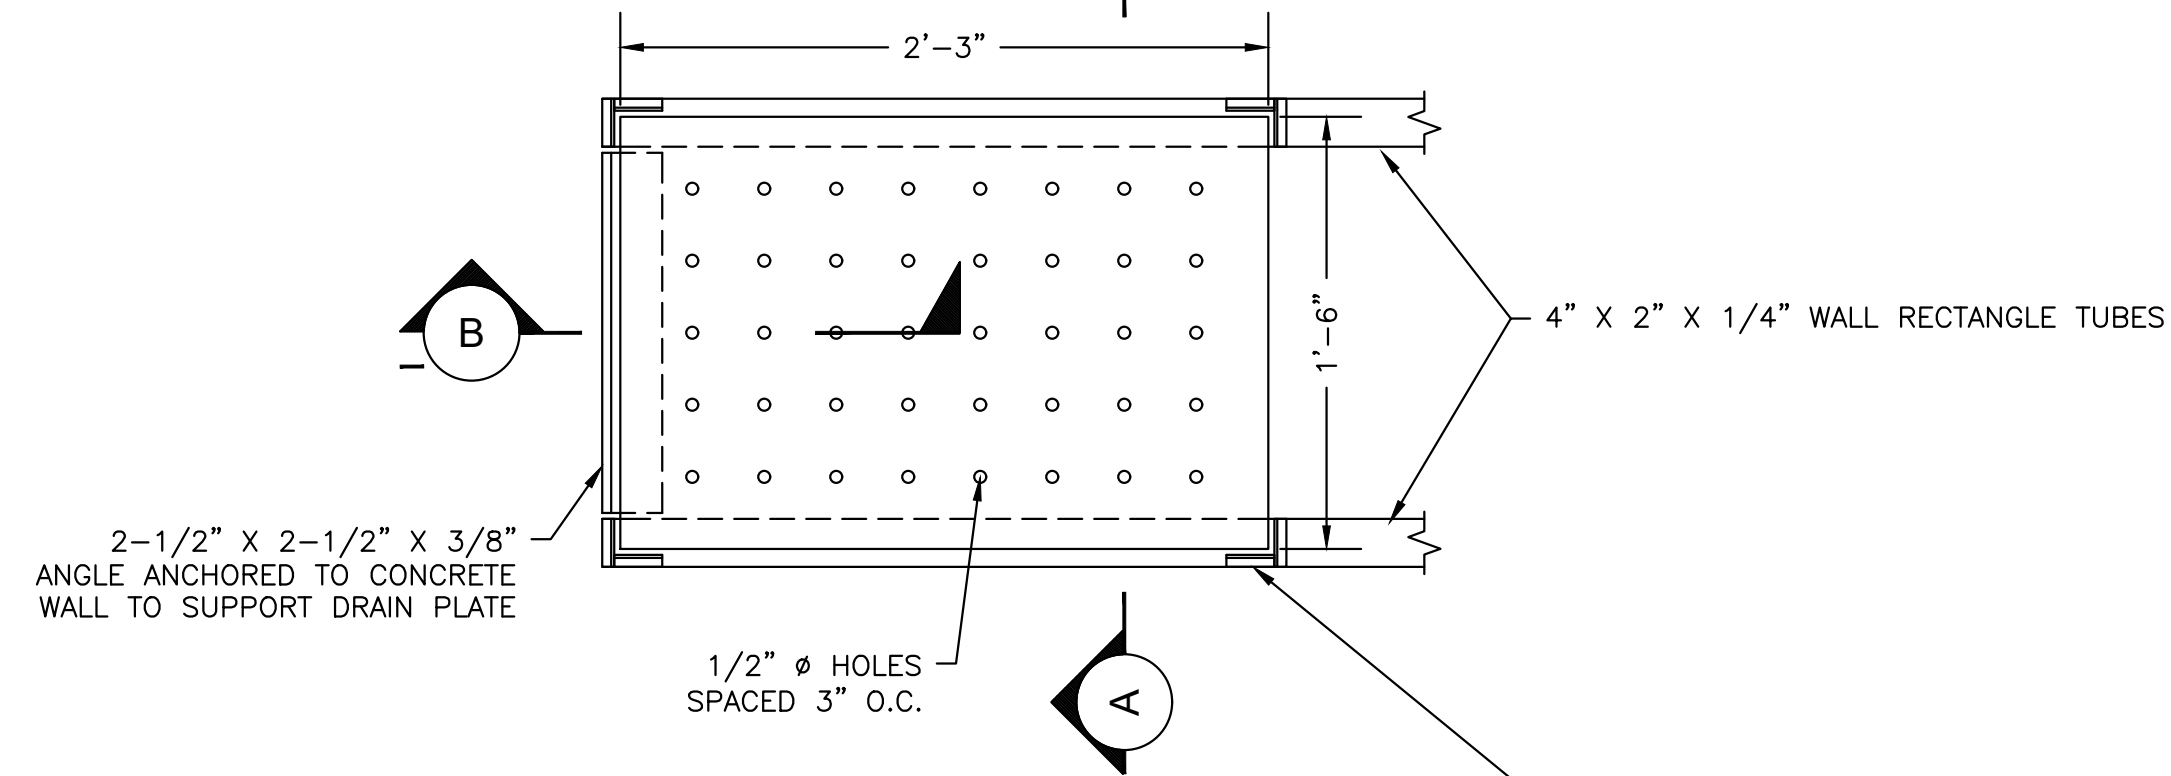

PLAN


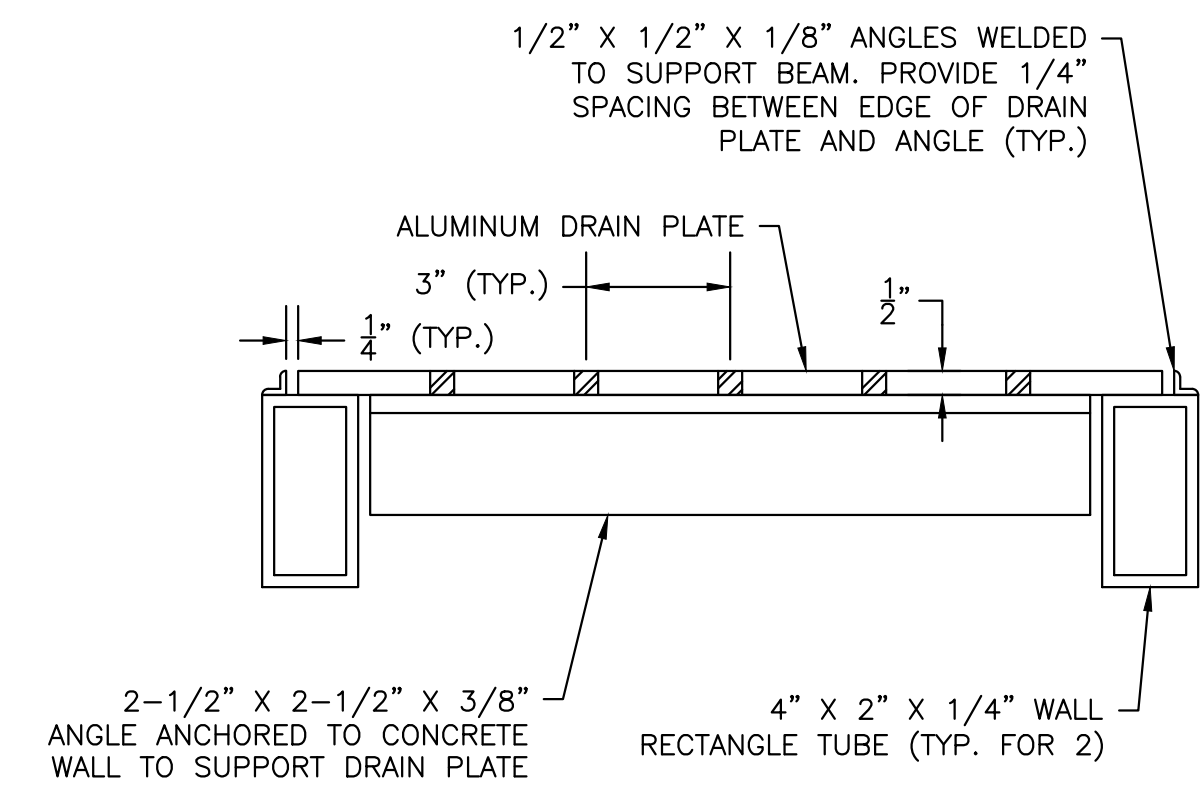


SECTION A-A

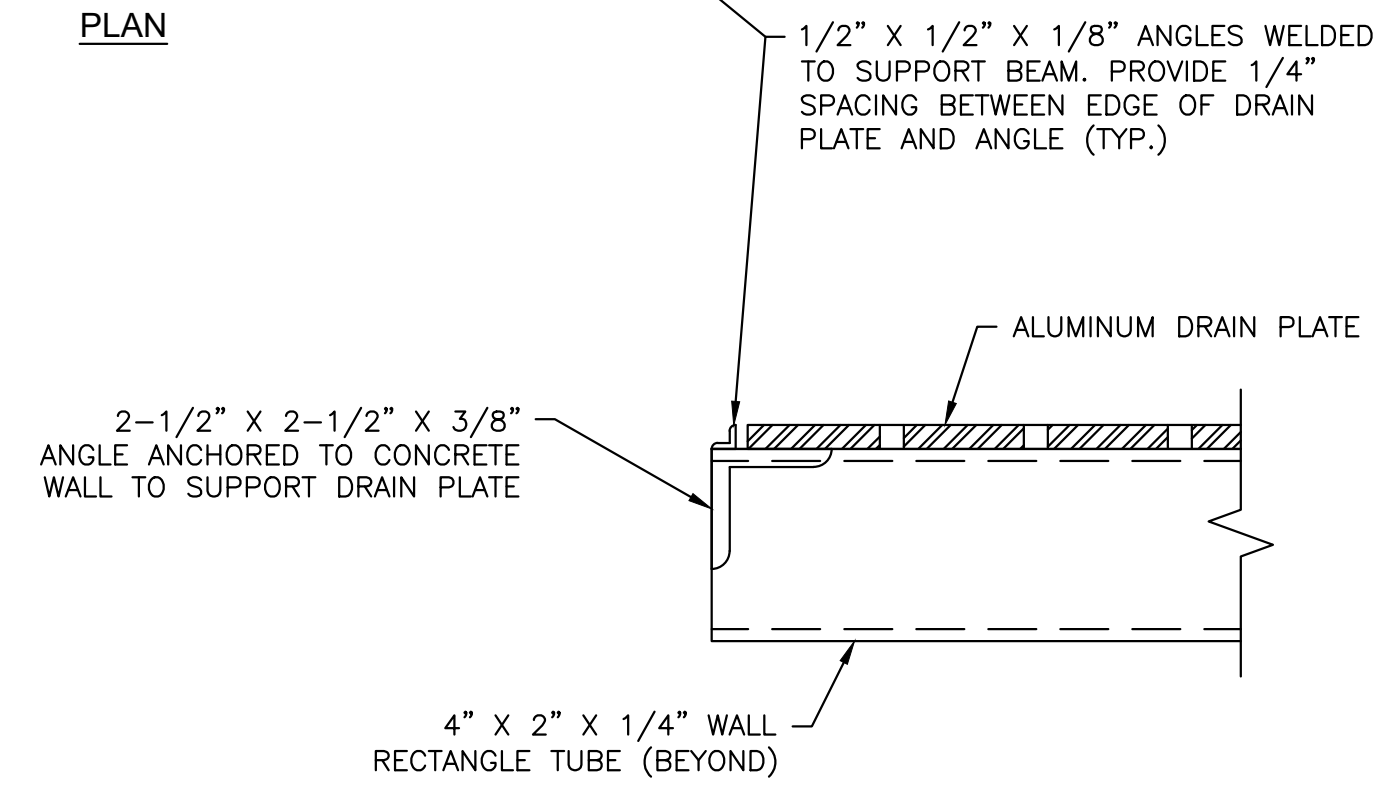

SECTION B-B

DRAIN PLATE DETAILS
NOT TO SCALE

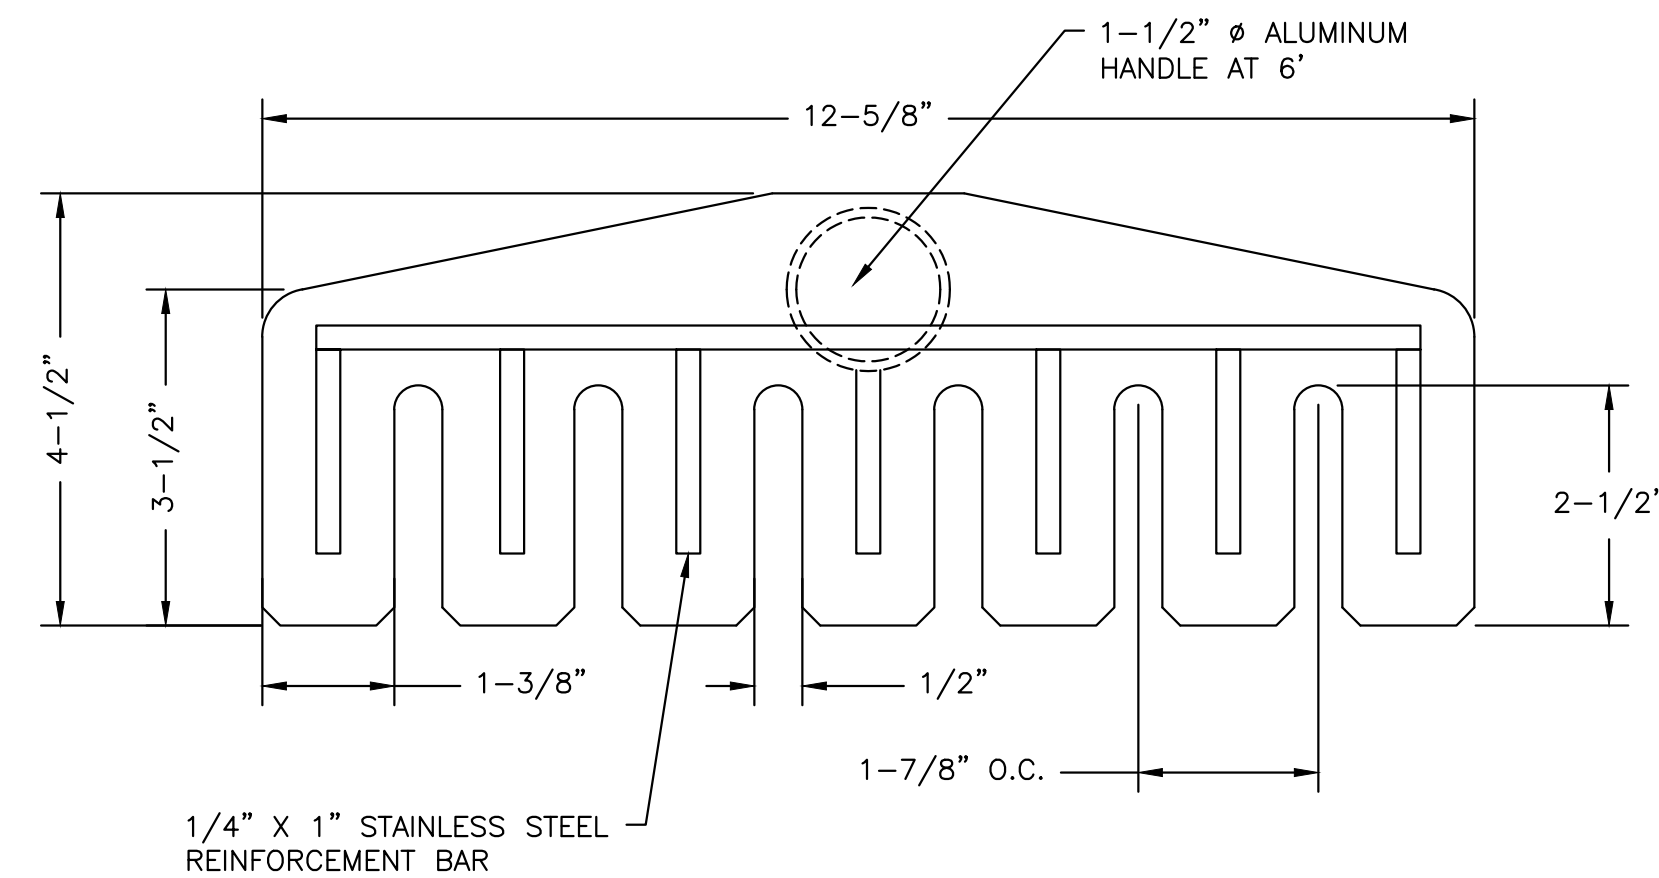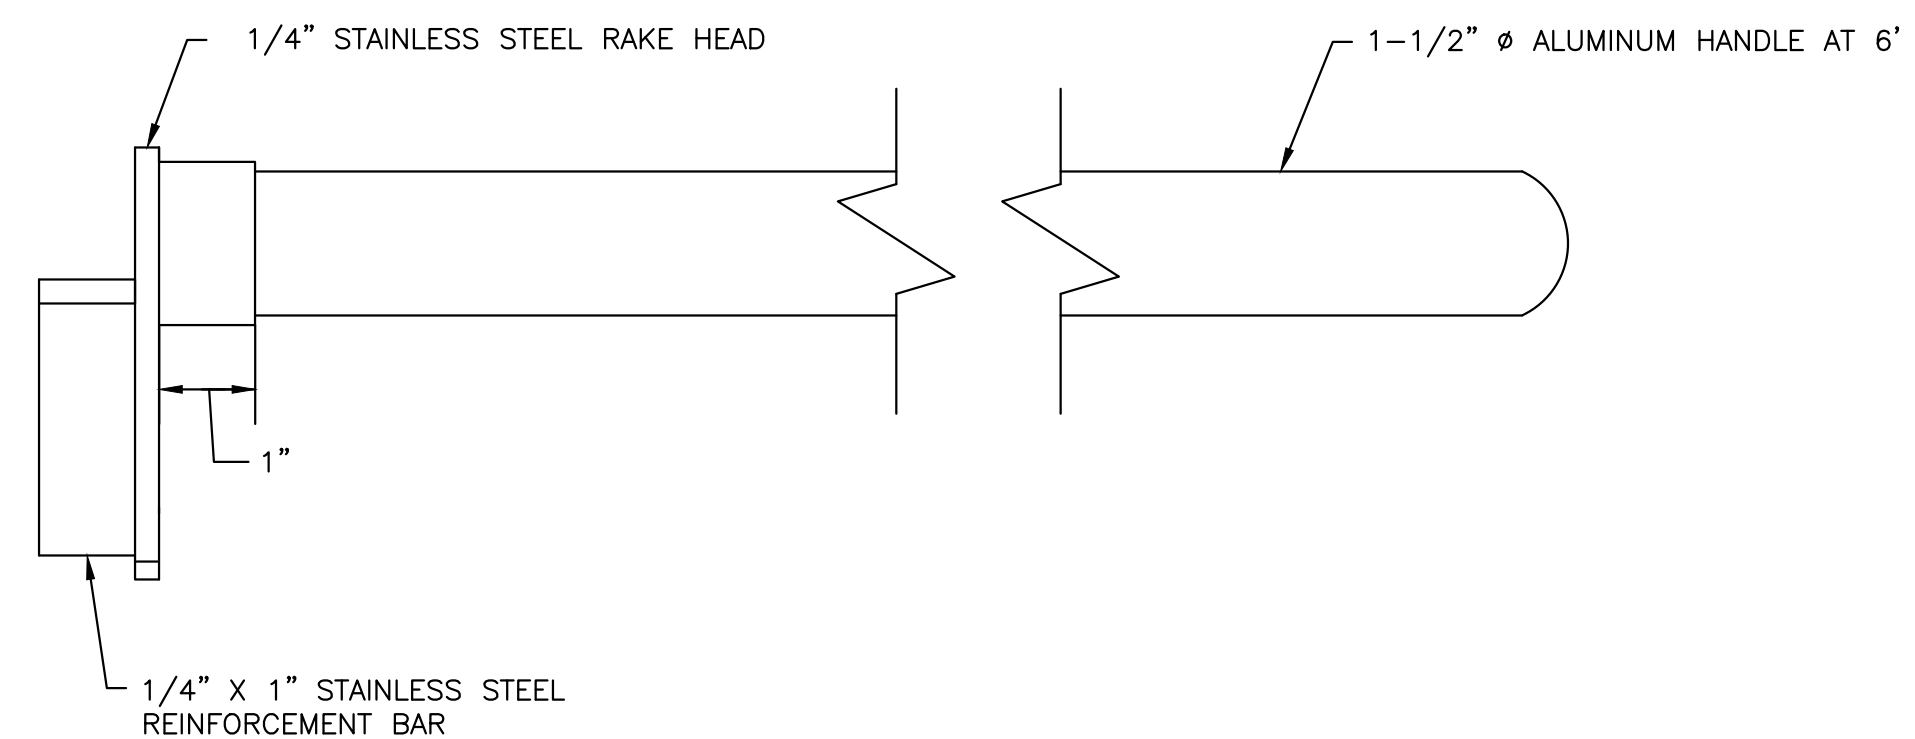


BAR RACK RAKE
NOT TO SCALE

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**BURRILLVILLE WWTF
HEADWORKS &
OAKLAND PUMP
STATION
IMPROVEMENTS**

BURRILLVILLE, RI

TITLE

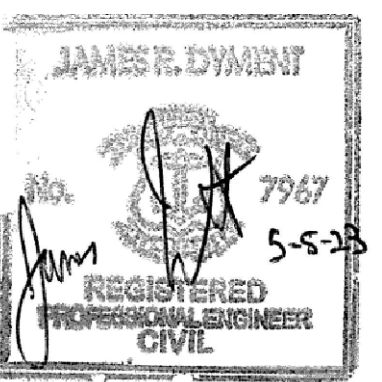**MECHANICAL
DETAILS - II**

NO.	REVISIONS	DATE

DRAWN BY:	CJM
DESIGNED BY:	AJG
CHECKED BY:	JRD
ISSUE DATE:	MAY 2023
BETA JOB NO.:	6861-105

SCALE
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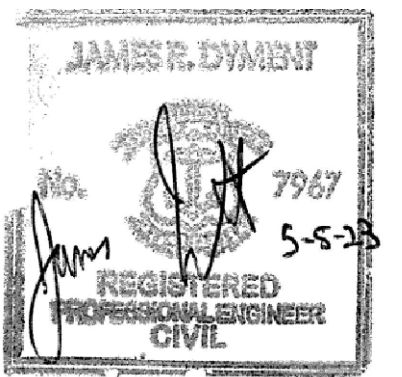
MD-2

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BURRILLVILLE, RI

TITLE

**MECHANICAL
DETAILS - III**

NO.	REVISIONS	DATE

DRAWN BY:	CJM
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SCALE
AS SHOWN

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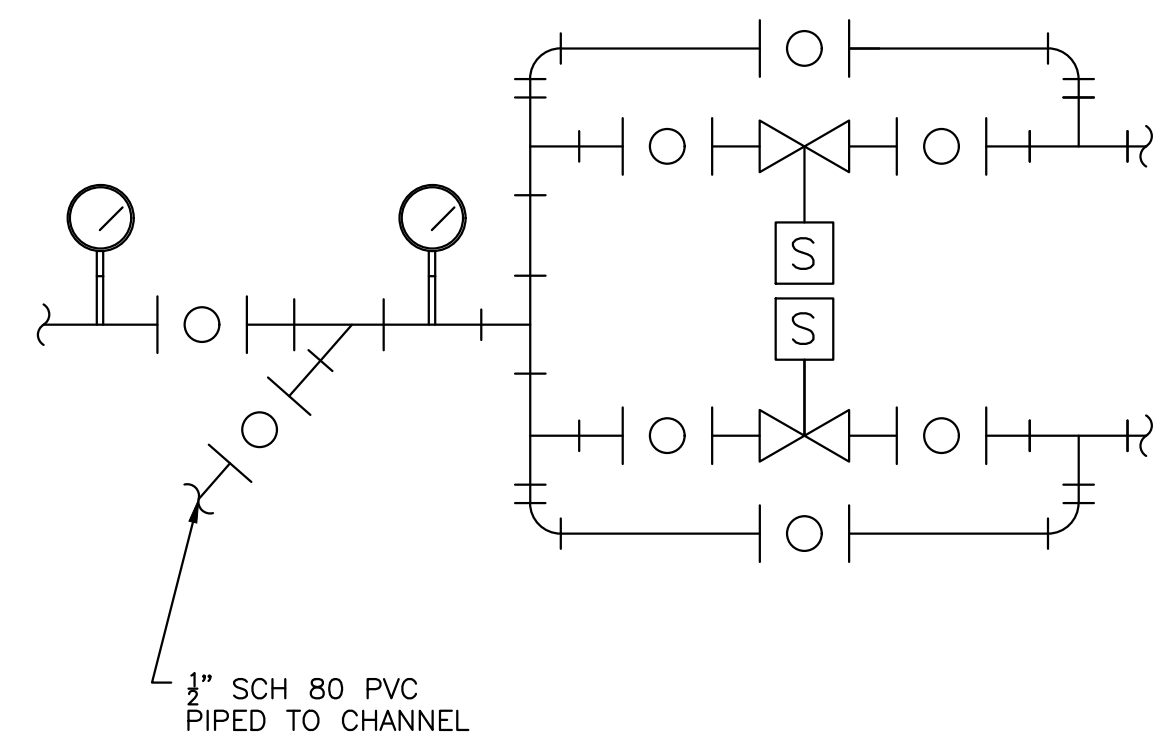
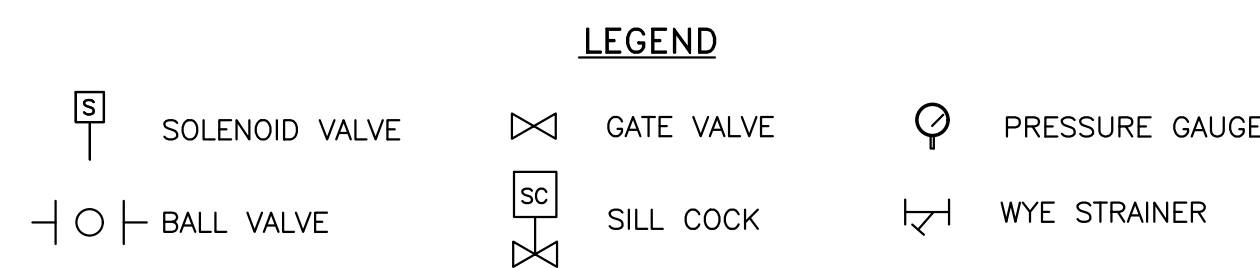
SHEET NO.
MD-3

SLUICE GATE SCHEDULE (WWTF HEADWORKS)							
DESIGNATION	TYPE	SIZE (WxH)	GATE MATERIAL	MOUNTING TYPE	OPERATOR	OPENING INVERT ELEV. (FT)	OPERATING FLOOR ELEV. (FT)
G-1	NON-RISING STEM MULTI-LEAF	24"x28"	316 SS	CHANNEL MOUNTED	NUT	296.6 ±	300.8
G-2	NON-RISING STEM MULTI-LEAF	24"x28"	316 SS	CHANNEL MOUNTED	NUT	296.6 ±	300.8
G-3	NON-RISING STEM MULTI-LEAF	24"x32"	316 SS	CHANNEL MOUNTED	NUT	296.6 ±	300.8
G-4	NON-RISING STEM MULTI-LEAF	24"x32"	316 SS	CHANNEL MOUNTED	NUT	296.6 ±	300.8
SG-1	SELF CONTAINED RISING STEM	24"x30"	316 SS	WALL MOUNTED	MOTOR OPERATED	286.3 ±	300.8

NOTE: DRILL EXISTING GATE THIMBLE AS REQUIRED TO INSTALL SG-1.


VALVE SCHEDULE (WWTF HEADWORKS)							
VALVE TAG	NO. REQUIRED	VALVE TYPE	SIZE	MATERIAL	ACTUATOR	LOCATION	CONNECTION
GV-1 TO GV-8	8	GATE VALVE	10"	DUCTILE IRON	MANUAL	PUMP ROOM	FL X FL
CV-1 TO CV-3	3	SWING CHECK	10"	CAST IRON	WEIGHTED LEVER	PUMP ROOM	FL X FL
PV-1	1	PLUG VALVE	14"	CAST IRON	CHAIN WHEEL	PUMP ROOM	FL X FL

WWTF - SLUICE GATE AND VALVE SCHEDULES
NOT TO SCALE




NOTES:
1. ALL SOLENOID VALVES TO HAVE BYPASS
CONFIGURATION AS SHOWN.

WASH PRESS WATER SUPPLY DETAIL
NOT TO SCALE

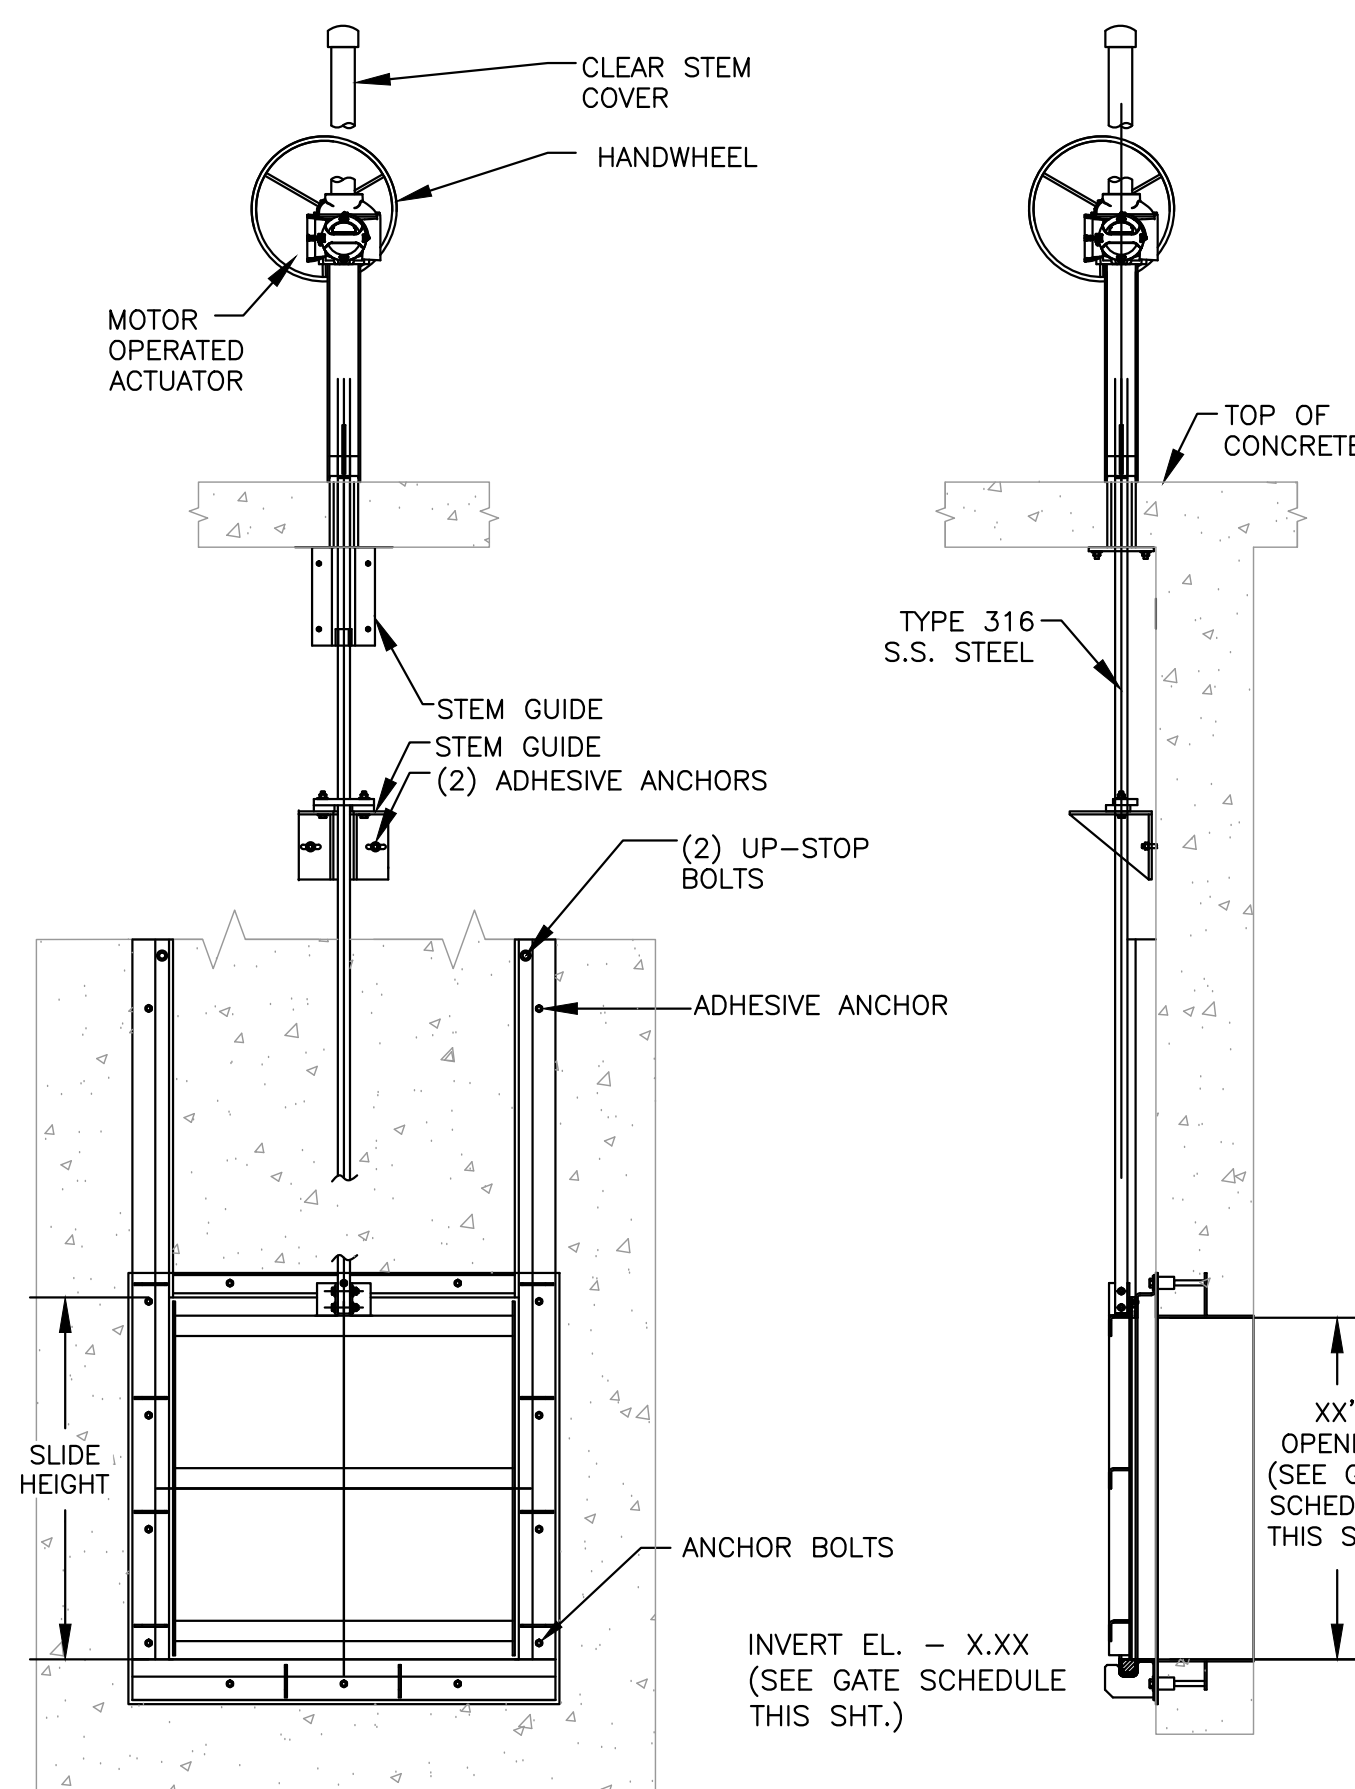

SLUICE GATE (SG-1)
NOT TO SCALE

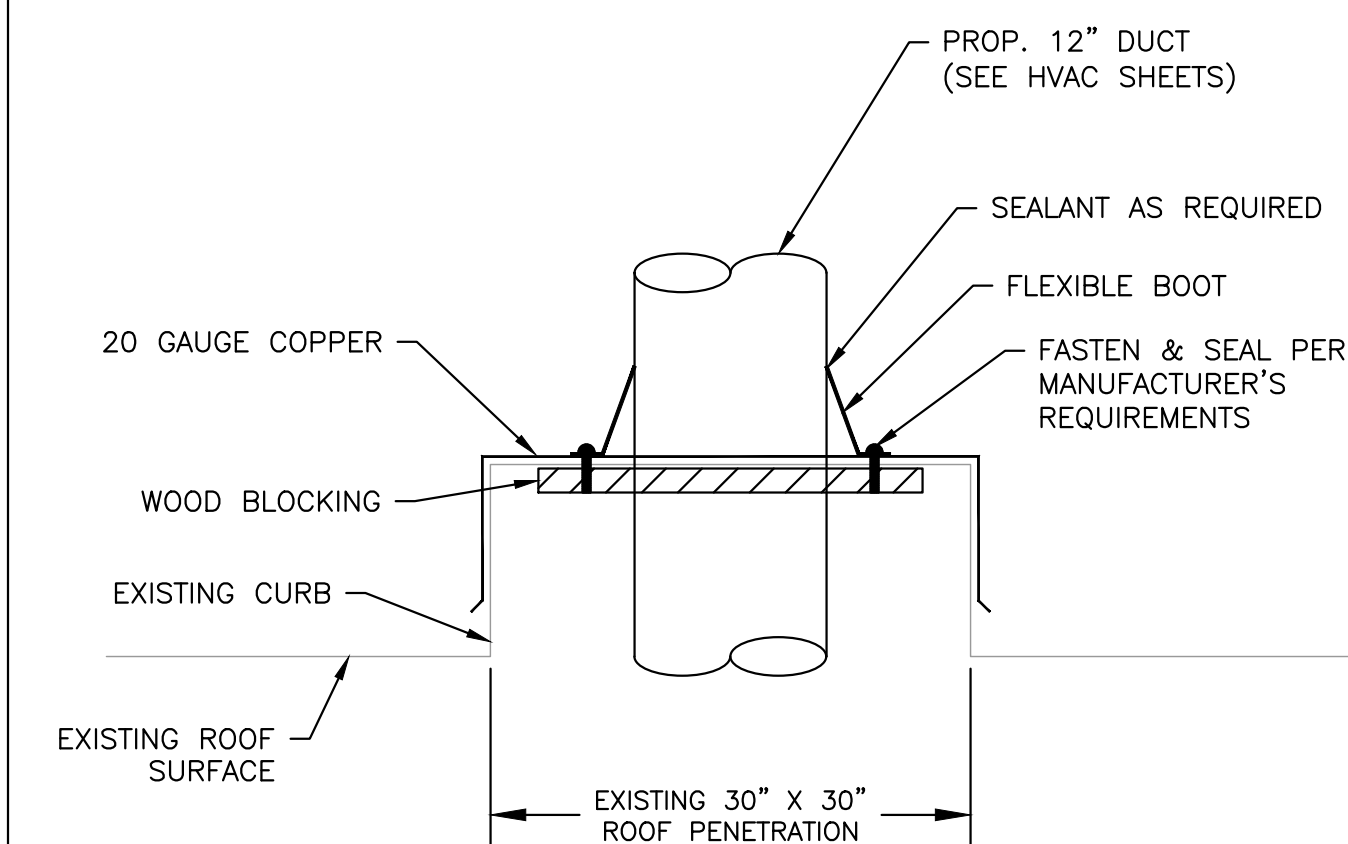


DUCTWORK ROOF PENETRATION DETAIL
NOT TO SCALE


PUMP SCHEDULE (OAKLAND PUMP STATION)										
PUMP TAG	PUMP CONFIGURATION	NO. REQUIRED	CAPACITY		MOTOR		DISCHARGE SIZE (IN)	TYPE	MINIMUM EFFICIENCY AT DESIGN POINT (%)	SHUT OFF HEAD (FT)
			FLOW (GPM)	TDH (FT)	POWER (HP)	PUMP SPEED (RPM)				
SP-1 SP-2	SINGLE PUMP OPERATION	2	470	94	25	1800	4"	SUBMERSIBLE SOLIDS HANDLING	56%	115

VALVE SCHEDULE (OAKLAND PUMP STATION)							
VALVE TAG	NO. REQUIRED	VALVE TYPE	SIZE	MATERIAL	ACTUATOR	LOCATION	CONNECTION
GV-1 TO GV-4	4	GATE VALVE	6"	DUCTILE IRON	MANUAL	DRY WELL	FL X FL
CV-1 TO CV-2	2	SWING CHECK	6"	CAST IRON	WEIGHTED LEVER	DRY WELL	FL X FL


OAKLAND - VALVE & PUMP SCHEDULES
NOT TO SCALE

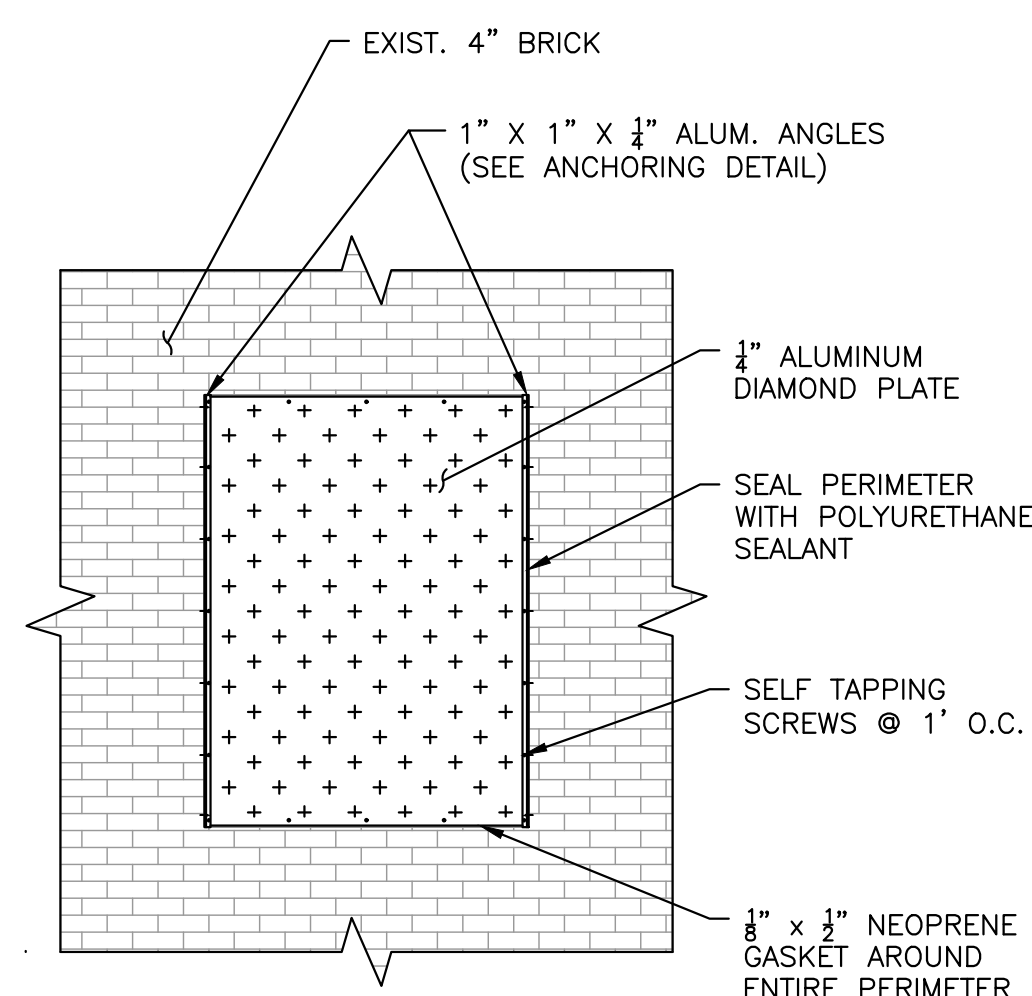

EXTERIOR ELEVATION - EAST WALL

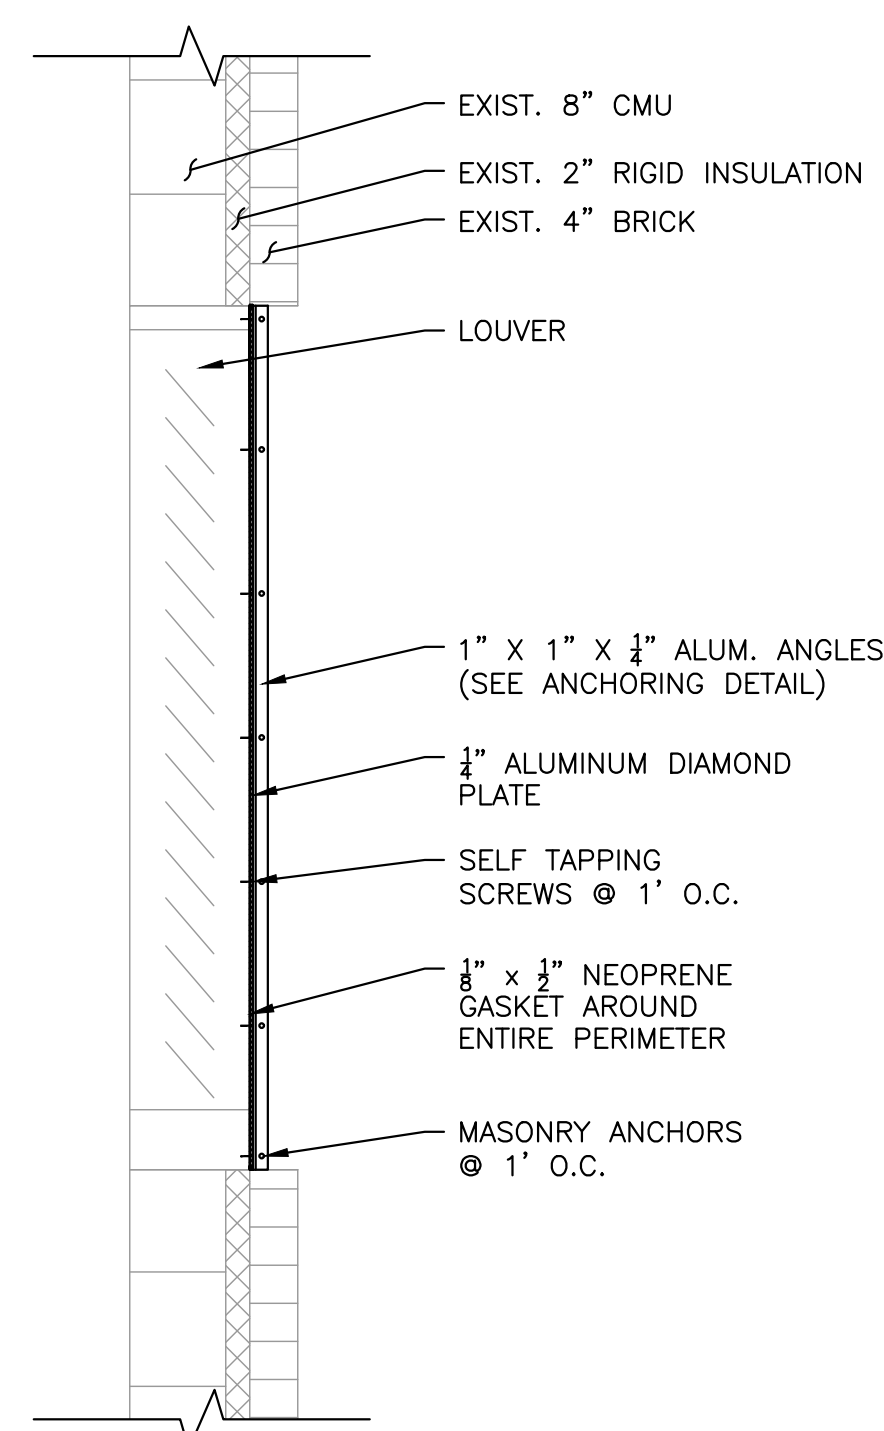

SECTION

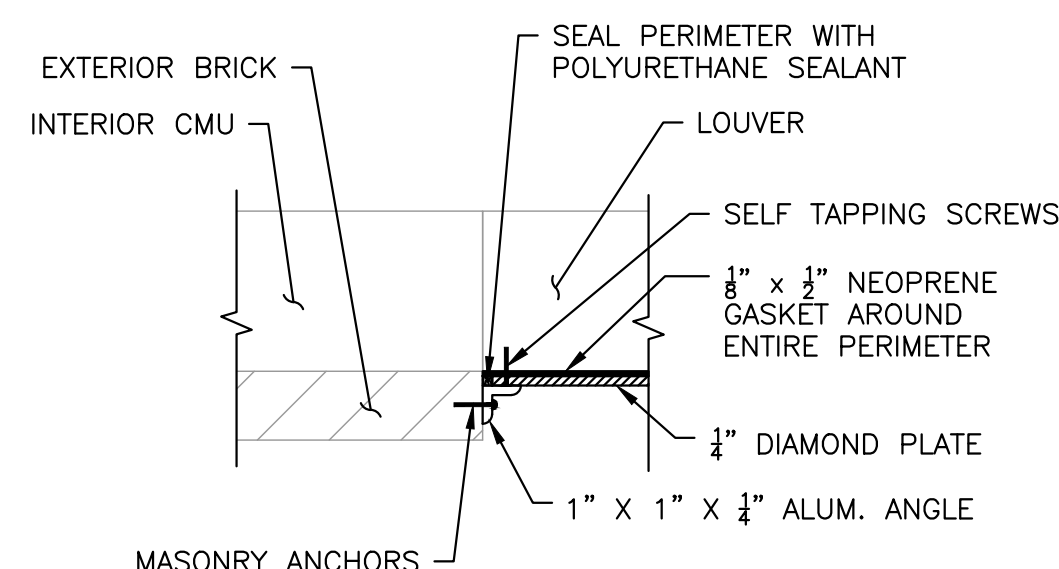


ANCHORING DETAIL - PLAN


PAINT EXTERIOR ALUMINUM AS FOLLOWS:

1. SURFACE PREPARATION: PRESSURE WASH WITH OAKITE AND SAND AND WITH 3M SCOTCH-BRITE NYLON PADS.
2. ONE COAT:
 - 2.1. TNEMEC N69/66HS HI-BUILD EPOXOLINE AT 2.0 MILS DFT.
 - 2.2. PPG PMC AMERLOCK 400 HI-BUILD EPOXY AT 2.0 TO 3.0 MILS DFT.
 - 2.3. DUPONT 25P HIGH SOLIDS AT 4.0 MILS DFT.
3. AND ONE COAT:
 - 3.1. TNEMEC 73 ENDURA-SHIELD AT 2.0 MILS DFT.
 - 3.2. PPG PMC AMERCOAT 450H POLYURETHANE AT 3.0 MILS DFT.
 - 3.3. DUPONT HIGH SOLIDS IMRON 2.8 AT 4.0 MILS DFT.

LOUVER DETAILS
NOT TO SCALE

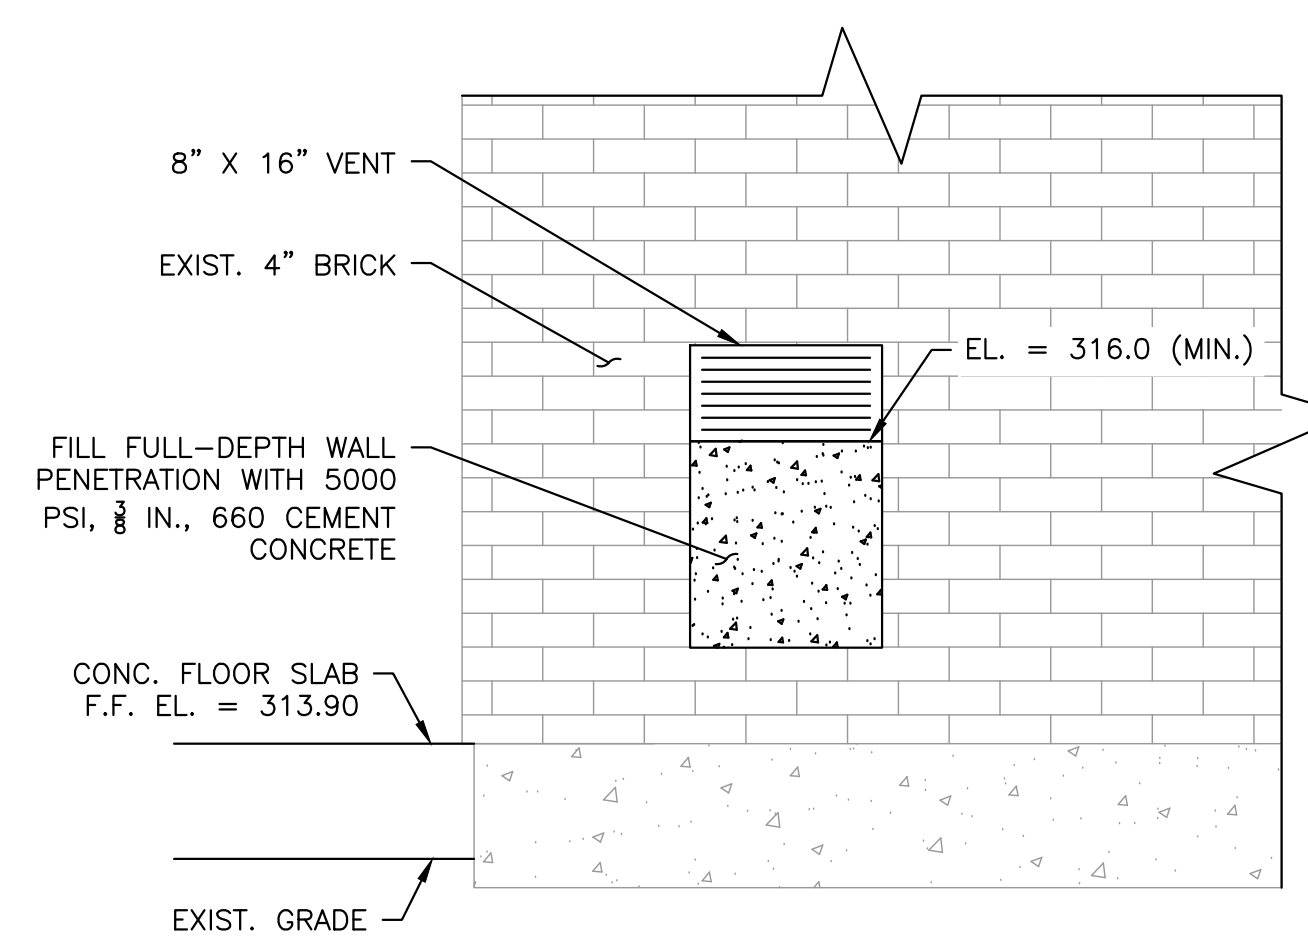


EXTERIOR ELEVATION - SOUTH WALL

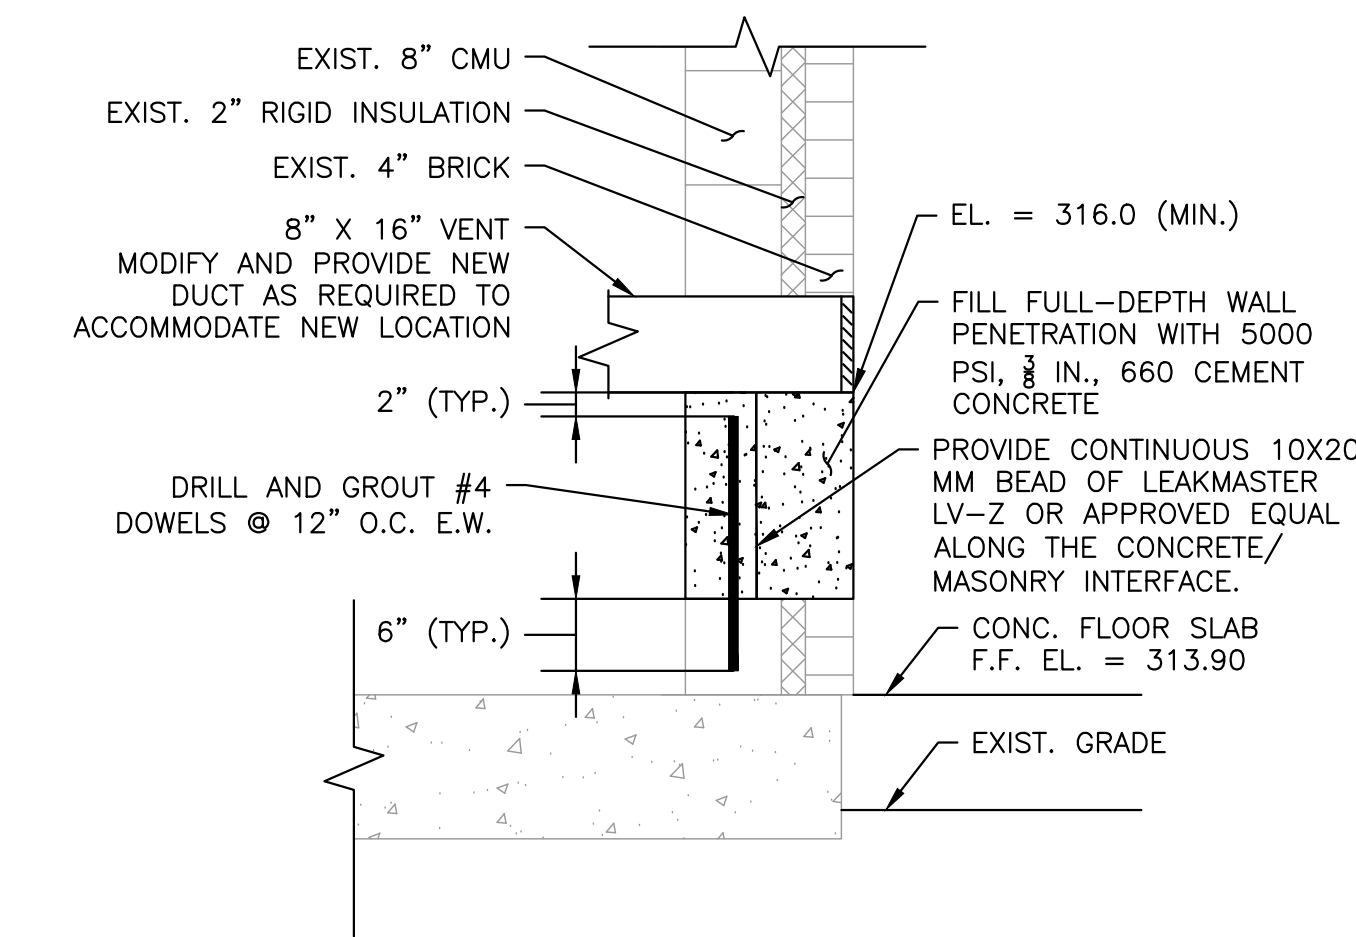


WALL SECTION

VENT RELOCATION AND CMU WALL REPAIR DETAIL
NOT TO SCALE

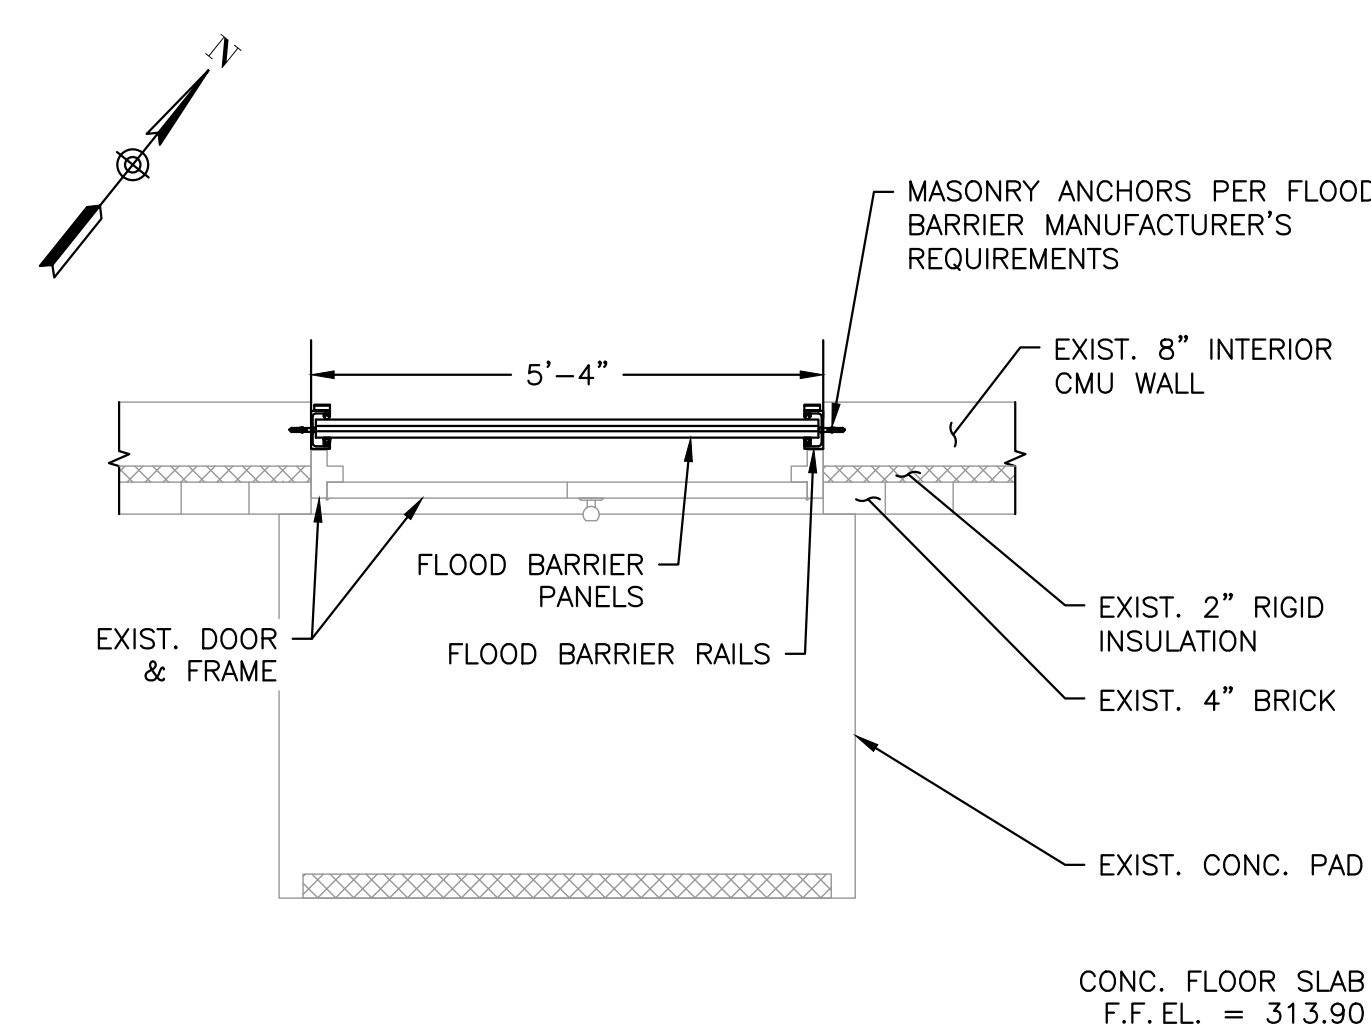

PLAN - ENTRANCE / SOUTH WALL

FLOOD BARRIER DETAIL
NOT TO SCALE

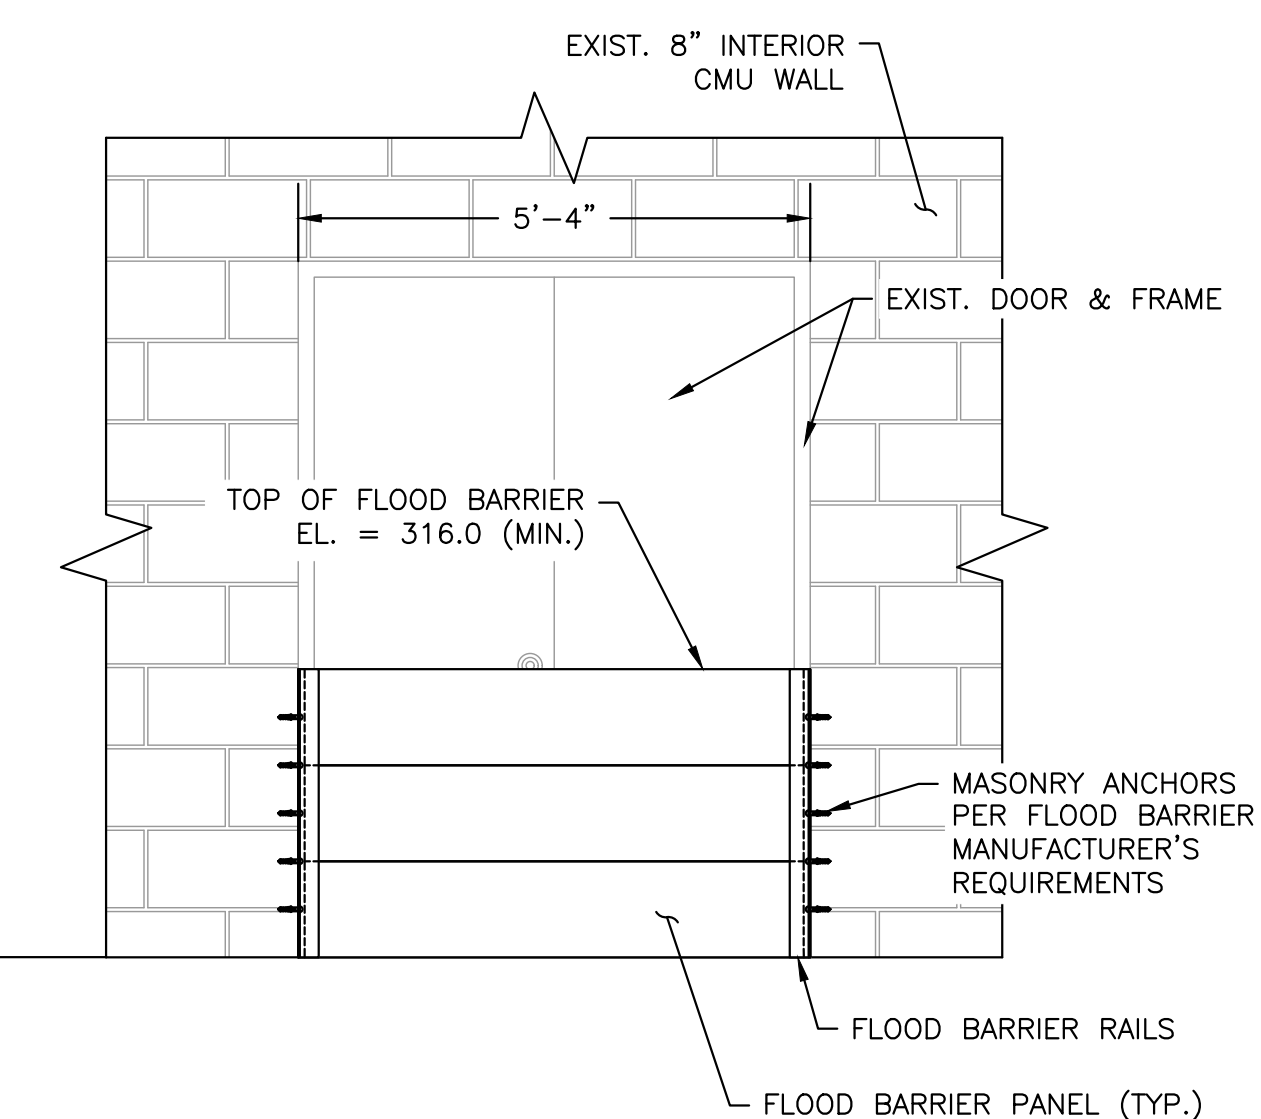


INTERIOR ELEVATION - SOUTH WALL

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**BURRILLVILLE WWTF
HEADWORKS &
OAKLAND PUMP
STATION
IMPROVEMENTS**

BURRILLVILLE, RI

TITLE

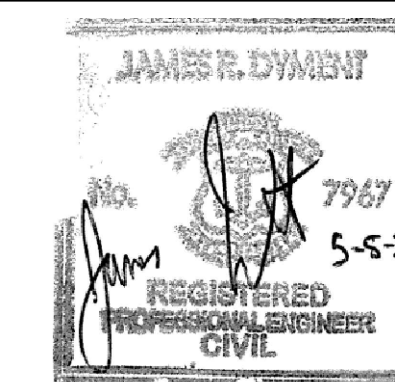**MECHANICAL
DETAILS - IV**

NO.	REVISIONS	DATE

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SCALE

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GENERAL NOTES

- 1. HVAC WORK IS INDICATED DIAGRAMMATICALLY. EXACT LOCATIONS OF ALL COMPONENTS ARE TO BE DETERMINED IN THE FIELD AND BY THE ACTUAL BUILDING CONDITIONS. EXISTING DUCTS, PIPING OR EQUIPMENT INTERFERING WITH OTHER INSTALLATIONS SHALL BE RELOCATED AS REQUIRED AT NO ADDITIONAL COST TO THE OWNER. EXACT LOCATIONS MUST HAVE THE APPROVAL OF THE ARCHITECT.
- 2. ALL WORK SHALL BE COORDINATED WITH ALL OTHER TRADES BEFORE ANY INSTALLATION IS MADE.
- 3. ALL EQUIPMENT SHALL BE INSTALLED IN ACCORDANCE WITH STATE CODES, MANUFACTURER'S APPROVED PUBLISHED LITERATURE, AND AUTHORITIES HAVING JURISDICTION.
- 4. INSTALLATION OF EQUIPMENT SHALL PERMIT ACCESSIBILITY FOR SERVICE AND/ OR REPLACEMENT.
- 5. ALL CEILING MOUNTED EQUIPMENT SHALL BE INSTALLED IN SUCH A WAY THAT LIGHTS, PIPING, AND DUCTWORK DO NOT BLOCK ACCESS TO UNITS AND RELATED ACCESSORIES.
- 6. HVAC CONTRACTOR SHALL COORDINATE ALL WALL, CEILING, FLOOR, ROOF AND BEAM PENETRATIONS WITH ARCHITECT AND STRUCTURAL ENGINEER.
- 7. ALL DUCT SIZES SHOWN ARE NET INSIDE CLEAR DIMENSIONS.
- 8. PROVIDE VOLUME DAMPERS AT EVERY MAIN BRANCH TAKE-OFF AND AS INDICATED AND IN SUCH OTHER LOCATIONS WHERE REQUIRED TO PROPERLY BALANCE THE SYSTEM. DO NOT INSTALL VOLUME DAMPERS IN NECKS OF DIFFUSERS OR AT DISCHARGE OR INLET GRILLES IN DUCTWORK.
- 9. PROVIDE INSTRUMENT TEST HOLES WITH CAPS IN AIR DISTRIBUTION SYSTEMS AS REQUIRED TO BALANCE SYSTEM.
- 10. HVAC CONTRACTOR SHALL BE RESPONSIBLE FOR ALL SHEETMETAL TRANSITIONS AT AIR TERMINAL UNITS, FANS, COILS, AND OTHER SIMILAR HVAC EQUIPMENT.
- 11. ALL OPEN ENDED DUCTS IN THE CEILING PLENUM SHALL BE UNOBSTRUCTED FOR A MINIMUM DISTANCE OF 24" FROM THE OPENING TO ALLOW FREE AIR FLOW AND SHALL HAVE 3/4" WIRE MESH SCREENING.
- 12. ALL MISCELLANEOUS STRUCTURAL SUPPORTS REQUIRED FOR HVAC EQUIPMENT INSTALLATION SHALL BE PROVIDED BY HVAC SUBCONTRACTOR.
- 13. EXACT LOCATION OF CEILING DIFFUSERS, GRILLES AND REGISTERS TO BE DETERMINED BY ARCHITECTURAL REFLECTED CEILING PLAN.
- 14. INSTALL ALL PIPING BELOW DUCTWORK UNLESS CLEARANCE CONDITION REQUIRES PIPING TO BE ABOVE.
- 15. EXACT ELEVATION FOR SIDE WALL DIFFUSERS, REGISTERS AND GRILLES SHALL BE APPROVED BY THE ARCHITECT BEFORE INSTALLATION.
- 16. UNLESS OTHERWISE NOTED, ALL PIPING RUNOUTS SHALL BE 3/4"
- 17. ALL EXPOSED EQUIPMENT (REGISTERS, UNIT HEATERS, ETC..) SHALL HAVE COLORS SELECTED BY THE ARCHITECT, UNLESS NOTED OTHERWISE.
- 18. HVAC SUBCONTRACTOR SHALL BLANK OFF AND INSULATE ALL UNUSED LOUVER AREA.
- 19. PITCH AIR INTAKE PLENUMS AND PROVIDE DRAIN TO NEAREST FLOOR DRAIN.
- 20. ALL REGISTERS, GRILLES AND DIFFUSERS LOCATED IN WALLS NEAR FLOOR SHALL BE HEAVY-DUTY TYPE DESIGNED TO WITHSTAND RUGGED IMPACT. REFER TO SCHEDULE. THE SECTION OF DUCTWORK BEHIND THE AIR DEVICE SHALL BE PAINTED FLAT BLACK.
- 21. EXACT LOCATION OF THERMOSTAT TO BE COORDINATED WITH FINAL LOCATION OF WALL MOUNTED ARCHITECTURAL AND ELECTRICAL EQUIPMENT.
- 22. PROVIDE FLEXIBLE CONNECTOR ON INTAKES AND DISCHARGES OF ALL AIR HANDLING UNITS.
- 23. ROOF OPENINGS SHALL BE SIZED FROM APPROVED SHOP DRAWINGS.
- 24. ALL DAMPER MOTORS SHALL BE 24 VOLT.


ABBREVIATIONS

- ACD AUTOMATIC CONTROL DAMPER
- AD ACCESS DOOR
- AFF ABOVE FINISHED FLOOR
- AHAP AS HIGH AS POSSIBLE
- AP ACCESS PANEL
- ARCH ARCHITECT
- ATC AUTOMATIC TEMPERATURE CONTROL
- BDD BACKDRAFT DAMPER
- BTU BRITISH THERMAL UNIT
- BTUH BRITISH THERMAL UNIT PER HOUR
- BOD BOTTOM OF DUCT
- CAP CAPACITY
- CD CEILING DIFFUSER
- CFM CUBIC FEET PER MINUTE
- CO CLEANOUT
- CONT CONTROLLER
- CP CUT AND CAP
- DIA DIAMETER
- DB DRY BULB TEMPERATURE
- DC DUST COLLECTOR
- DDC DIRECT DIGITAL CONTROL
- DN DOWN
- DWG DRAWING
- DX DIRECT EXPANSION COOLING
- EA EXHAUST AIR
- EAT ENTERING AIR TEMPERATURE
- EBB ELECTRIC BASEBOARD RADIATION
- ECH ELECTRIC CABINET HEATER
- ECON AIR-SIDE ECONOMIZER
- EF EXHAUST FAN
- EFF EFFICIENCY
- ELV ELEVATION
- ER EXHAUST REGISTER
- ESP EXTERNAL STATIC PRESSURE
- ETR EXISTING TO REMAIN
- EWT ENTERING WATER TEMPERATURE
- EXH EXHAUST
- FA FREE AREA
- FD FIRE DAMPER
- FLA FULL LOAD AMPS
- FOB FLAT ON BOTTOM
- FOT FLAT ON TOP
- FPI FINS PER INCH
- FFM FEET PER MINUTE
- FT FEET
- FTR FINNED TUBE RADIATION
- GAL GALLONS
- GALV GALVANIZED
- GC GENERAL CONTRACTOR
- GF GLYCOL FEED
- GPM GALLONS PER MINUTE
- HP HORSEPOWER
- HVAC HEATING, VENTILATING AND AIR CONDITIONING
- HGRH HOT GAS REHEAT
- HW HOT WATER
- HZ HERTZ
- IN INCHES
- KE KITCHEN EXHAUST
- KW KILOWATTS
- LAT LEAVING AIR TEMPERATURE
- LD LINEAR DIFFUSER
- LF LINEAR FEET
- LWT LEAVING WATER TEMPERATURE
- MCC MOTOR CONTROL CENTER
- NC NORMALLY CLOSED
- NIC NOT IN CONTRACT
- NO NORMALLY OPEN
- NTS NOT TO SCALE
- OA OUTSIDE AIR
- OAT OUTSIDE AIR TEMPERATURE
- OBD OPPOSED BLADE DAMPER
- OD OUTSIDE DIAMETER
- OED OPEN ENDED DUCT
- POS PROVIDED UNDER OTHER SECTIONS
- PSI POUNDS PER SQUARE INCH (GAUGE)
- PD PRESSURE DROP
- PRV PRESSURE REDUCING VALVE
- PG PROPYLENE GLYCOL
- R RETURN
- RA RETURN AIR
- RB REBALANCE
- RF RETURN/EXHAUST FAN
- RG RETURN GRILLE
- RM ROOM
- RPM REVOLUTIONS PER MINUTE
- RR RETURN REGISTER
- S SUPPLY
- SA SUPPLY AIR
- SAT SUPPLY AIR TEMPERATURE
- SF SQUARE FEET, SUPPLY FAN
- SP STATIC PRESSURE
- SR SUPPLY REGISTER
- SS STAINLESS STEEL
- STL STEEL
- TYP TYPICAL
- UC UNDERCUT DOOR
- V VOLTS
- VAV VARIABLE AIR VOLUME
- VD VOLUME DAMPER
- VFD VARIABLE FREQUENCY DRIVE
- W/ WITH
- W/O WITHOUT
- WB WET BULB TEMPERATURE
- WG WATER GAUGE
- WMS WIRE MESH SCREEN


PIPING LEGEND




DUCTWORK LEGEND/SYMBOLS

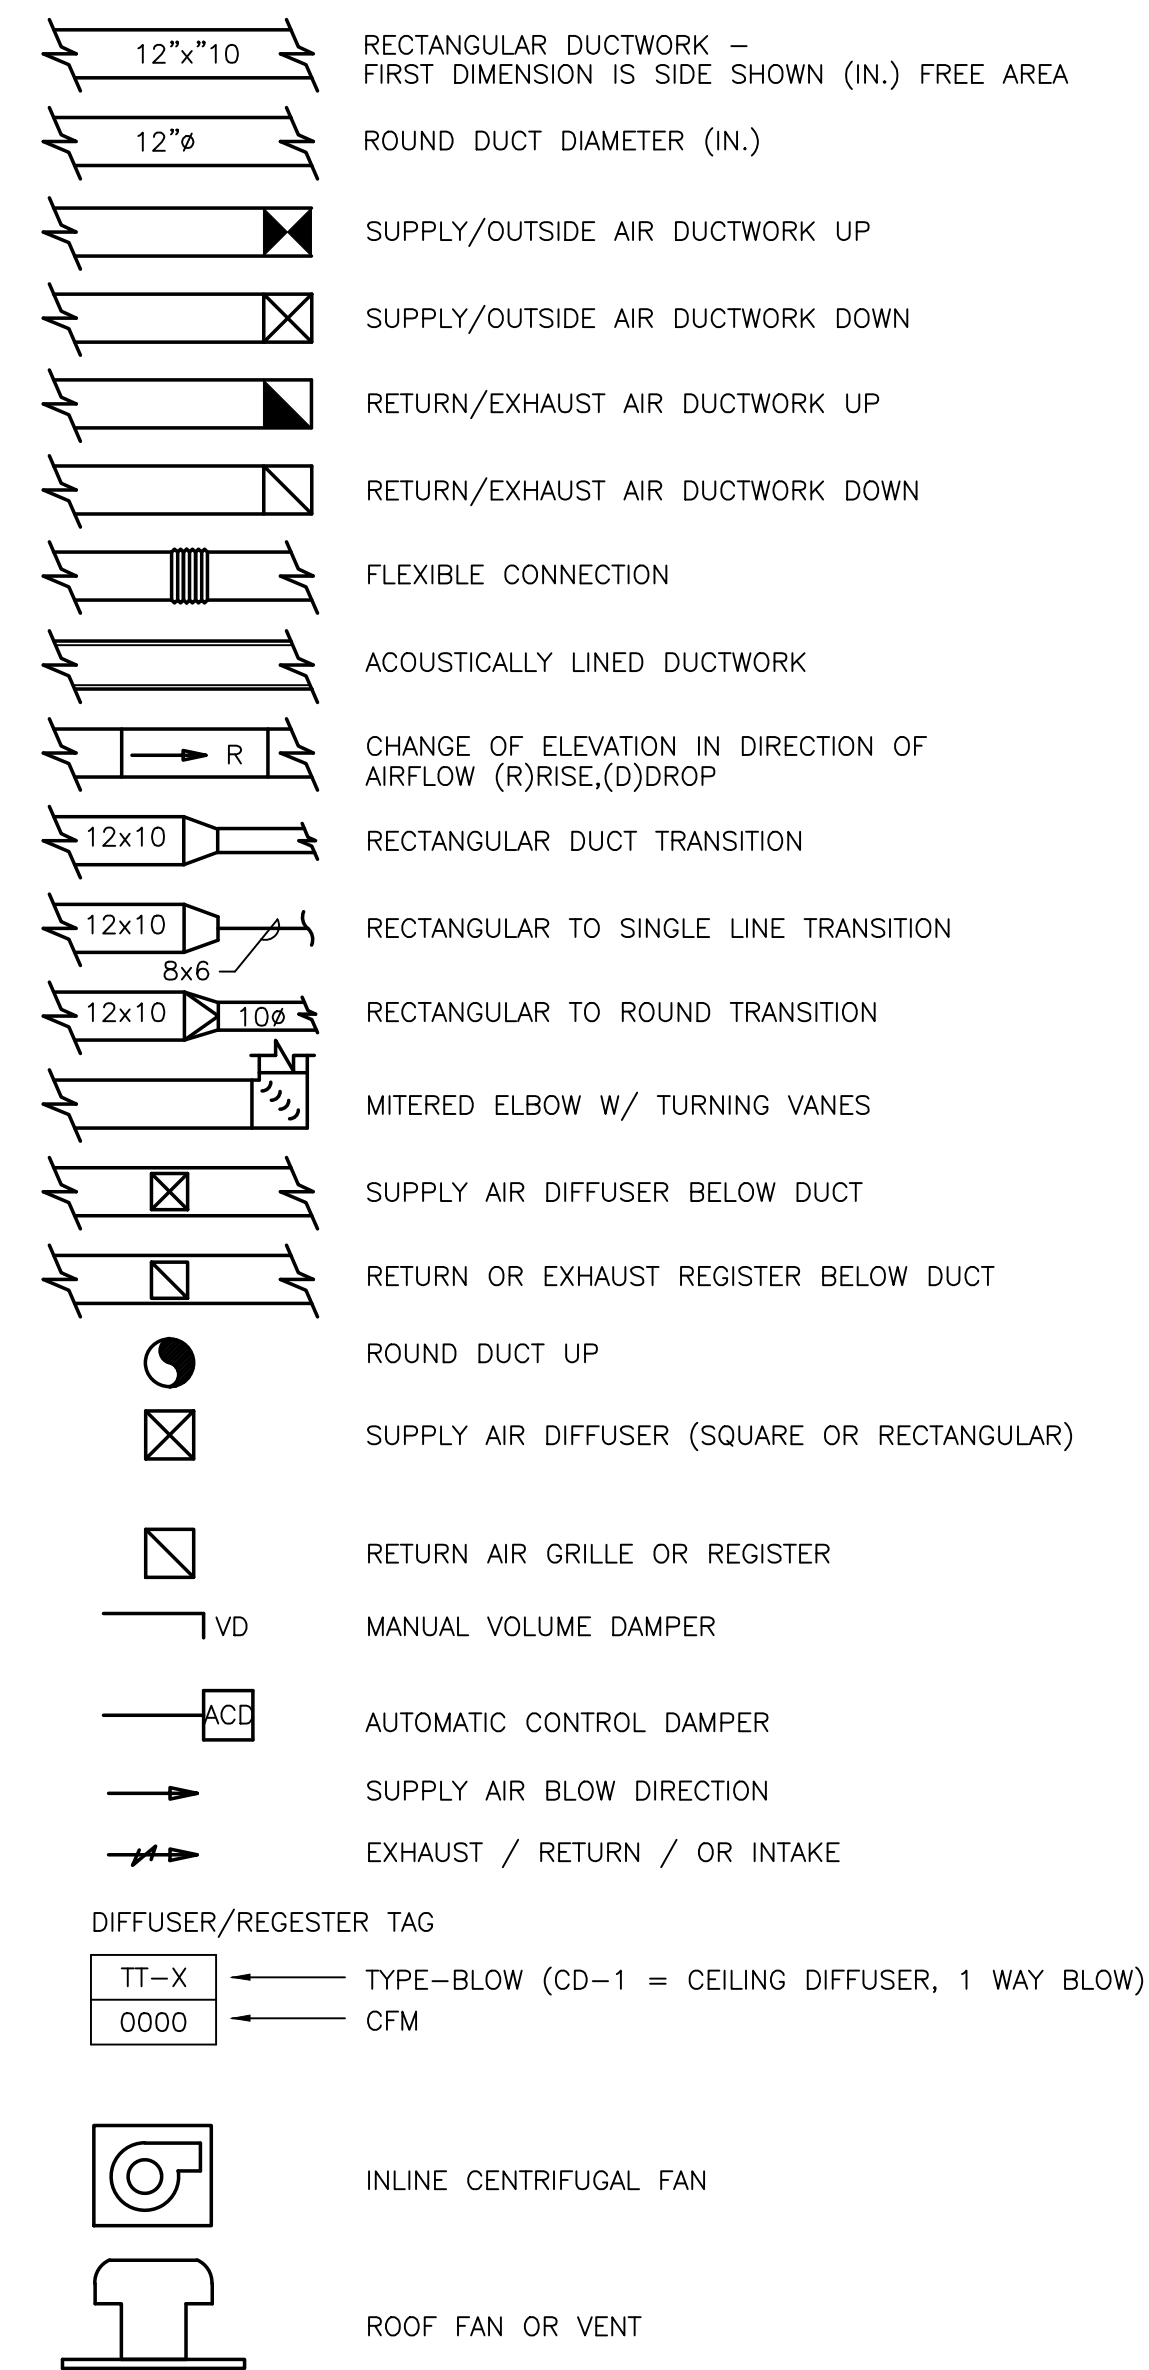

EQUIPMENT TAG SYMBOLS & ABBREVIATIONS

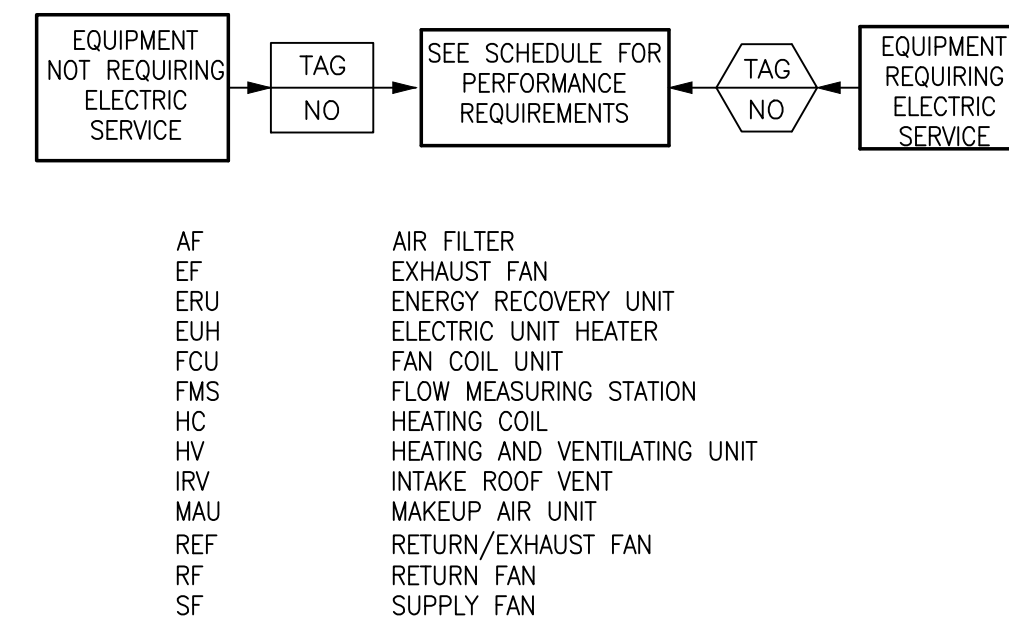


INSTRUMENTATION

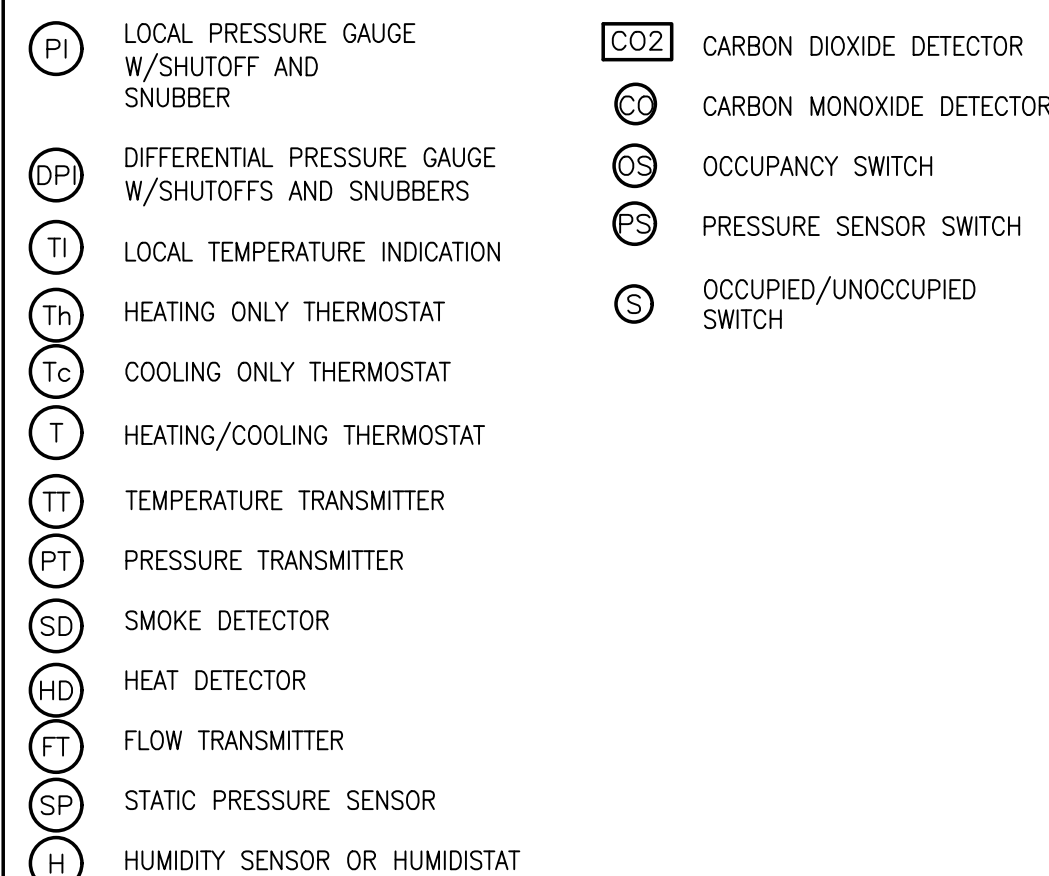

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PROJECT

BURRILLVILLE WWTF HEADWORKS & OAKLAND PUMP STATION IMPROVEMENTS

BURRILLVILLE, RI

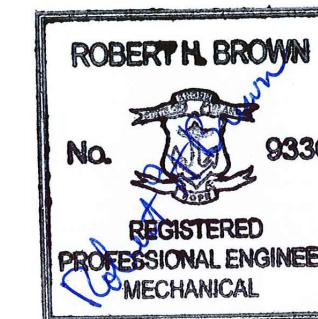TITLE

Hvac Legend and Notes

Table with 3 columns: NO., REVISIONS, DATE

Table with 2 columns: DRAWN BY, DESIGNED BY, CHECKED BY, ISSUE DATE, BETA JOB NO.

SCALE

NONE

UNLESS OTHERWISE NOTED OR CHANGED BY REPRODUCTION

SHEET NO.

H-0.1



EXHAUST FAN SCHEDULE

TAG NO.	LOCATION	CFM	ESP (IN WC)	SPEED (RPM)			ELECTRICAL DATA				MANUFACTURER & MODEL #	REMARKS
				FAN	MOTOR	DRIVE	HP	V	PH	HZ		
EF-1	ROOF	3,800	3.0	1636	1800	BELT	5	480	3	60	MK PLASTICS CNW 315	①②

① VFD RATED MOTOR ② FRP CONSTRUCTION



ELECTRIC UNIT HEATER SCHEDULE

TAG NO.	BUILDING	CAPACITY	FAN DATA				MANUFACTURER MODEL NUMBER	REMARKS
			KW	CFM	V	PH		
EUH-1	HEADWORKS BUILDING	5	400	480	3	60	QMARK GUX5004832-D	EXPLOSION PROOF, WITH DISCONNECT

DIFFUSER, REGISTER & GRILLE SCHEDULE

TAG NO.	MODULE SIZE (IN)	ROUND ADAPTER SIZE (IN)	FLEX DUCT SIZE (IN)	SQUARE DUCT SIZE (IN)	SERVICE	CFM RANGE		MAX. NC LEVEL	MANUFACTURER & MODEL NO.	REMARKS
						MIN	MAX			
SR-1	-	-	-	N/A	SUPPLY	-	-	-	-	
ER-1	-	-	-	N/A	EXHAUST	-	-	-	-	

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PROJECT

**BURRILLVILLE WWTF
HEADWORKS &
OAKLAND PUMP
STATION
IMPROVEMENTS**

BURRILLVILLE, RI

TITLE

Hvac Schedules

NO.	REVISIONS	DATE

DRAWN BY: RLB

DESIGNED BY: RLB

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ISSUE DATE: MAY 2023

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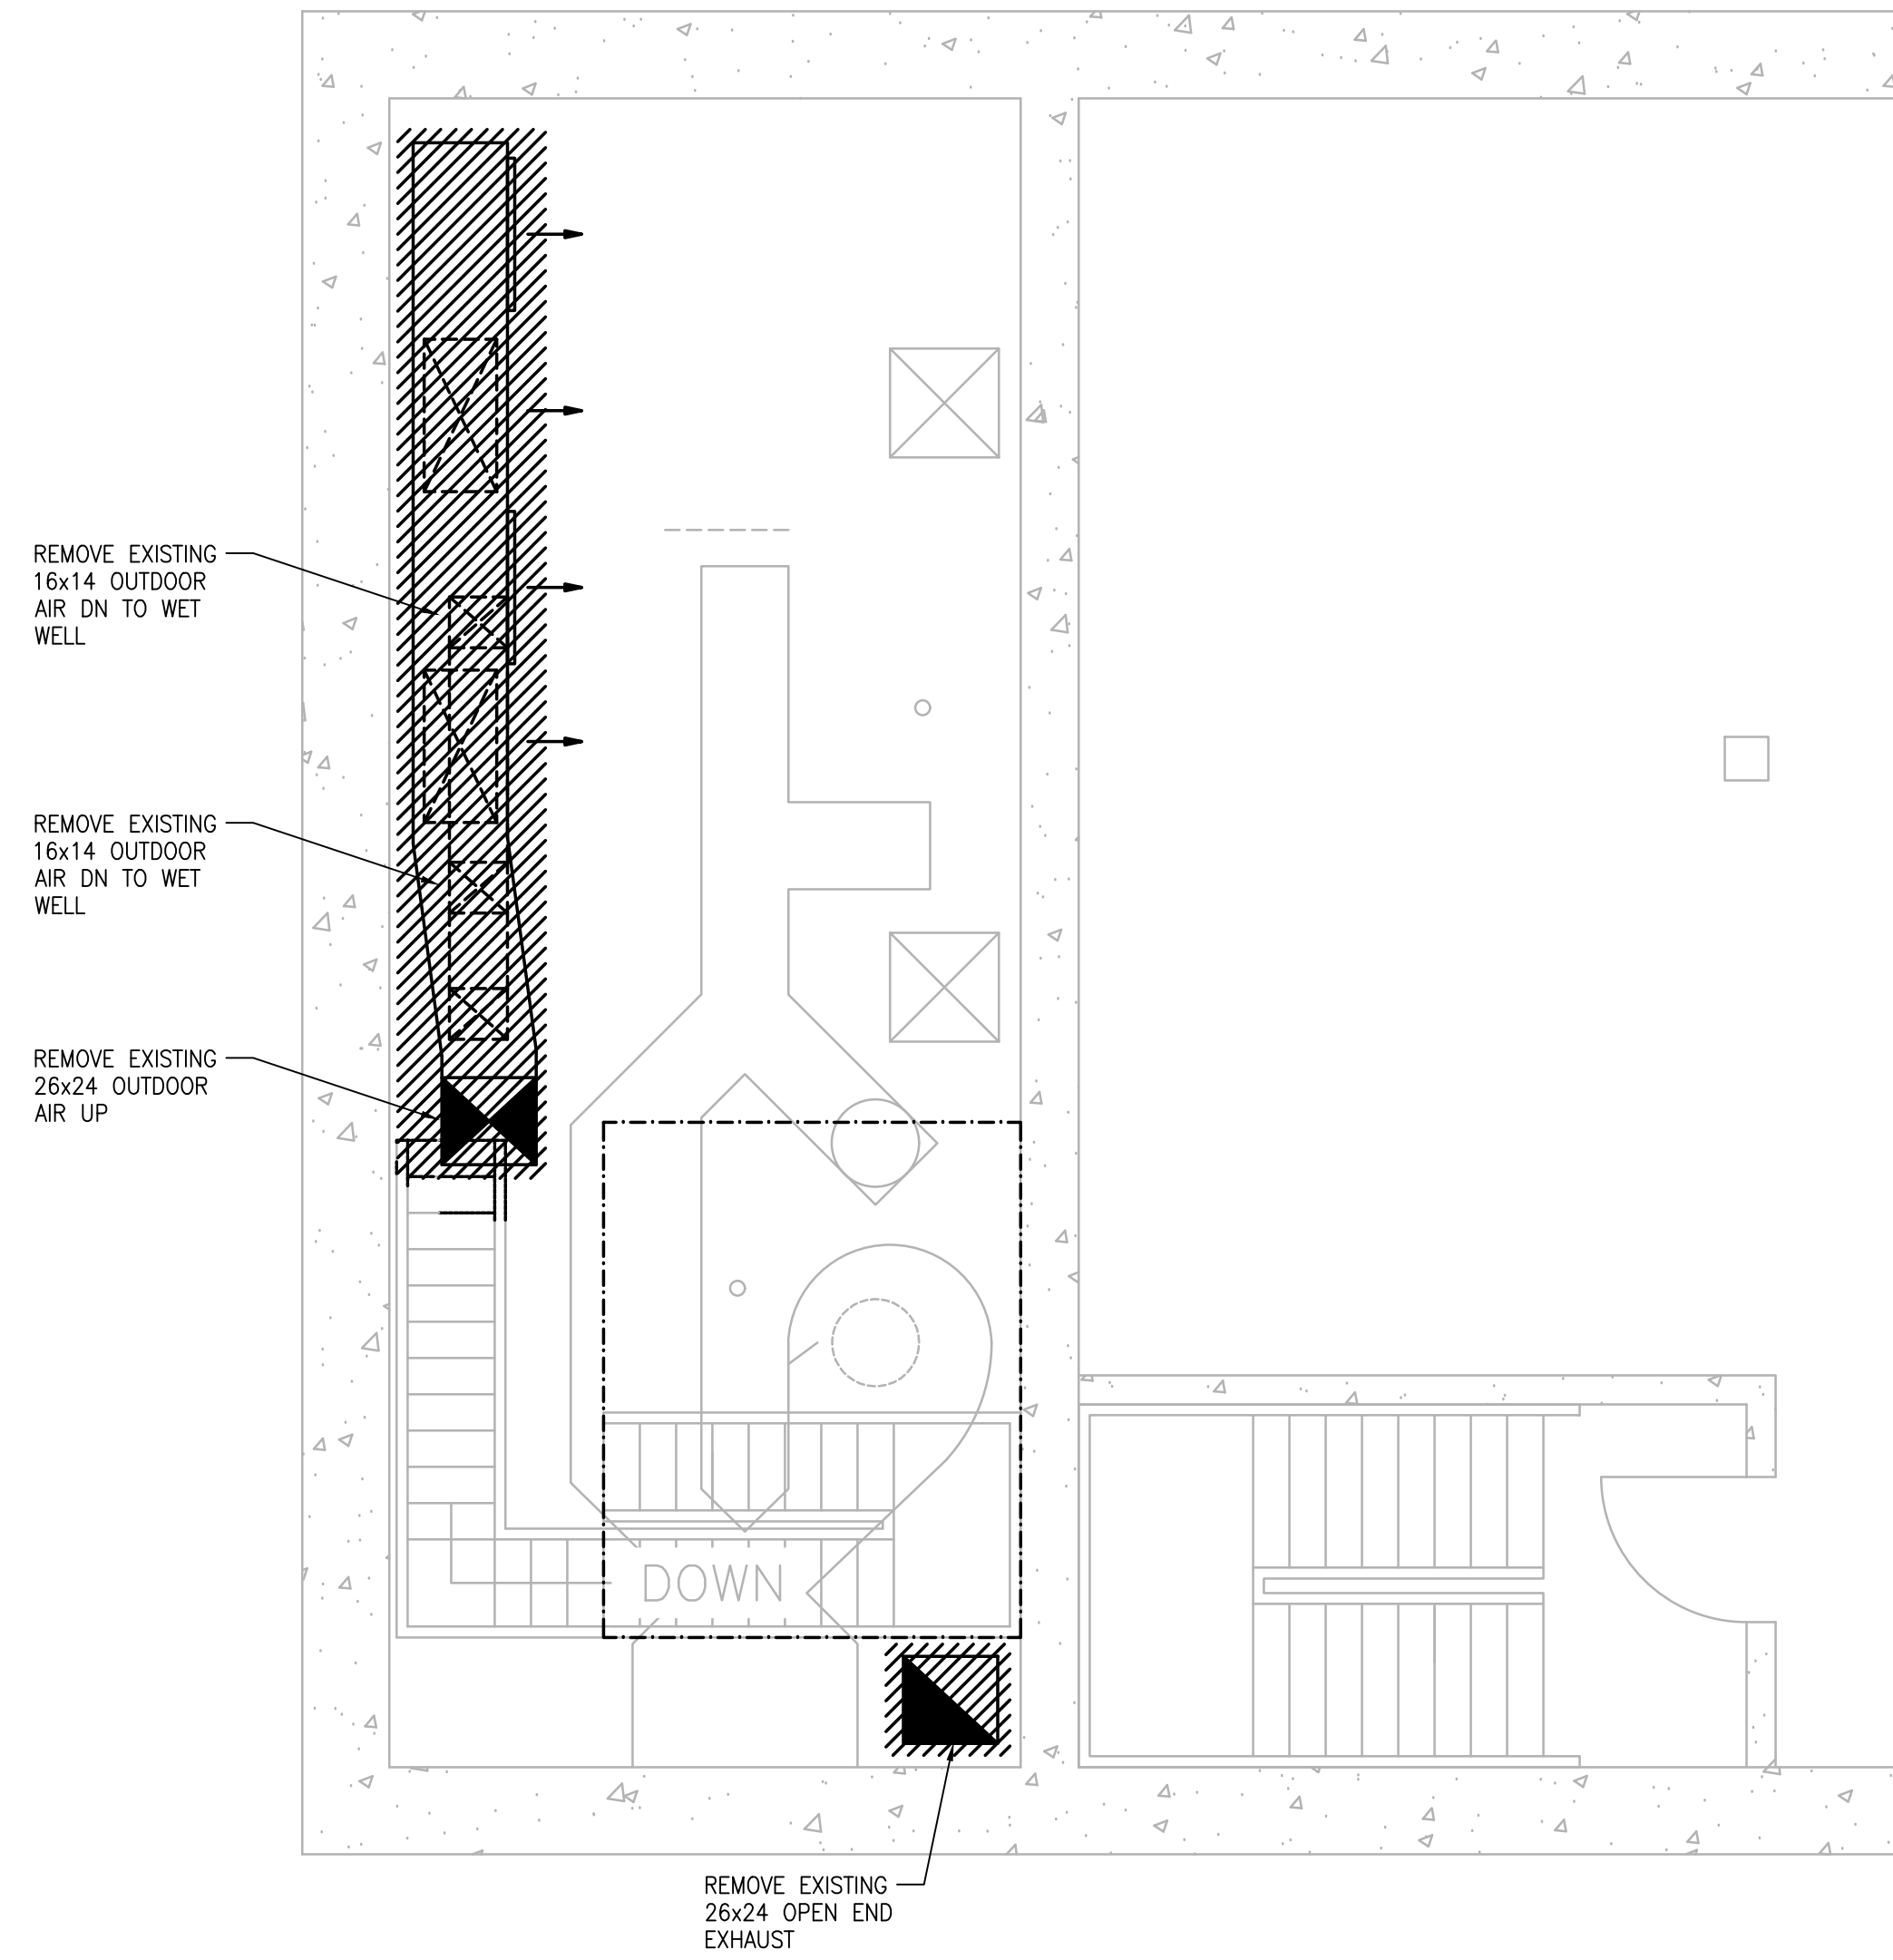
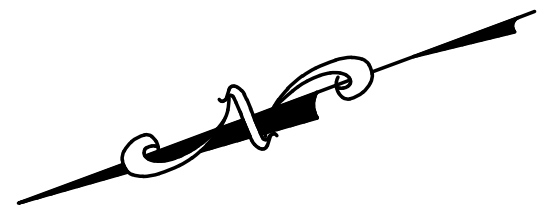
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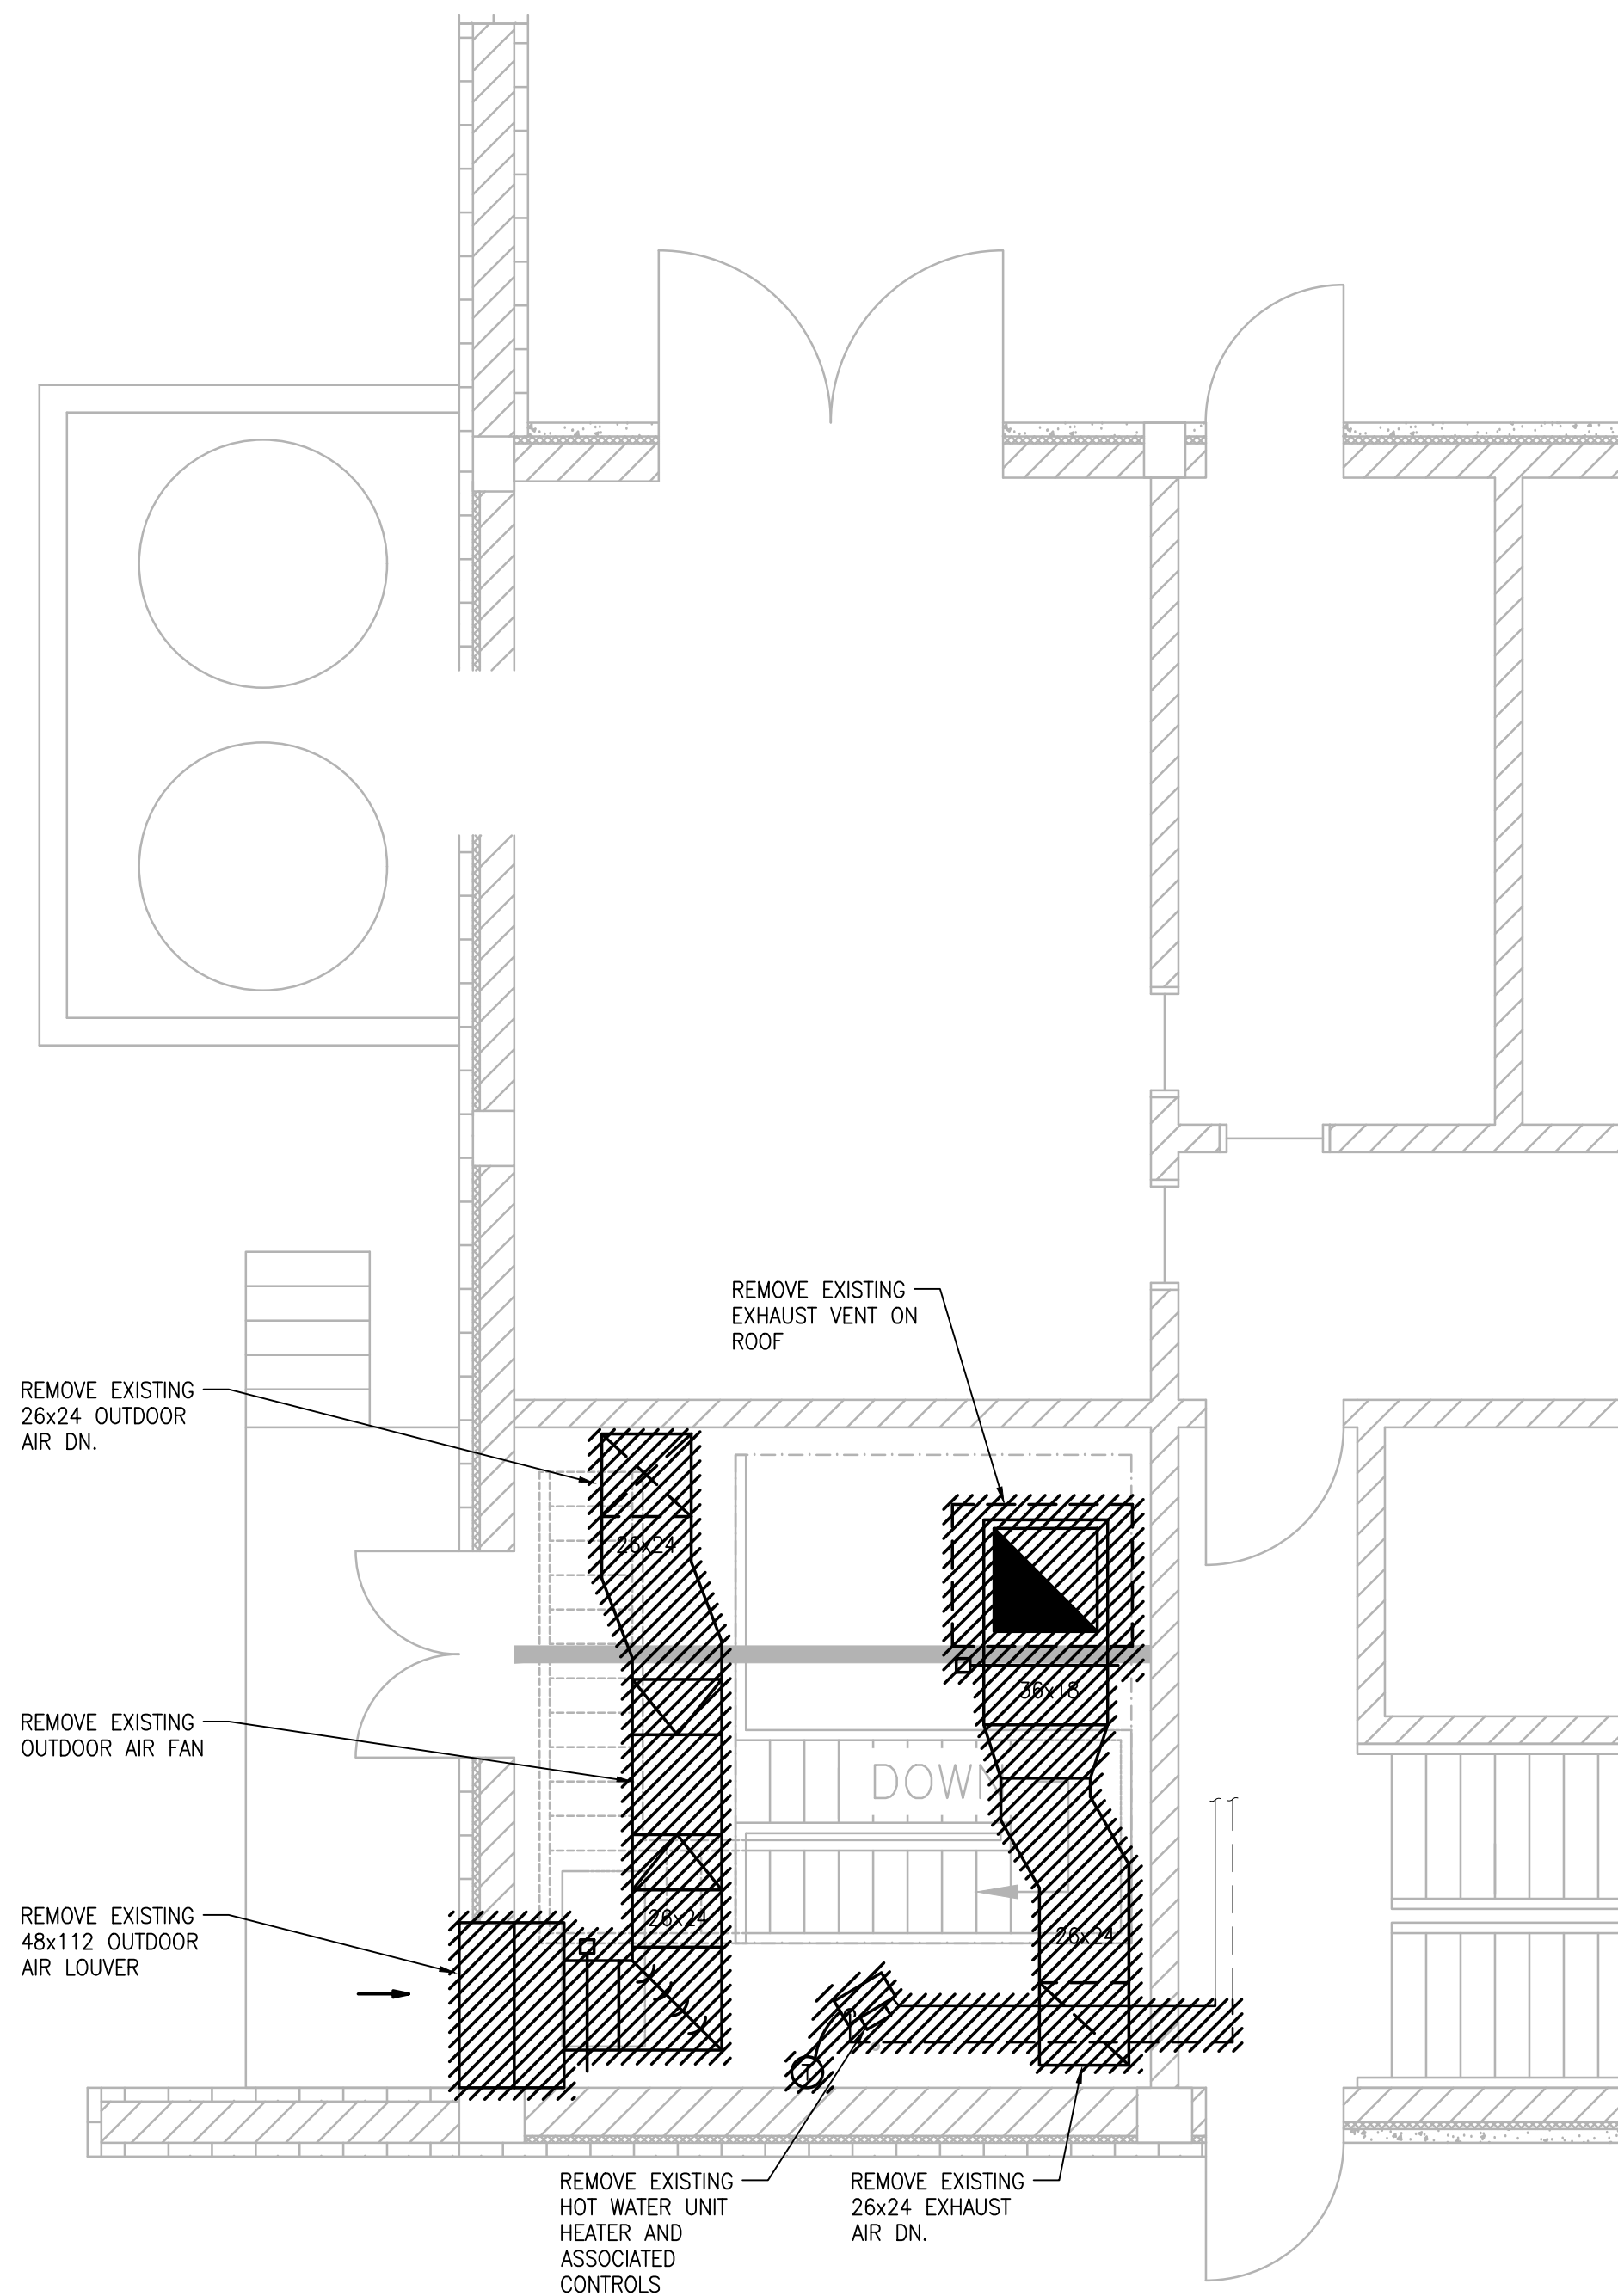
SHEET NO.

H-0.2



LOWER LEVEL DEMOLITION PLAN

SCALE: 1/4"=1'-0"



UPPER LEVEL DEMOLITION PLAN

SCALE: 1/4"=1'-0"

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PROJECT

**BURRILLVILLE WWTF
HEADWORKS &
OAKLAND PUMP
STATION
IMPROVEMENTS**

BURRILLVILLE, RI

TITLE

Headworks

Hvac
Demolition
Plans

NO.	REVISIONS	DATE

DRAWN BY: RLB

DESIGNED BY: RLB

CHECKED BY: RHB

ISSUE DATE: MAY 2023

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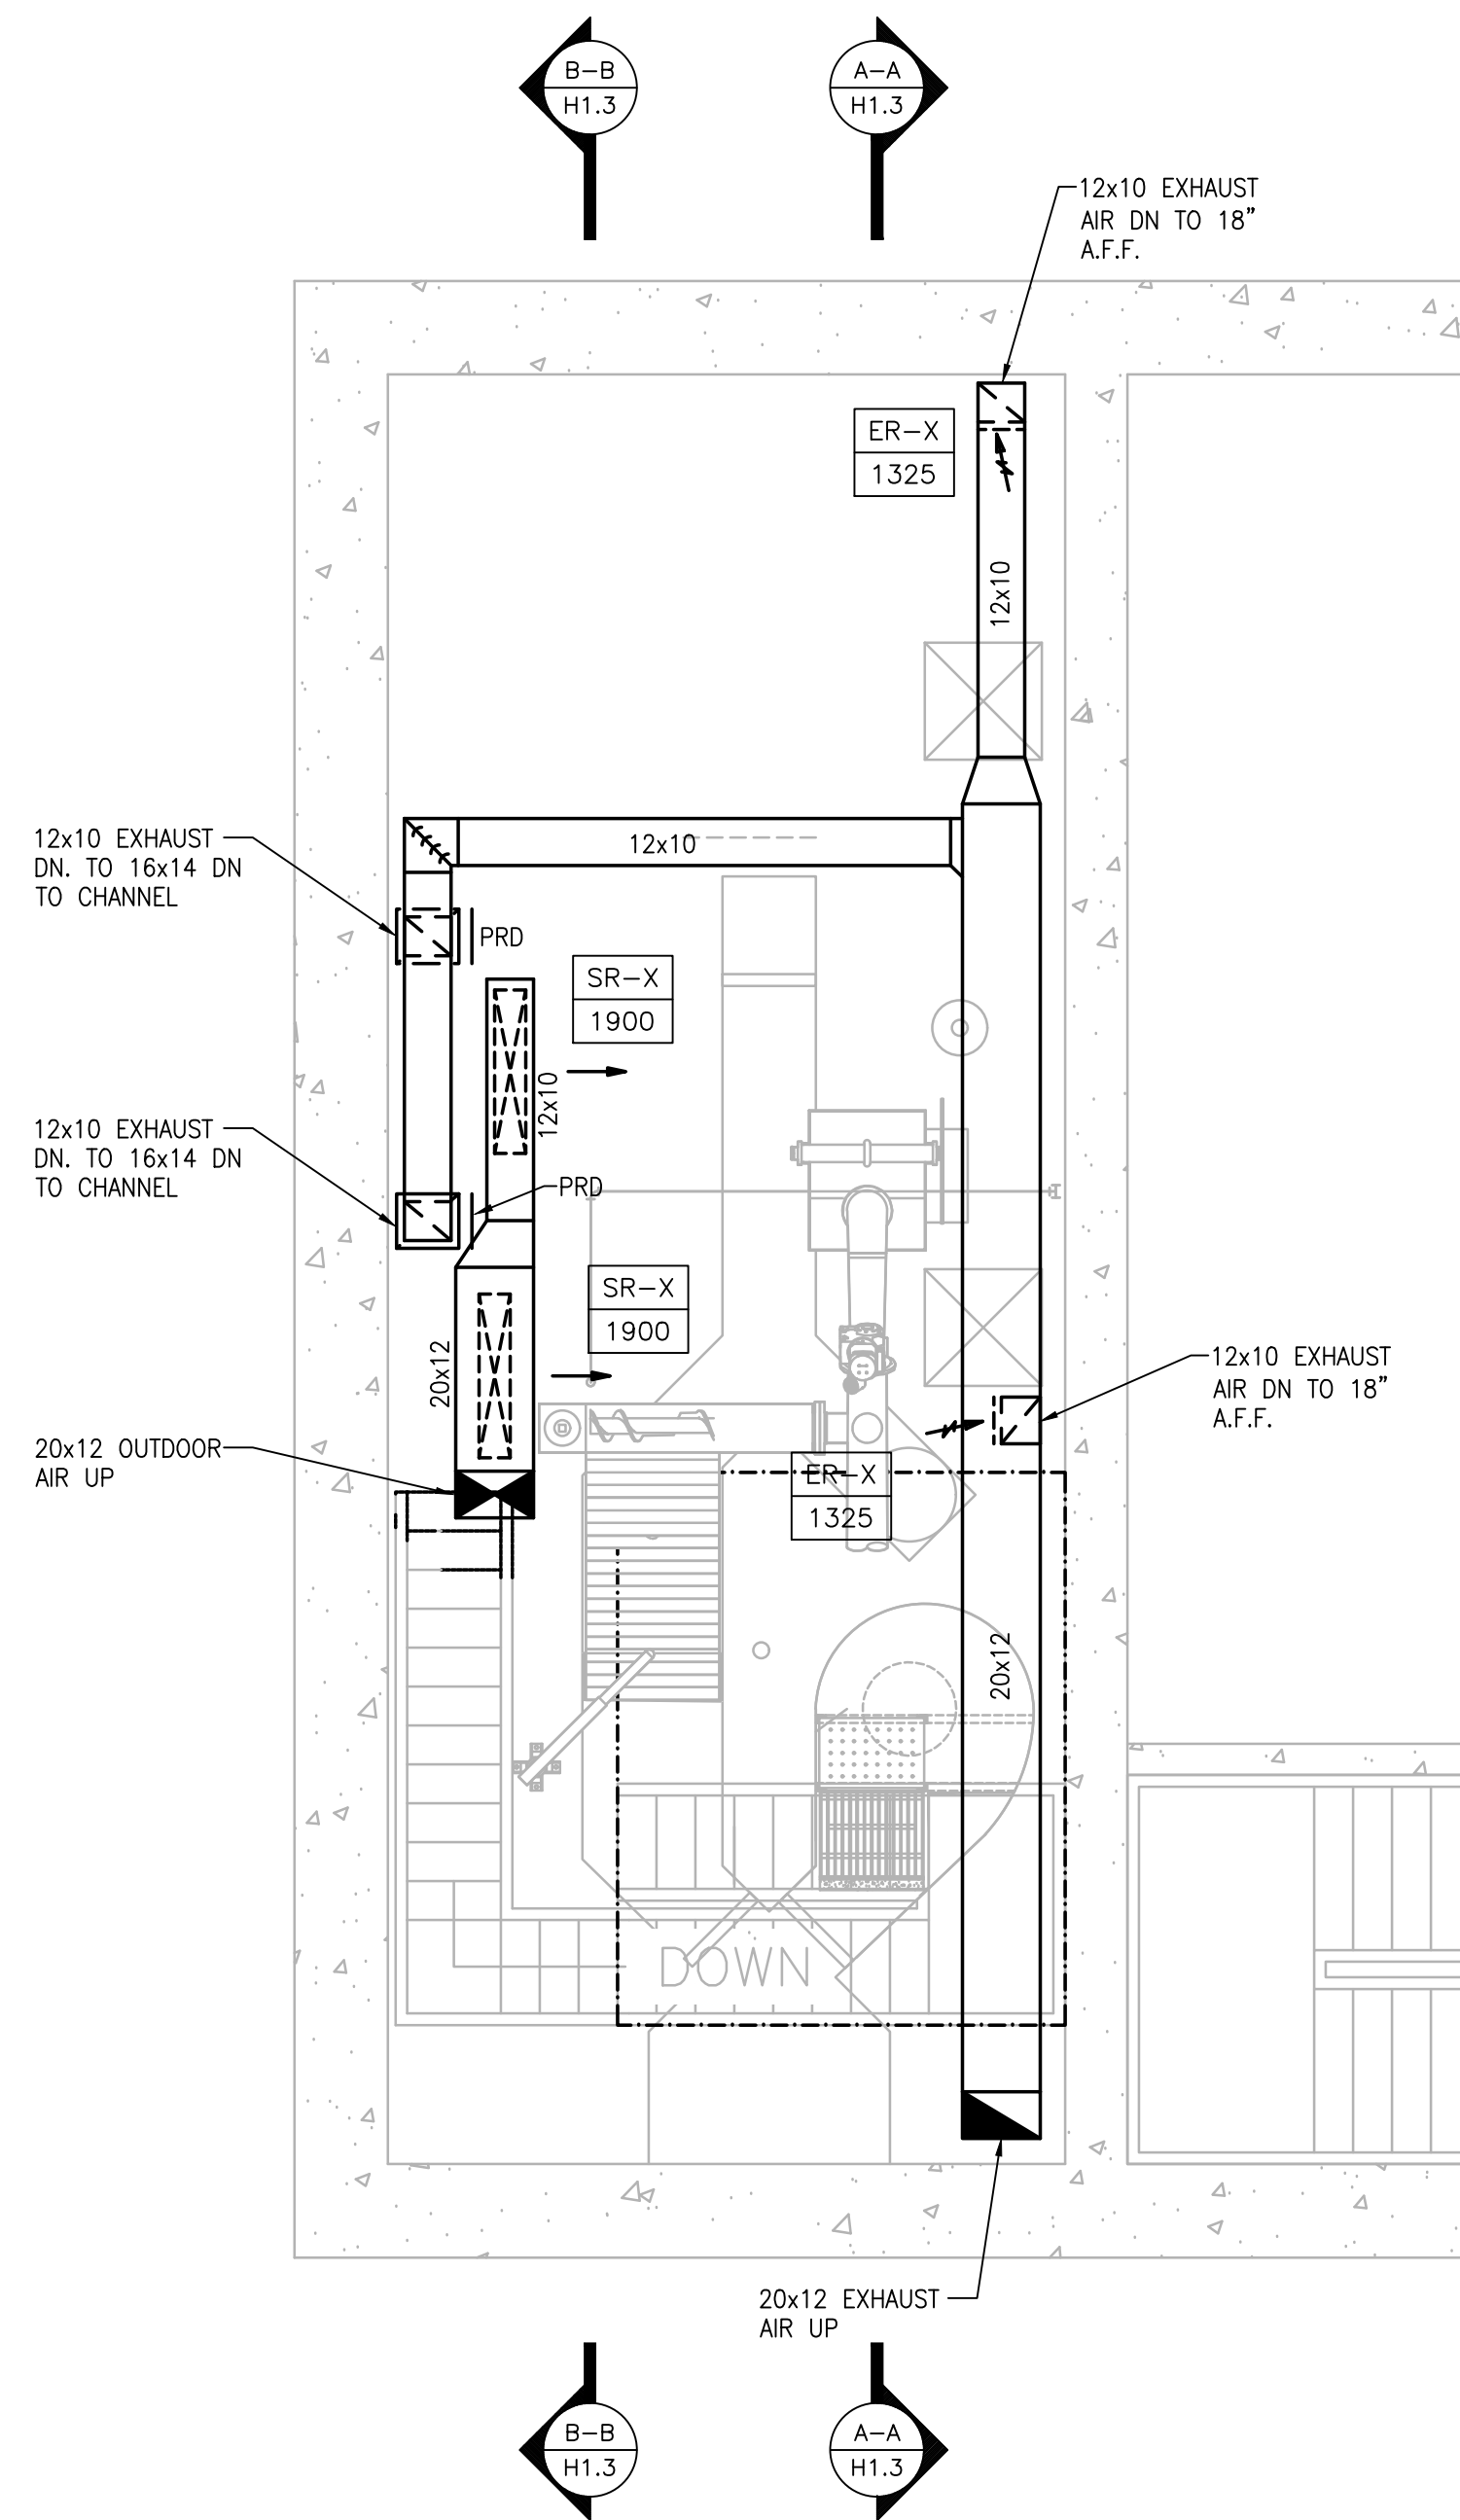
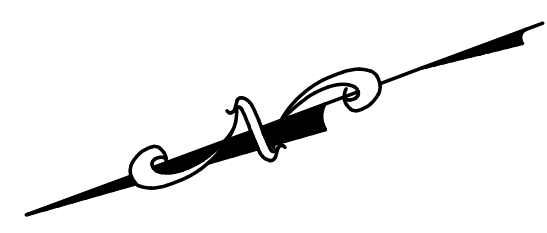
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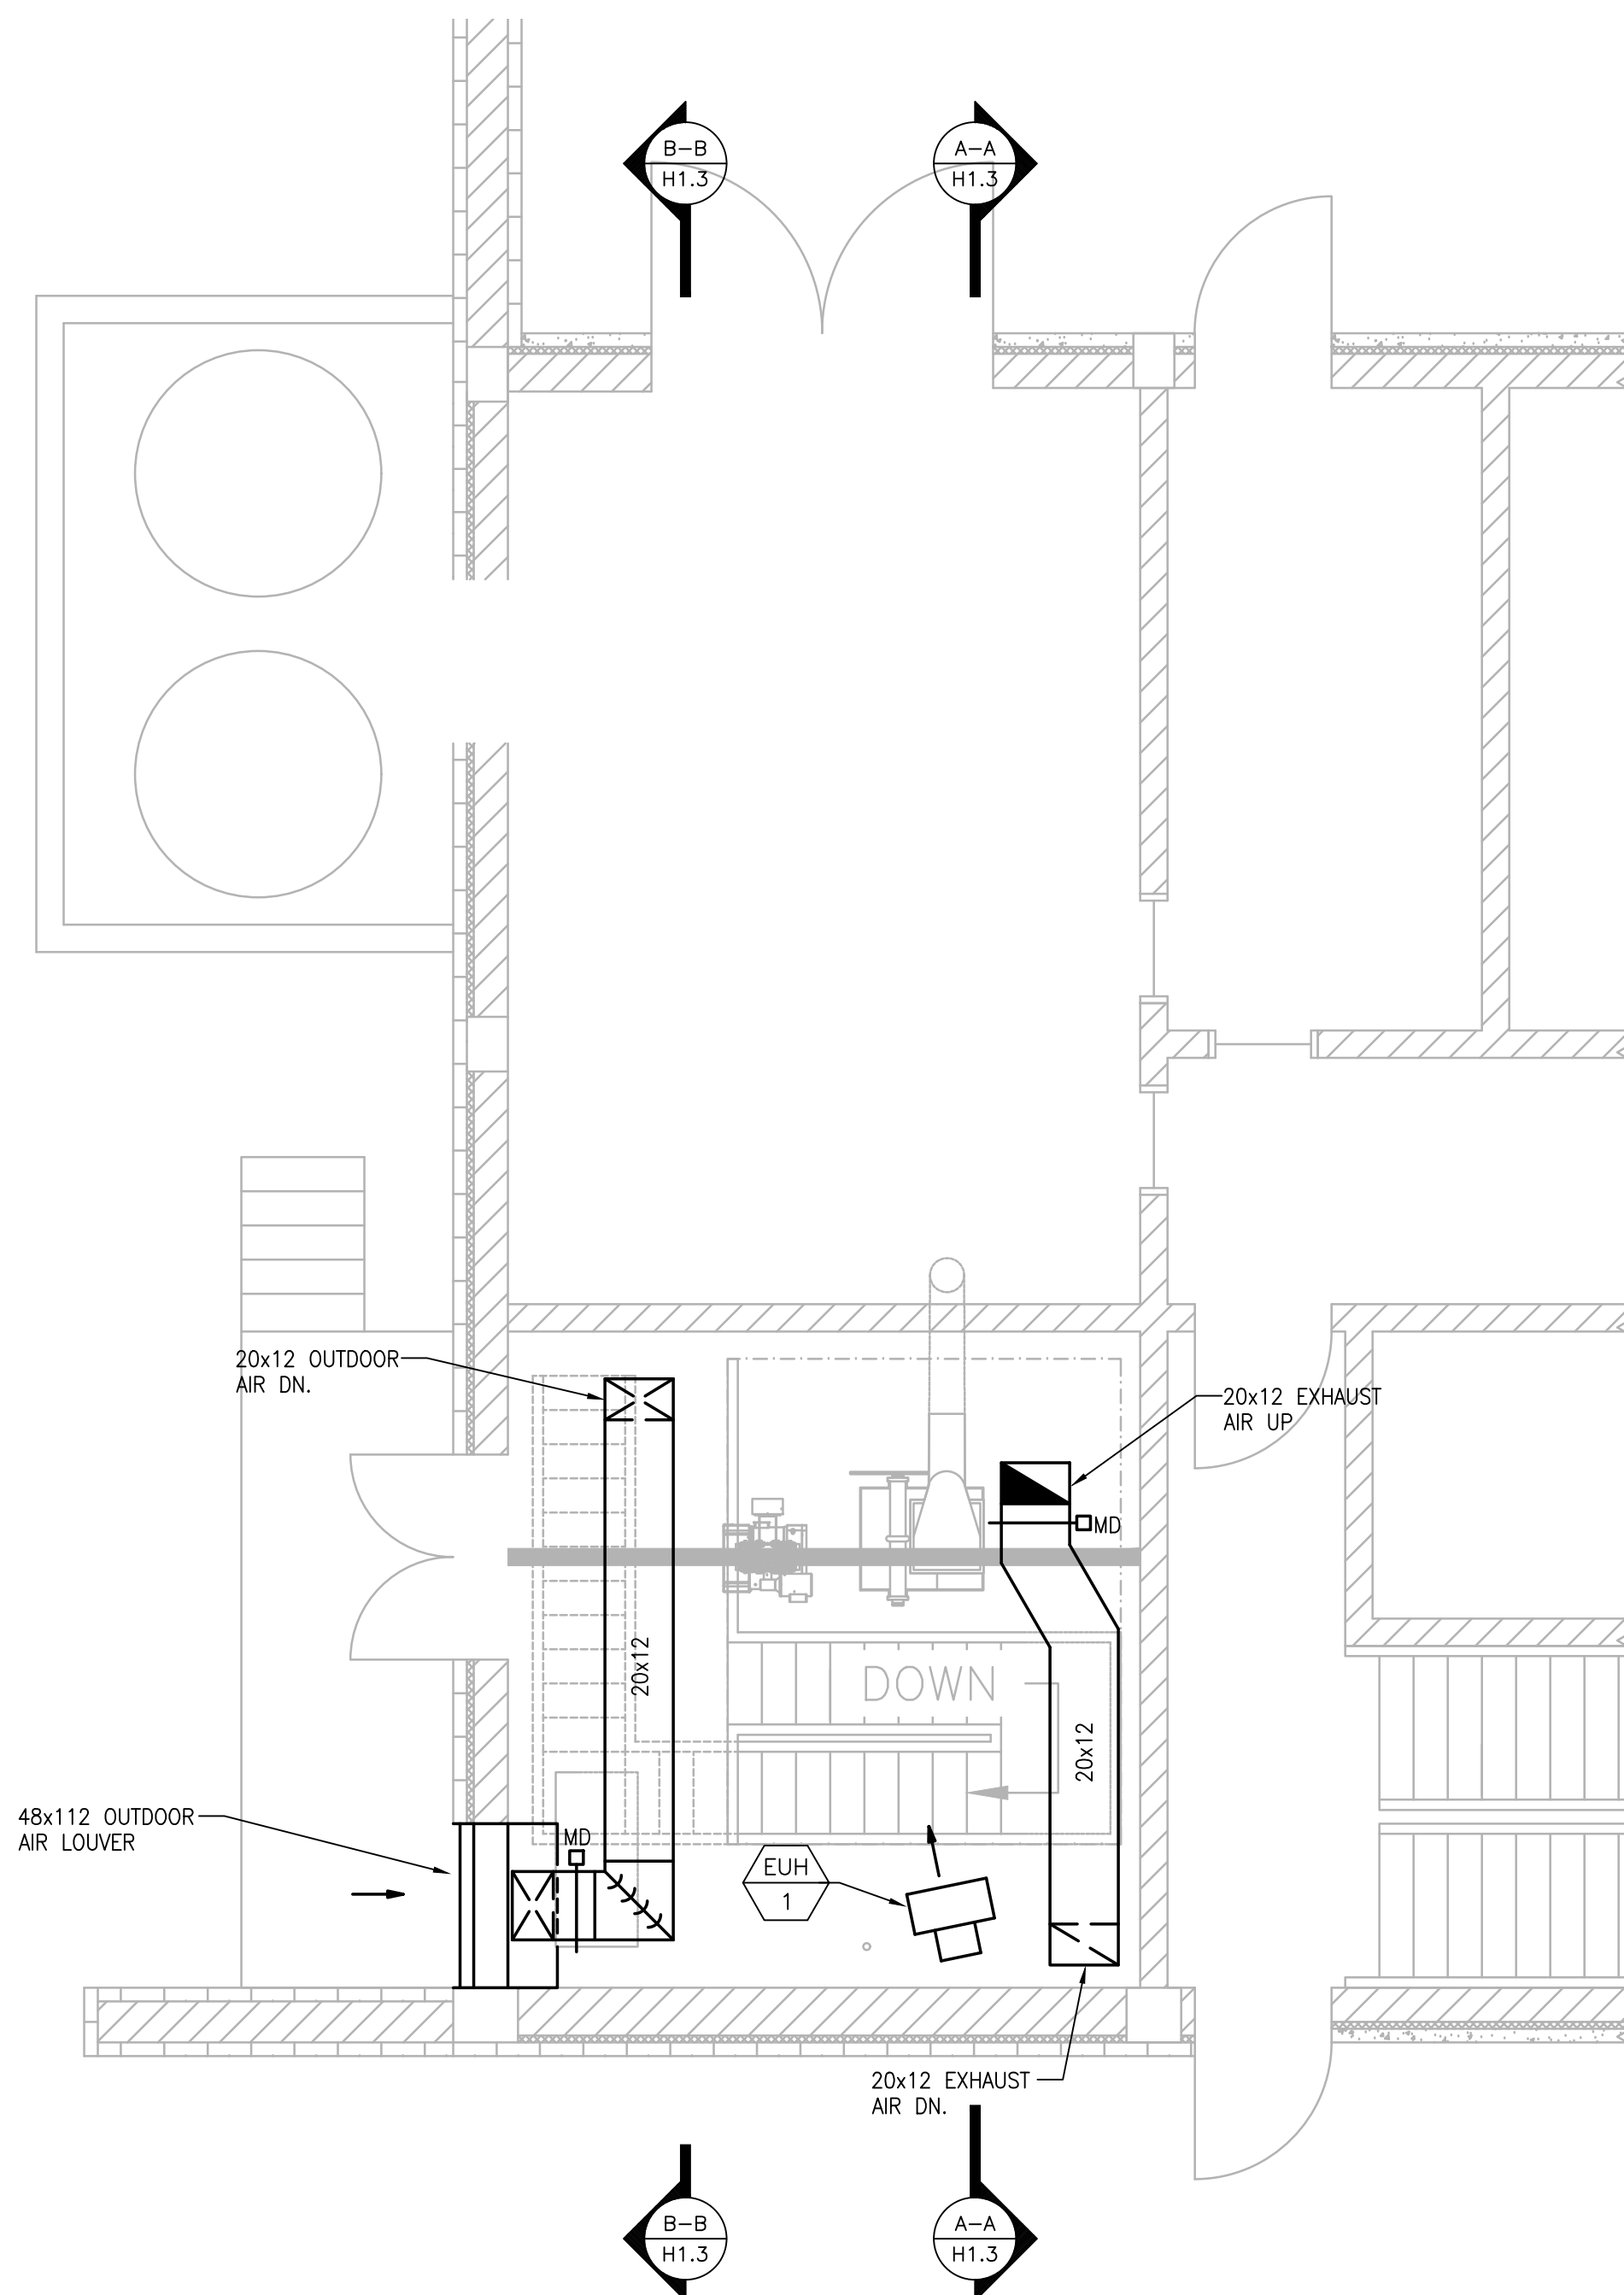
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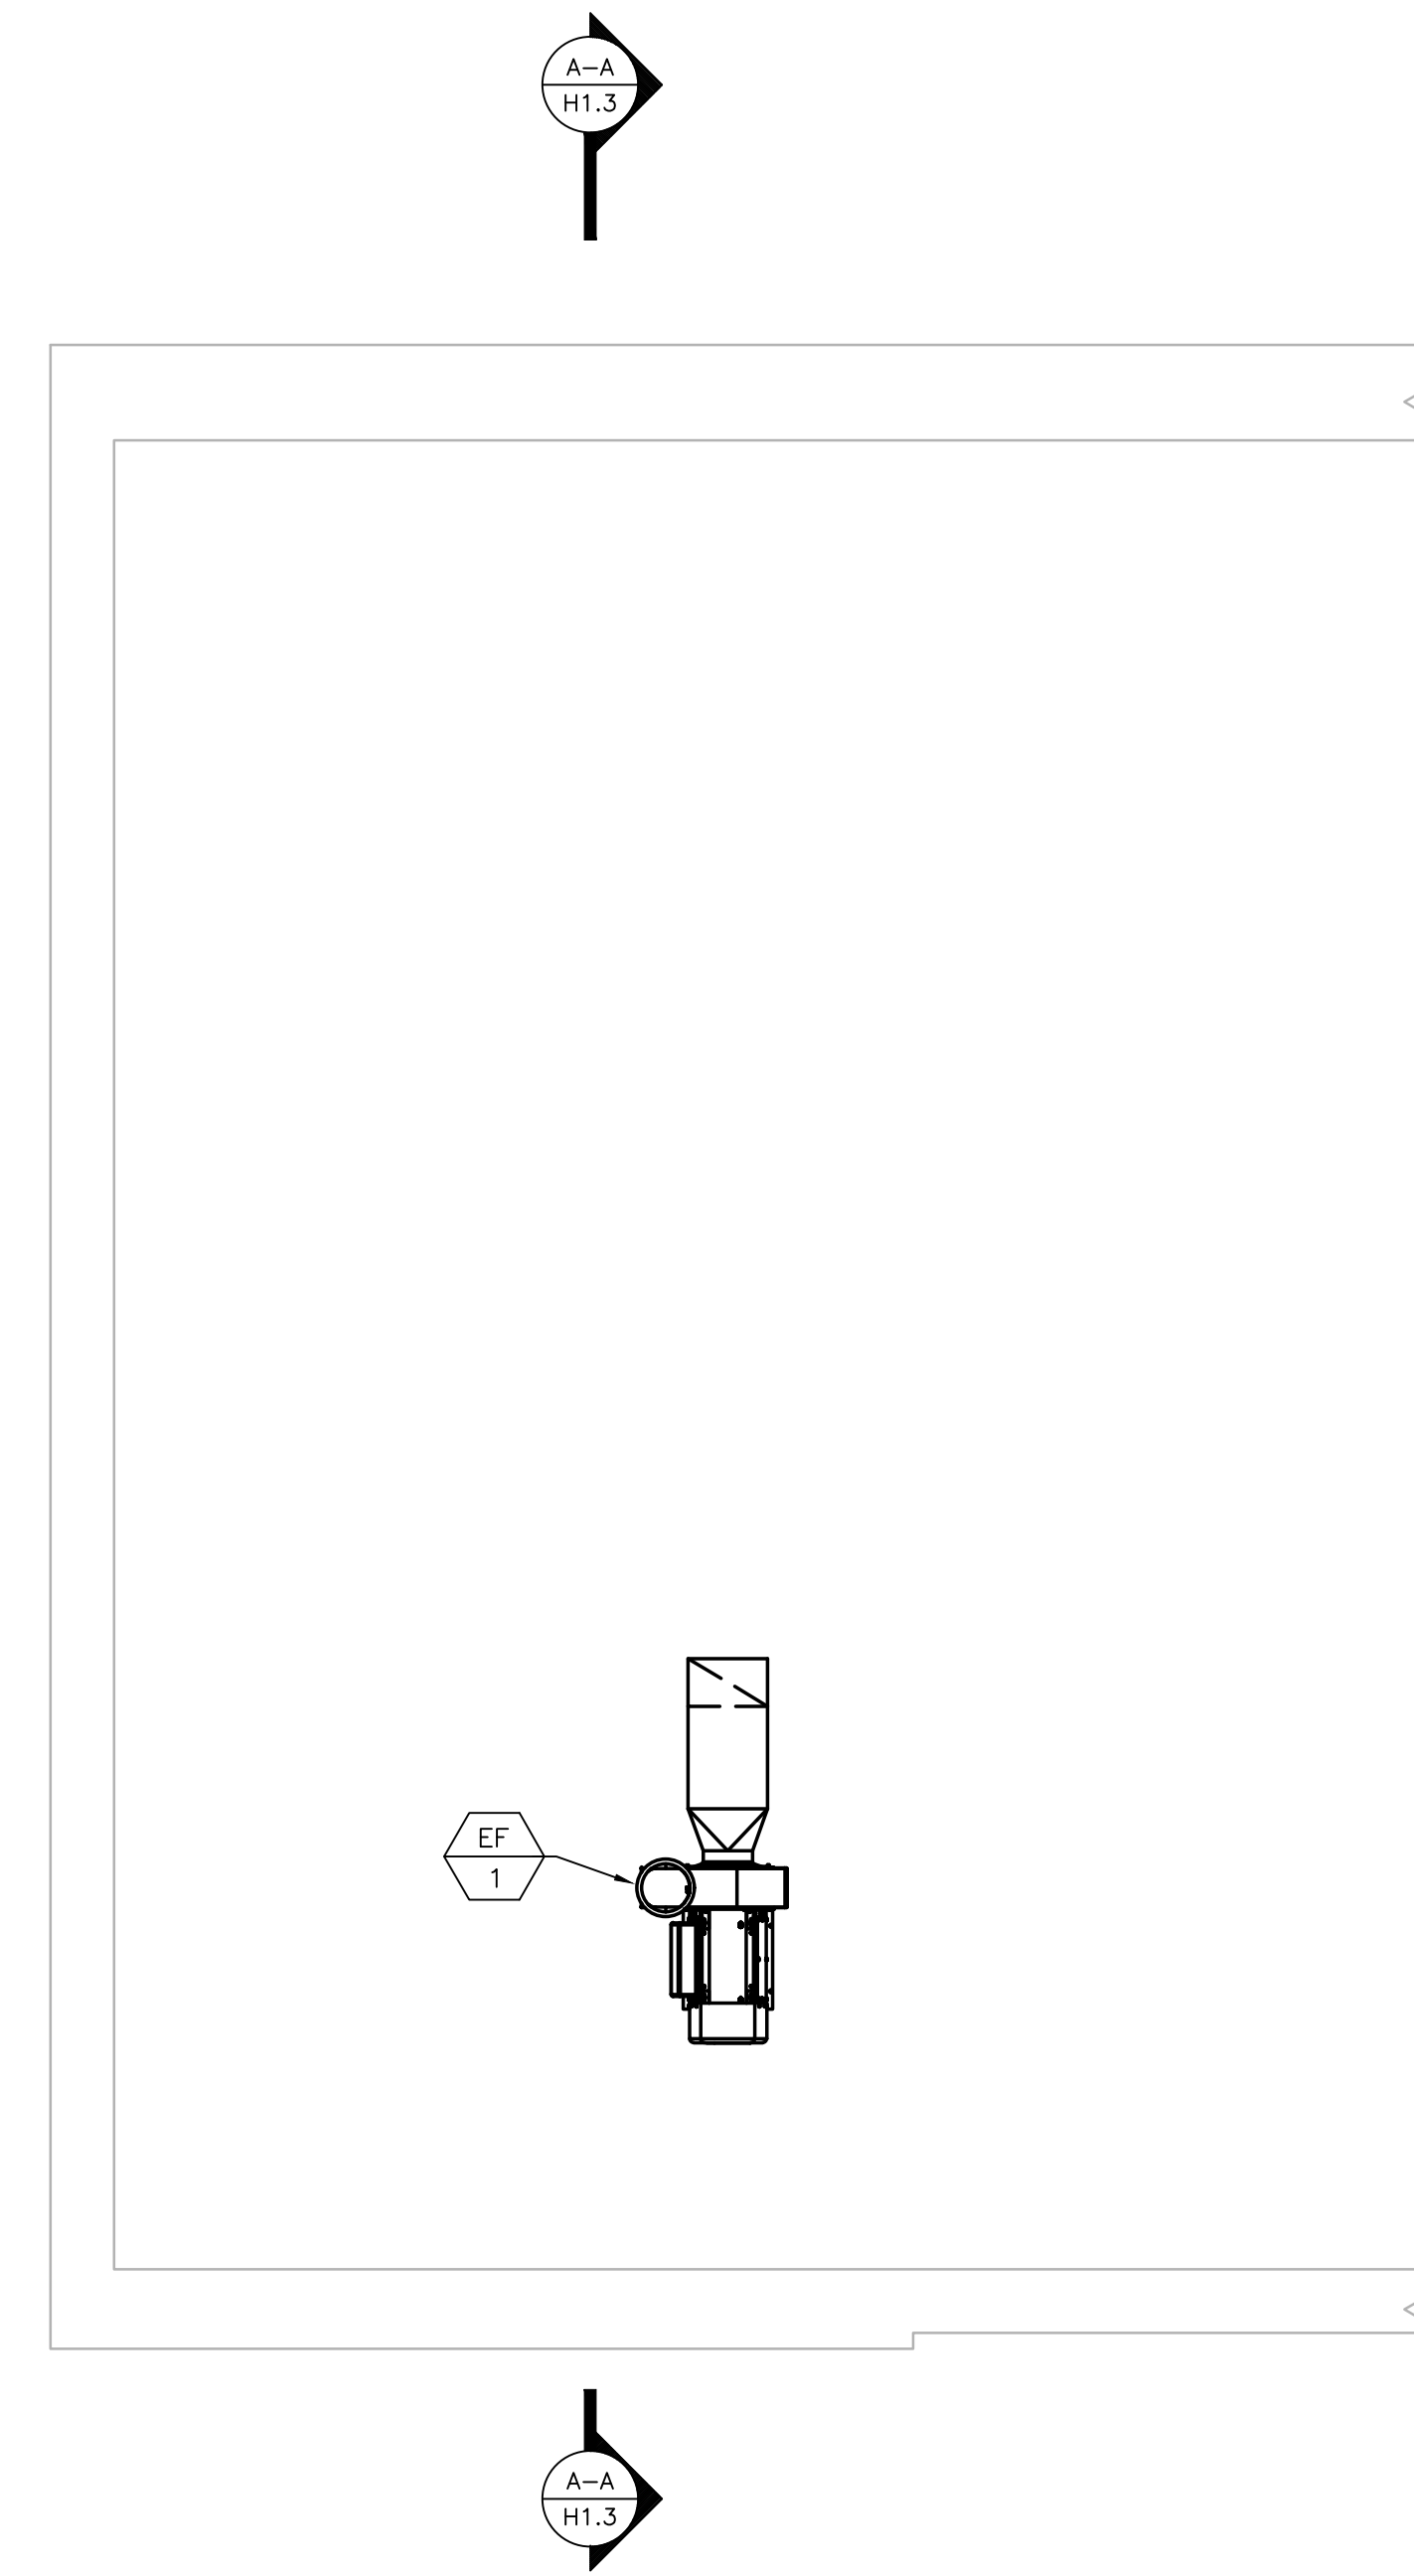
LOWER LEVEL NEW WORK PLAN

SCALE: 1/4"=1'-0"



UPPER LEVEL NEW WORK PLAN

SCALE: 1/4"=1'-0"




ROOF NEW WORK PLAN

SCALE: 1/4"=1'-0"

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PROJECT

**BURRILLVILLE WWTF
HEADWORKS &
OAKLAND PUMP
STATION
IMPROVEMENTS**

BURRILLVILLE, RI

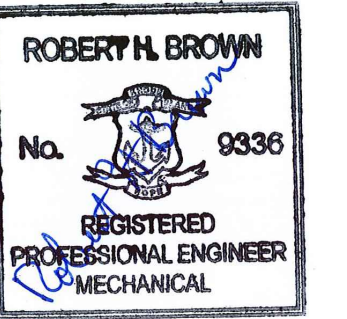
TITLE

Headworks

Hvac New
Work Plans



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BETA JOB NO.: 6861-105

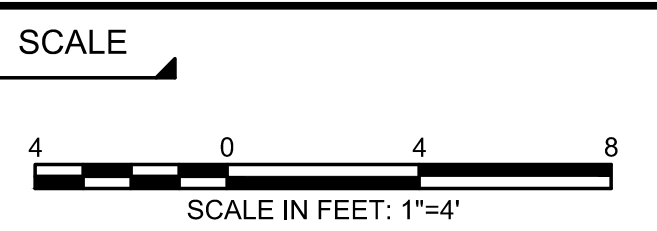


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SHEET NO. **H-1.2**



SECTION A-A
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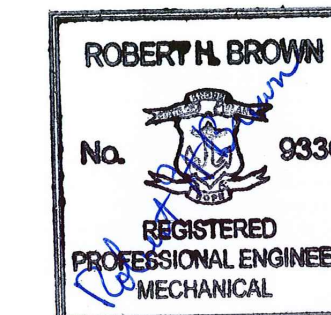


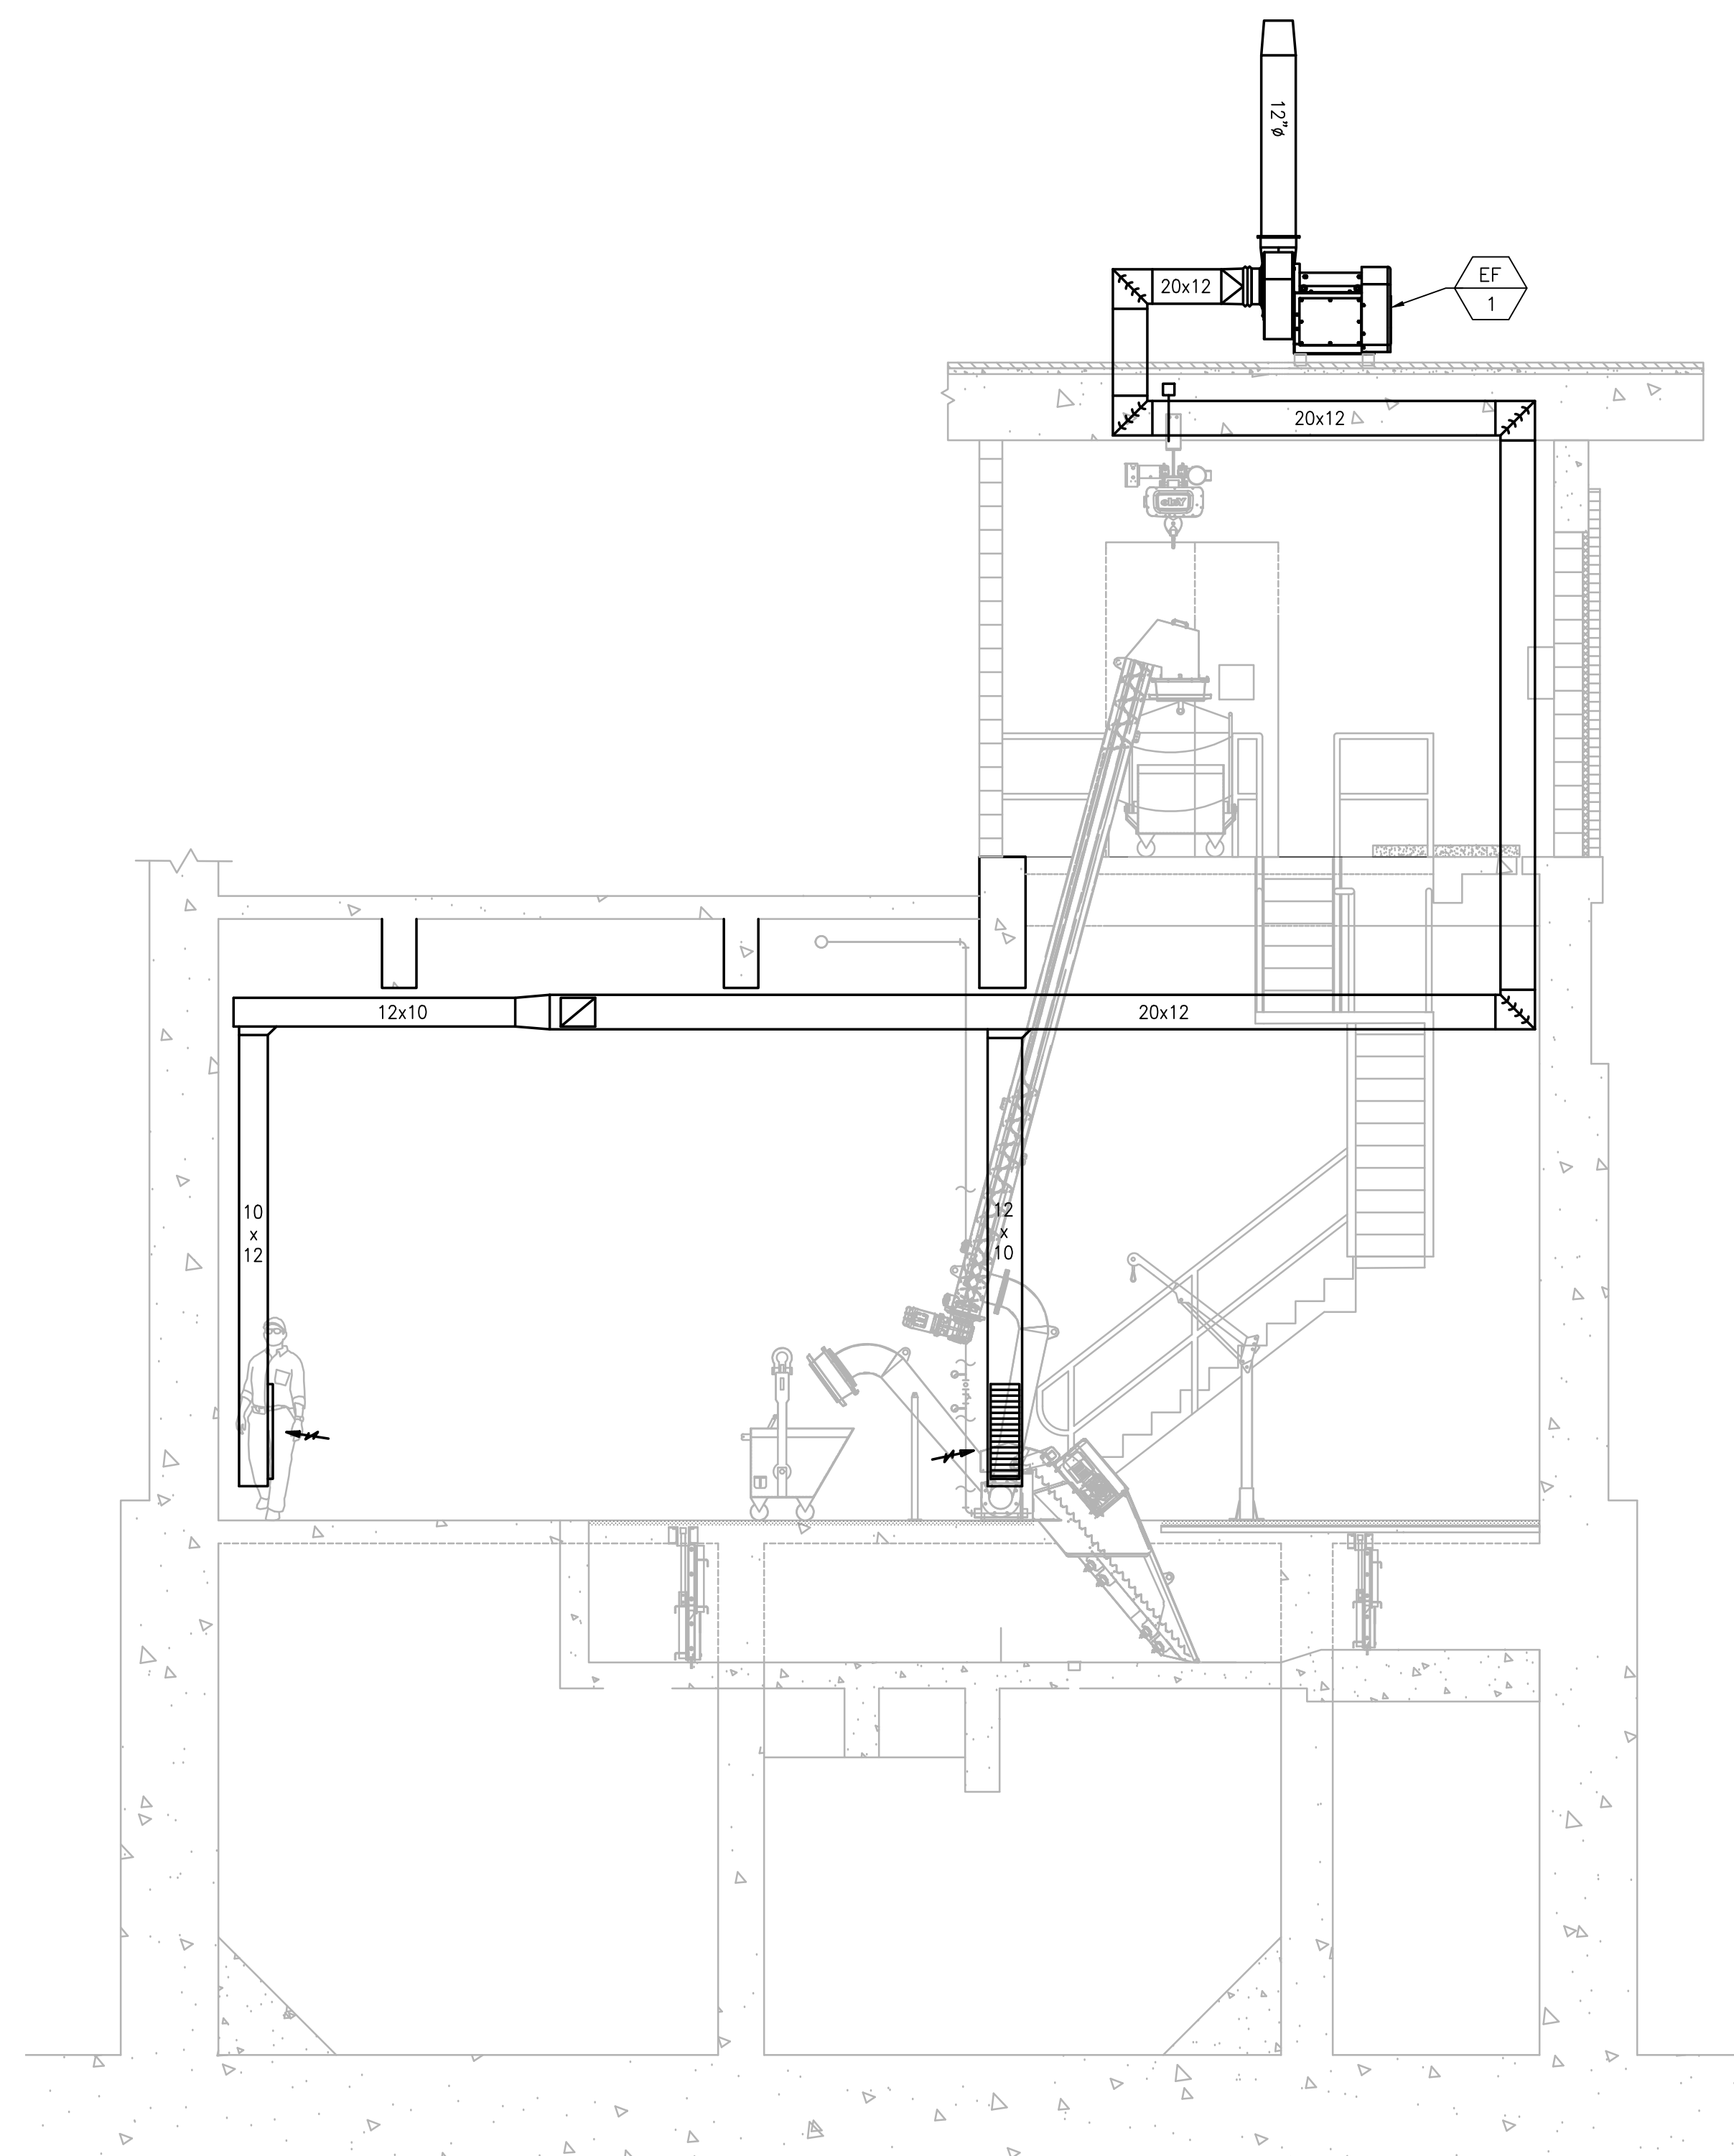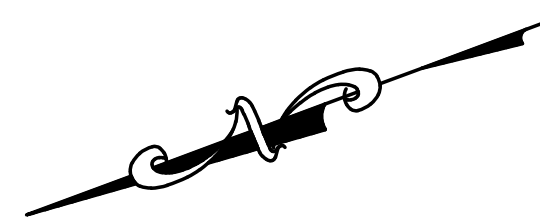SECTION B-B
SCALE: 1/4"=1'-0"
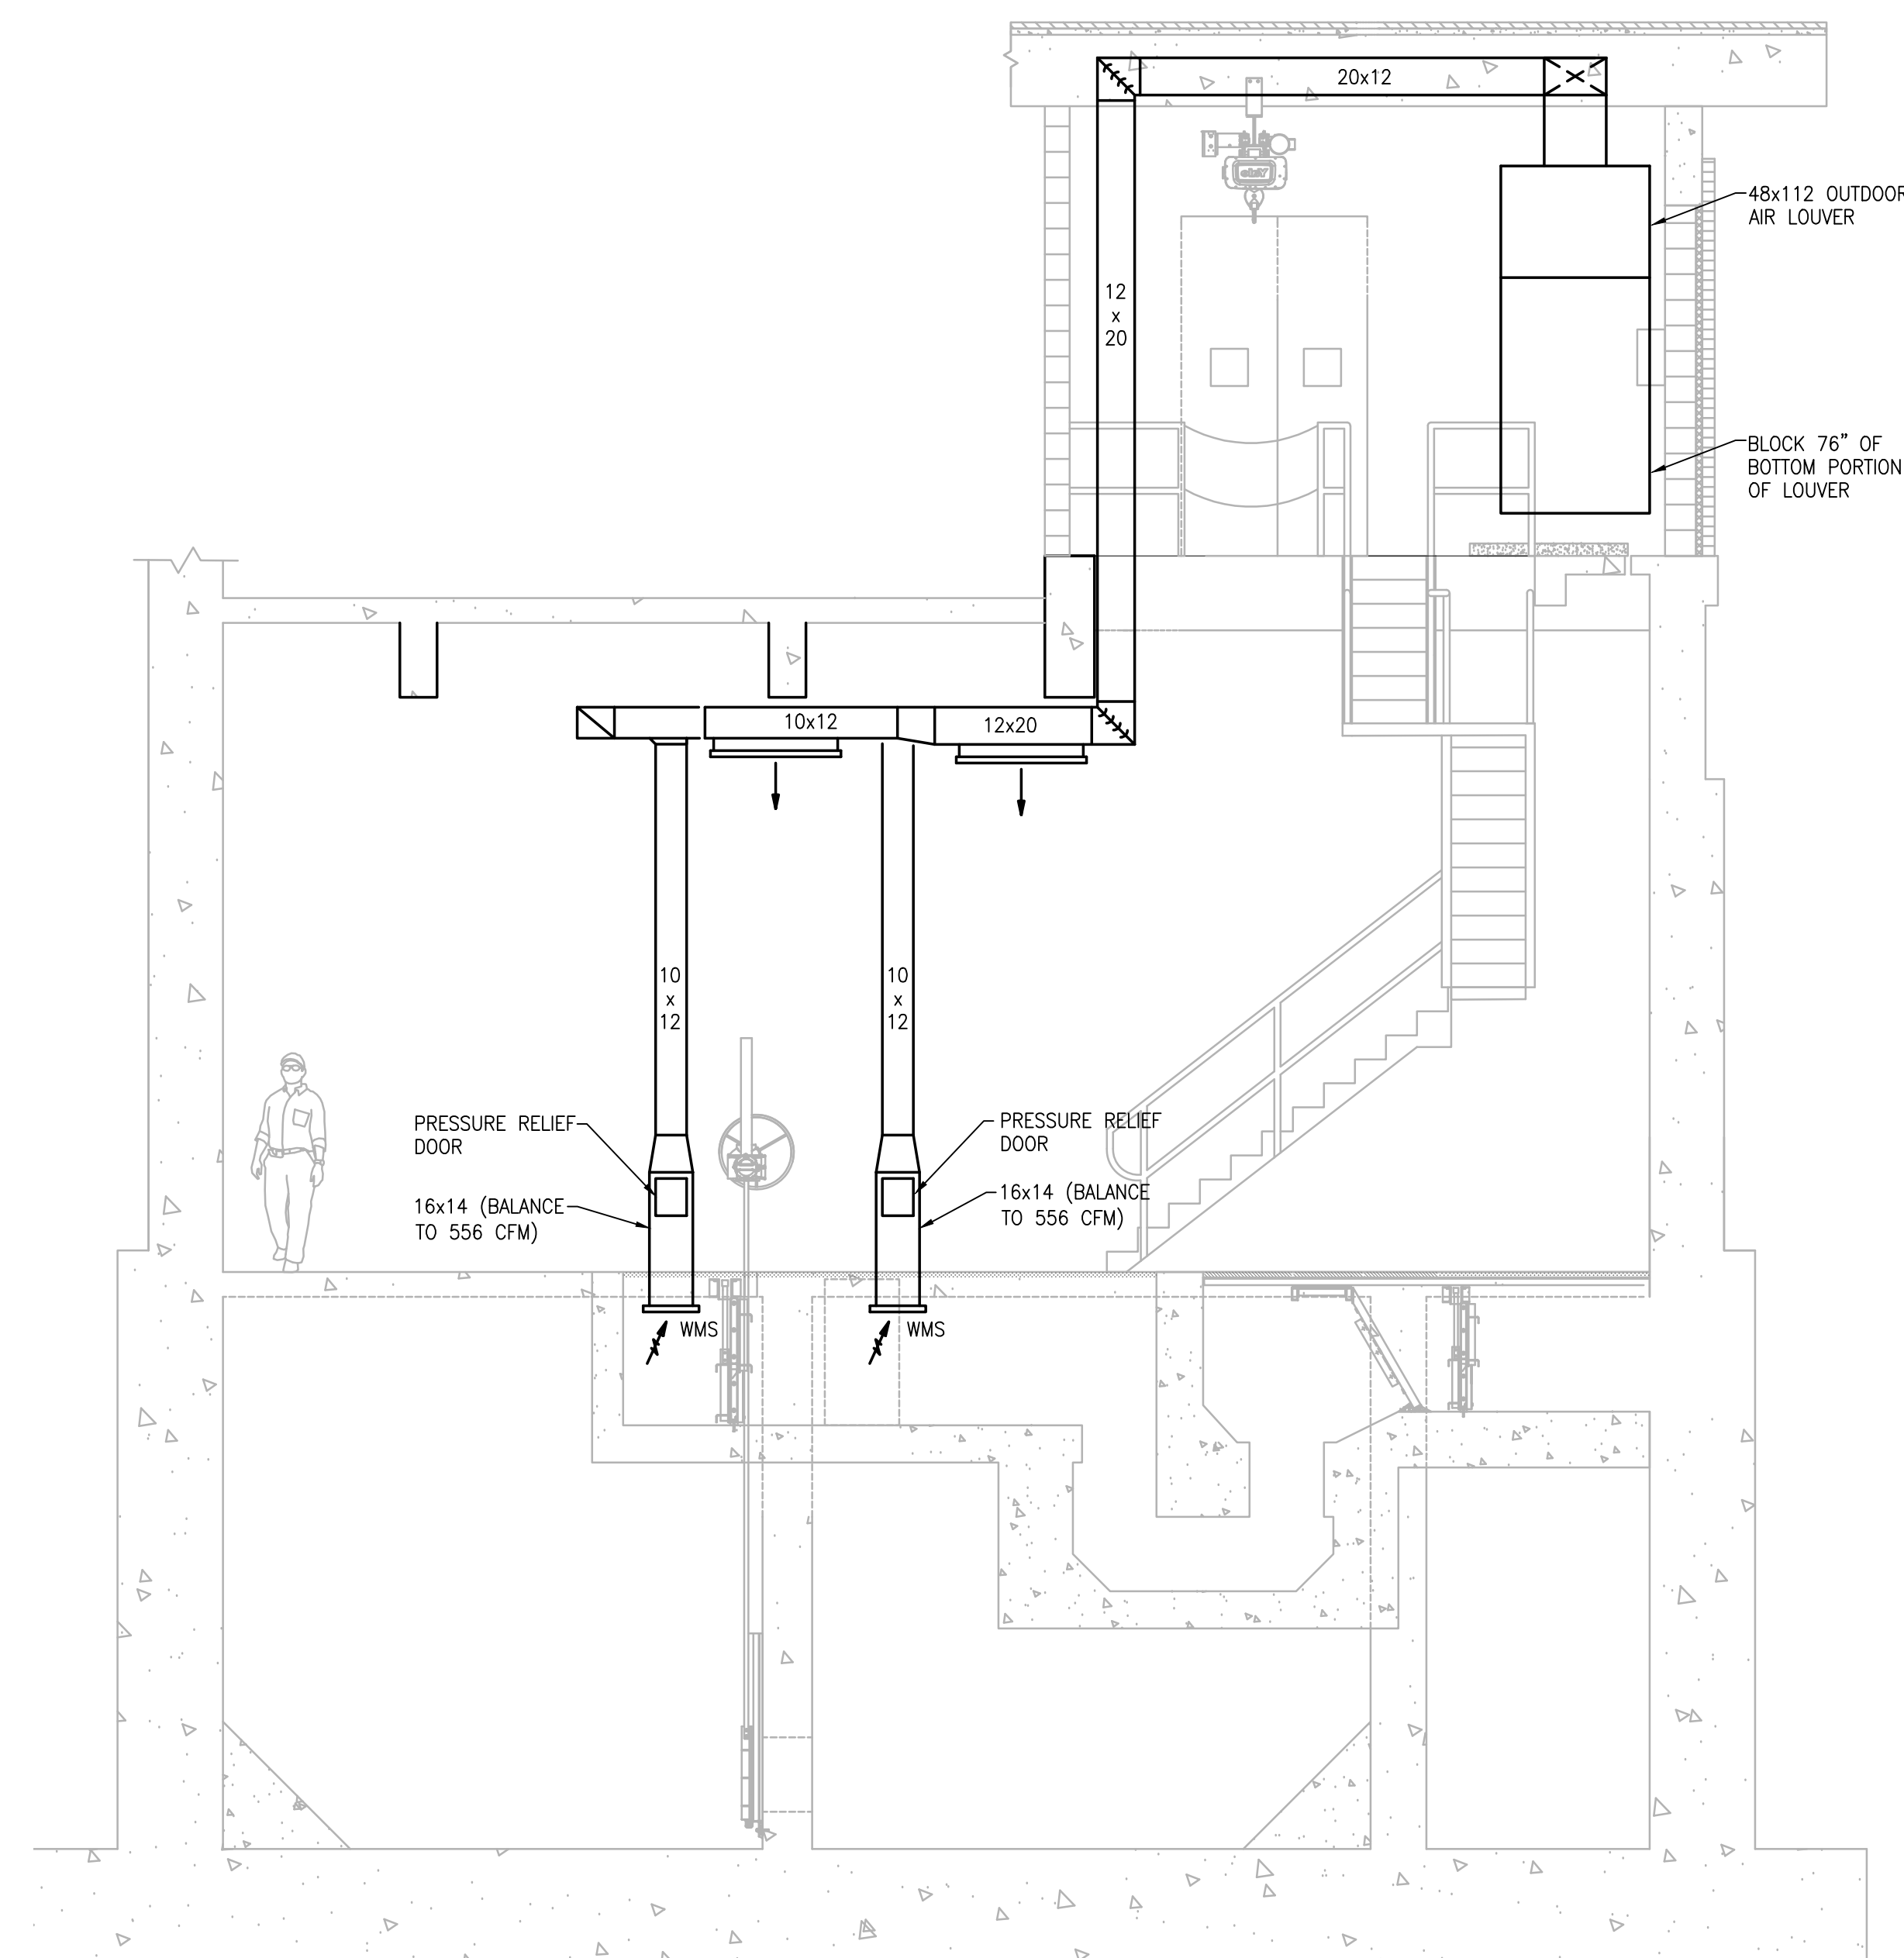
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PROJECT

**BURRILLVILLE WWTF
HEADWORKS &
OAKLAND PUMP
STATION
IMPROVEMENTS**

BURRILLVILLE, RI

TITLE

Headworks

Hvac Sections

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SCALE



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SHEET NO.

H-1.3

PLUMBING NOTES

- THE WORK COVERED CONSISTS OF FURNISHING ALL LABOR AND MATERIALS NECESSARY TO INSTALL COMPLETE AND READY FOR CONTINUOUS OPERATION, THE PLUMBING SYSTEMS, APPARATUS AND EQUIPMENT FOR THIS PROJECT.
- ALL EQUIPMENT AND MATERIALS FURNISHED UNDER THE PLUMBING SUB-CONTRACT, LABOR AND TESTING PERFORMED HEREIN SHALL BE IN COMPLETE ACCORDANCE WITH THE STATE BUILDING CODE, LOCAL FUEL GAS AND PLUMBING CODES, ALL LOCAL CODES AND REGULATIONS, NATIONAL FIRE PROTECTION ASSOCIATION, INSURANCE REGULATIONS AND REQUIREMENTS GOVERNING SUCH WORK.
- ANY AND ALL PERMITS REQUIRED FOR INSTALLATION OF ANY MATERIAL SHALL BE OBTAINED AS PART OF THE WORK OF THE SPECIFICATION INCLUDING ALL FEES OR EXPENSES INCURRED.
- FOR PLUMBING SCHEDULES, REFER TO DRAWING P00.01.
- FOR PLUMBING DETAILS, REFER TO DRAWINGS P03.01.
- ALL PRODUCTS USED AS PART OF THE POTABLE WATER SYSTEM WHERE THE INTENDED PURPOSE IS TO DELIVER OR CONVEY POTABLE WATER FOR HUMAN CONSUMPTION SHALL BE LEAD FREE AND CONFORM TO THE LATEST "LEAD FREE" LAW.
- WHERE WATER PIPING IS SHOWN DROPPING INTO PLUMBING CHASES WITH SIZES NOTED, THAT SIZE SHALL BE CARRIED FULL LENGTH THROUGH THE CHASE. REFER TO PLUMBING FIXTURE SCHEDULE ON THIS DRAWING FOR INDIVIDUAL FIXTURE CONNECTION SIZES.
- UNLESS OTHERWISE NOTED, ALL HORIZONTAL DRAINAGE PIPING WHICH IS 3" OR LESS IN DIAMETER SHALL PITCH OF NOT LESS THAN 1/4" PER FOOT AND ALL HORIZONTAL DRAINAGE PIPING WHICH IS 4" OR LARGER IN DIAMETER SHALL PITCH OF NOT LESS THAN 1/8" PER FOOT.
- ALL BELOW FLOOR PIPING THAT INTERSECTS A GRADE BEAM REQUIRES COORDINATION WITH STRUCTURAL.
- PROVIDE ALL FLOOR CLEANOUTS WITH HUB AND SPIGOT; LEAD AND OAKUM JOINTS FROM CLEANOUT TO AND INCLUDING CONNECTION TO SANITARY OR STORM DRAIN.
- REFER TO ARCHITECTURAL PLANS FOR EXACT LOCATION AND HEIGHT OF ALL PLUMBING FIXTURES.
- MISCELLANEOUS DISCREPANCIES OR OMISSIONS WHICH MIGHT APPEAR ON THE PLANS OR SPECIFICATIONS WILL NOT RELIEVE THE PLUMBING SUB-CONTRACTOR OF CODE COMPLIANCE.
- ALL FLOOR DRAINS SHALL BE PROVIDED WITH A TRAP PRIMER CONNECTION. CONTRACTOR SHALL PROVIDE ALL ASSOCIATED EQUIPMENT NECESSARY TO PROVIDE A COMPLETE SYSTEM.
- PROVIDE CLEANOUTS AT ALL CHANGE OF DIRECTIONS FOR STORM AND SANITARY/WASTE PIPING.
- PROVIDE DANDY CLEANOUTS AT ALL EXPOSED STORM AND SANITARY/WASTE PIPING 18 INCHES (APPROXIMATELY) ABOVE FINISHED FLOOR WHERE PIPING GOES BELOW FINISHED FLOOR/GRADE.
- PROVIDE WALL CLEANOUTS WITH ACCESS PANELS AT ALL STORM AND SANITARY/WASTE PIPING WITHIN PIPE CHASES OR WALLS.
- HANDICAPPED ACCESSIBLE FIXTURES SHALL BE IN ACCORDANCE WITH THE AMERICANS WITH DISABILITIES ACT ACCESSIBILITY GUIDELINES FOR BUILDINGS AND FACILITIES AND THE RULES AND REGULATIONS OF THE MASSACHUSETTS ARCHITECTURAL ACCESS BOARD. WHERE THE TWO STANDARDS DIFFER, THE MORE STRINGENT SHALL APPLY.
- ALL INTERIOR BURIED DOMESTIC WATER PIPING, NON-POTABLE WATER PIPING, TEMPERED WATER PIPING OR AIR PIPING SHALL BE SOFT ROLLED "K" COPPER COIL AND BE PROTECTED WITH A HIGH DENSITY RUBBER INSULATION. FITTINGS SHALL NOT BE PERMITTED IN OR UNDER SLAB. PROVIDE SLAB PENETRATIONS WITH SLEEVE AND FIRE STOPPING.

PLUMBING DEMOLITION NOTES

- UNLESS OTHERWISE NOTED, ALL EXISTING PLUMBING SYSTEMS WITHIN HATCH MARKS (COLD WATER, HOT WATER, HOT WATER RETURN, SANITARY, RAIN LEADERS, ETC) AND ASSOCIATED EQUIPMENT IS TO BE DEMOLISHED OR SALVAGED. REMOVE THE EQUIPMENT TO BE DEMOLISHED OR SALVAGED PER SECTION 02050. ALL CONTROL DEVICES ASSOCIATED WITH THE DEMOLISHED EQUIPMENT SHALL BE REMOVED.
- NO PIPING OR EQUIPMENT INDICATED FOR DEMOLITION WILL BE REUSED OR SALVAGED UNLESS SPECIFICALLY NOTED AS SUCH. ALL EQUIPMENT REMOVED SHALL BE REMOVED FROM SITE AND PROPERLY DISPOSED OF. PRIOR TO REMOVAL OF EQUIPMENT COORDINATE WITH OWNER FOR ANY EQUIPMENT THE OWNER WILL KEEP.
- EXISTING EQUIPMENT INDICATED ON THE DEMOLITION PLANS ARE BASED ON SITE OBSERVATIONS AND IT IS NOT THE INTENTION OF THESE DRAWINGS TO SHOW ALL EQUIPMENT AND MATERIALS TO BE DISCONNECTED AND/OR REMOVED.

PLUMBING LEGEND

SYMBOL	ABBREVIATION	DESCRIPTION
	ETR	LIGHT LINE INDICATES EXISTING PIPING TO REMAIN
	RE	REMOVE EXISTING PIPING
	CTE	CONNECT TO EXISTING
	C&C	CUT & CAP
		BELOW FLOOR PIPING (INDICATED AS DOUBLE LINEWORK)
	CW	COLD WATER
	NPCW	NON-POTABLE COLD WATER
	NPHW	NON-POTABLE HOT WATER
	S or W	SOIL OR WASTE
	V	VENT
	RW	RAIN WATER CONDUCTOR
	CONT	CONTINUATION
	UP	PIPE RISE OR UP
	DN	PIPE DROP OR DOWN
	TEE	PIPE TEE
	SOV	SHUT-OFF VALVE
	PRV	PRESSURE REDUCING VALVE
	CV	CHECK VALVE
	BVA	BALANCING VALVE ASSEMBLY
	W & T	WASTE & TRAP
	CO	CLEANOUT PLUG
	FCO	FLUSH FLOOR CLEANOUT
	DCO	DANDY CLEANOUT
		CAPPED PIPE
		ARROW INDICATES DIRECTION OF FLOW
		ARROW INDICATES DIRECTION OF SLOPE
		UNION
	PA	PIPE ANCHORS
	PGD	PIPE GUIDES
	HB	HOSE BIBB
	WH	WALL HYDRANT
		DIAGRAM NO. & DWG. NO. REFERENCE
	FD "A"	FLOOR DRAIN & TYPE
	RD "A"	ROOF DRAIN & TYPE

PLUMBING LEGEND


ABBREVIATION	DESCRIPTION
WH-1	WATER HEATER & NUMBER
SS	SOIL STACK
VS	VENT STACK
VTR	VENT THRU ROOF
INV	INVERT
TMV	THERMOSTATIC MIXING VALVE
TW	TEMPERED WATER (70°F)
TYP	TYPICAL
NTS	NOT TO SCALE
AFF	ABOVE FINISHED FLOOR
LPC	LIMIT OF PLUMBING CONTRACT
GC	GENERAL CONTRACTOR
FPC	FIRE PROTECTION CONTRACTOR
PC	PLUMBING CONTRACTOR
EC	ELECTRICAL CONTRACTOR
HVAC	HVAC CONTRACTOR
LPC	LIMIT OF PLUMBING CONTRACT
WC	WATER CLOSET
UR	URINAL
LAV	LAVATORY
MR	MOP RECEPTOR
SHR	SHOWER
DF	DRINKING FOUNTAIN
SK	SINK
F & I	FURNISH & INSTALL
S=.01	SLOPE = 1/8" PER FOOT
S=.02	SLOPE = 1/4" PER FOOT
NO	NORMALLY OPEN
NC	NORMALLY CLOSED
F.F.E.	FINISHED FLOOR ELEVATION

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PROJECT

**BURRILLVILLE WWTF
HEADWORKS &
OAKLAND PUMP
STATION
IMPROVEMENTS**

BURRILLVILLE, RI

TITLE

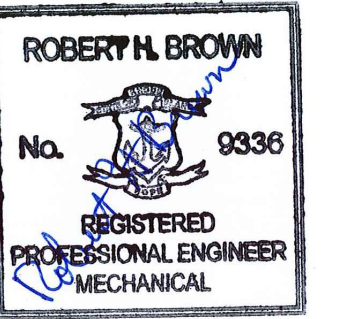Plumbing Legend
and Notes

NO.	REVISIONS	DATE

DRAWN BY: RLB

DESIGNED BY: RLB

CHECKED BY: RHB

ISSUE DATE: MAY 2023

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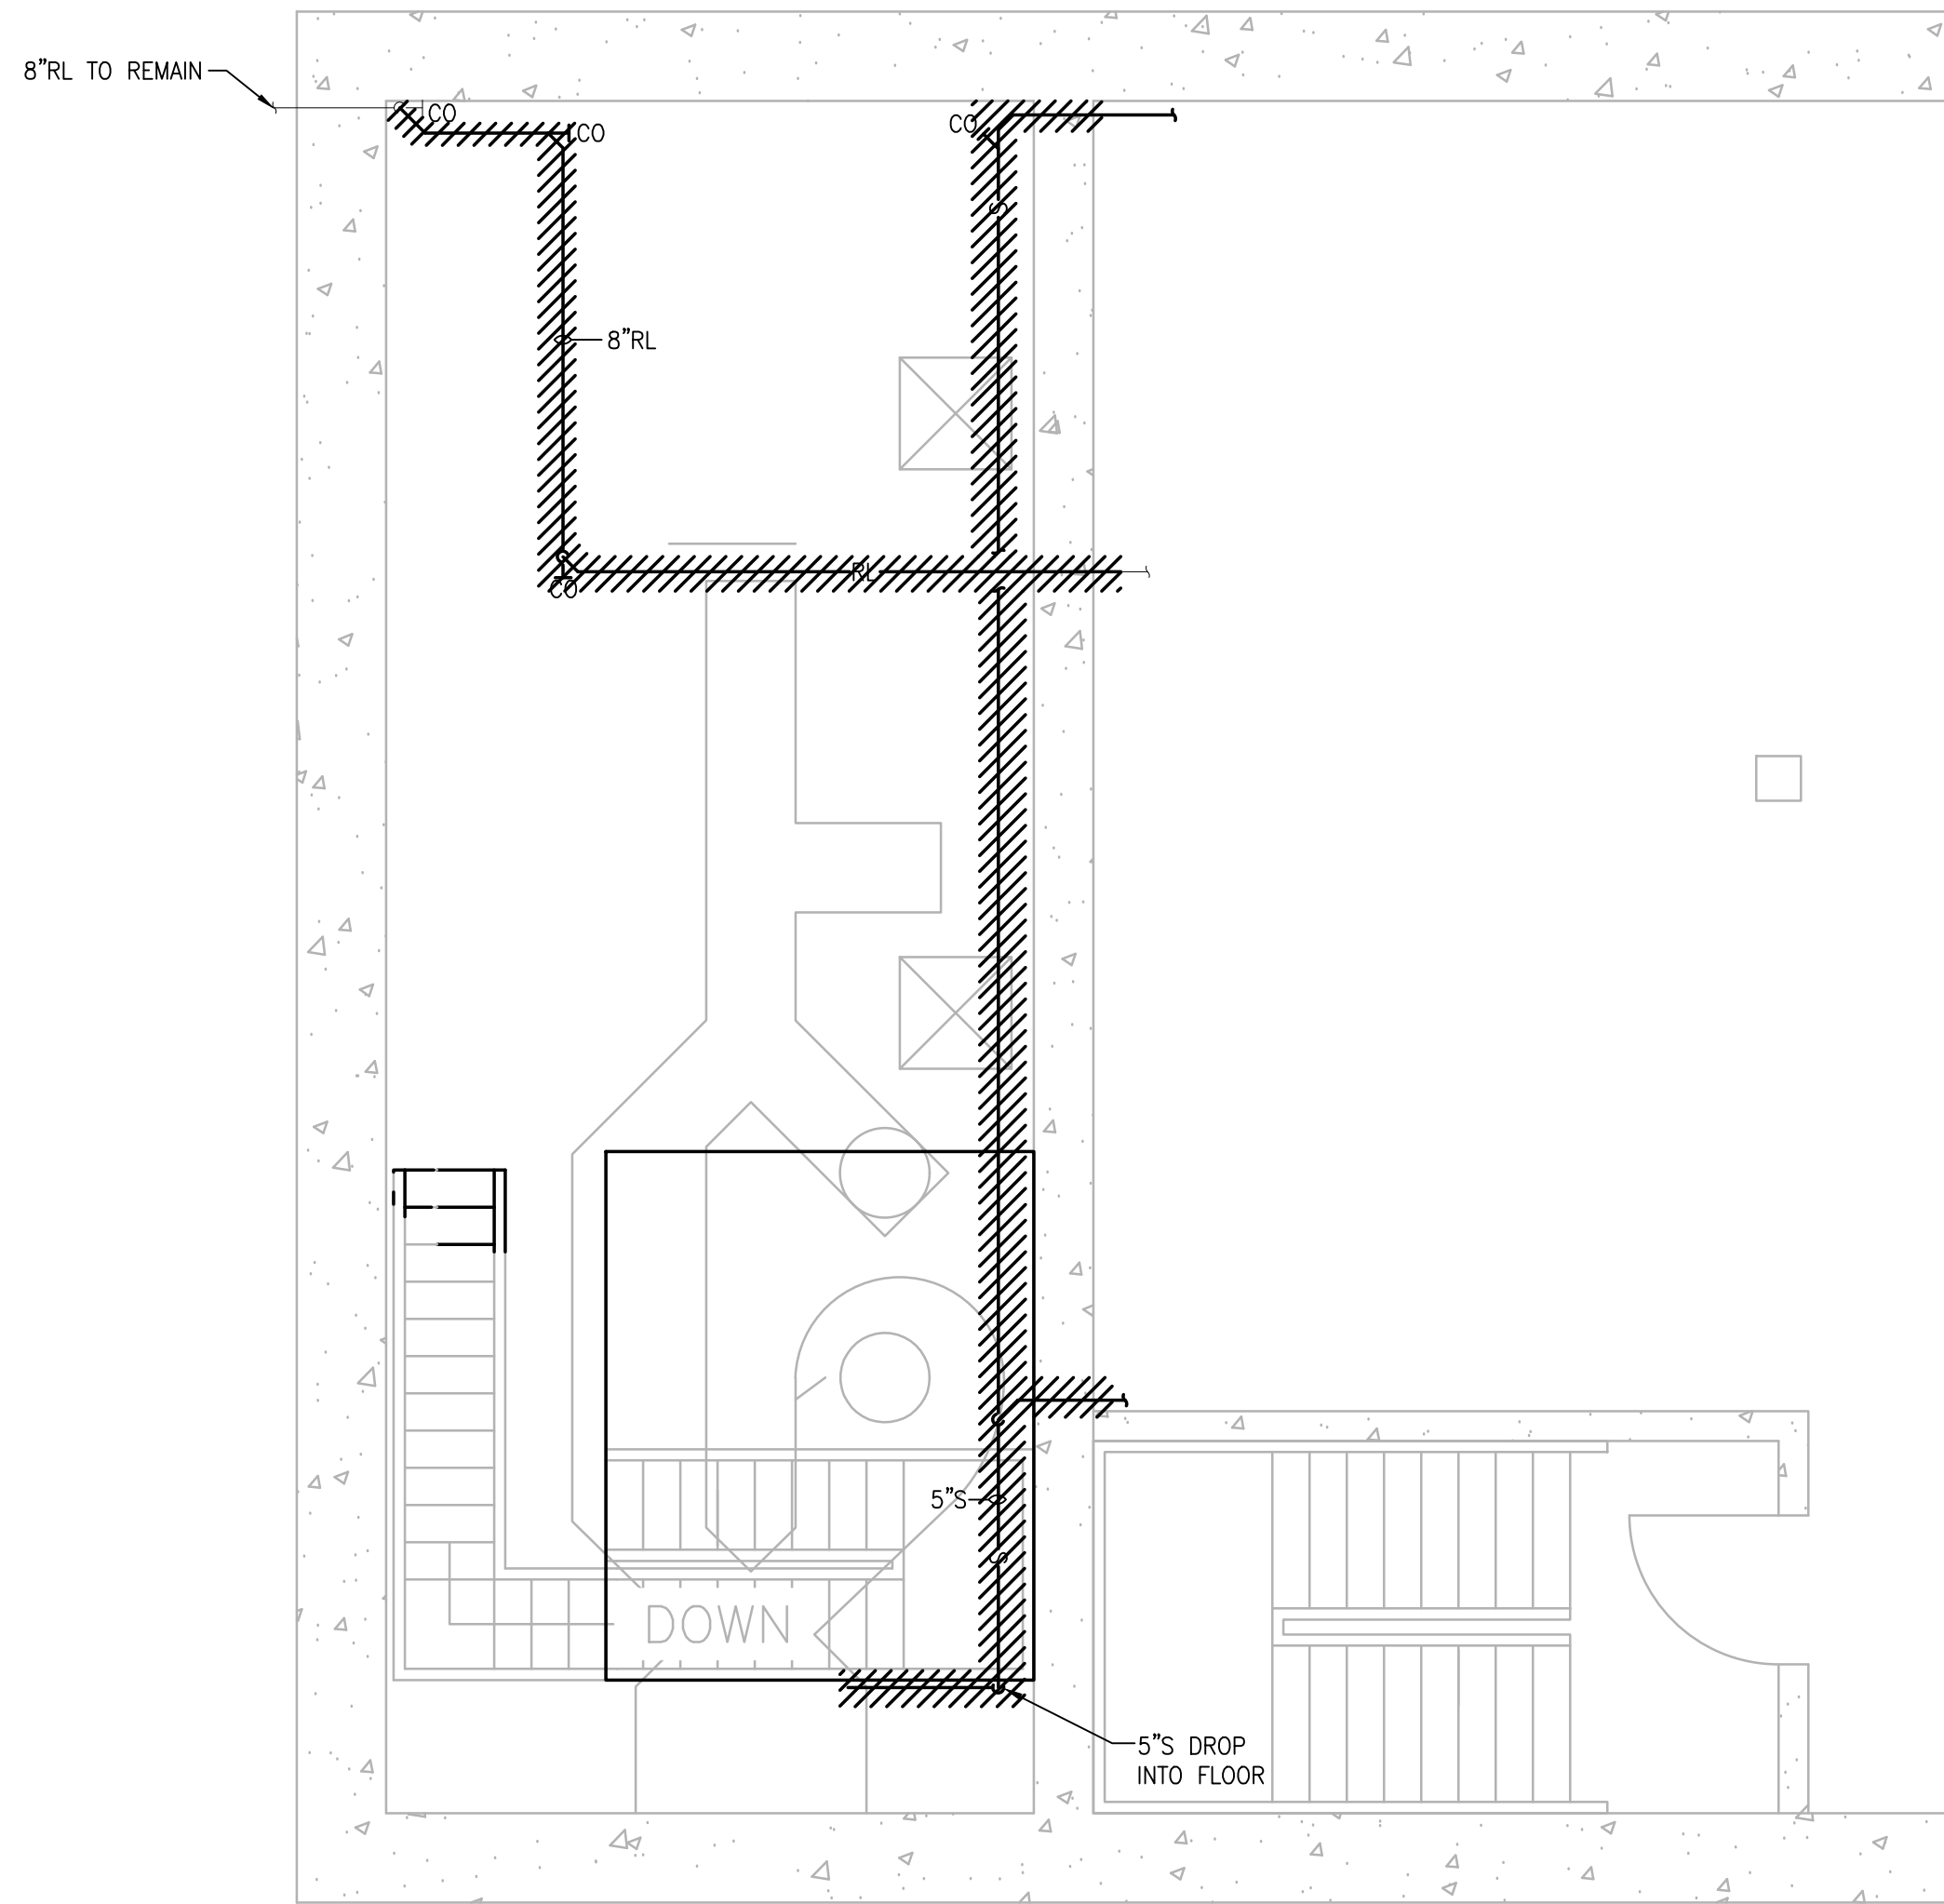
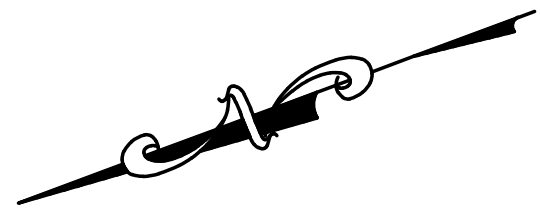
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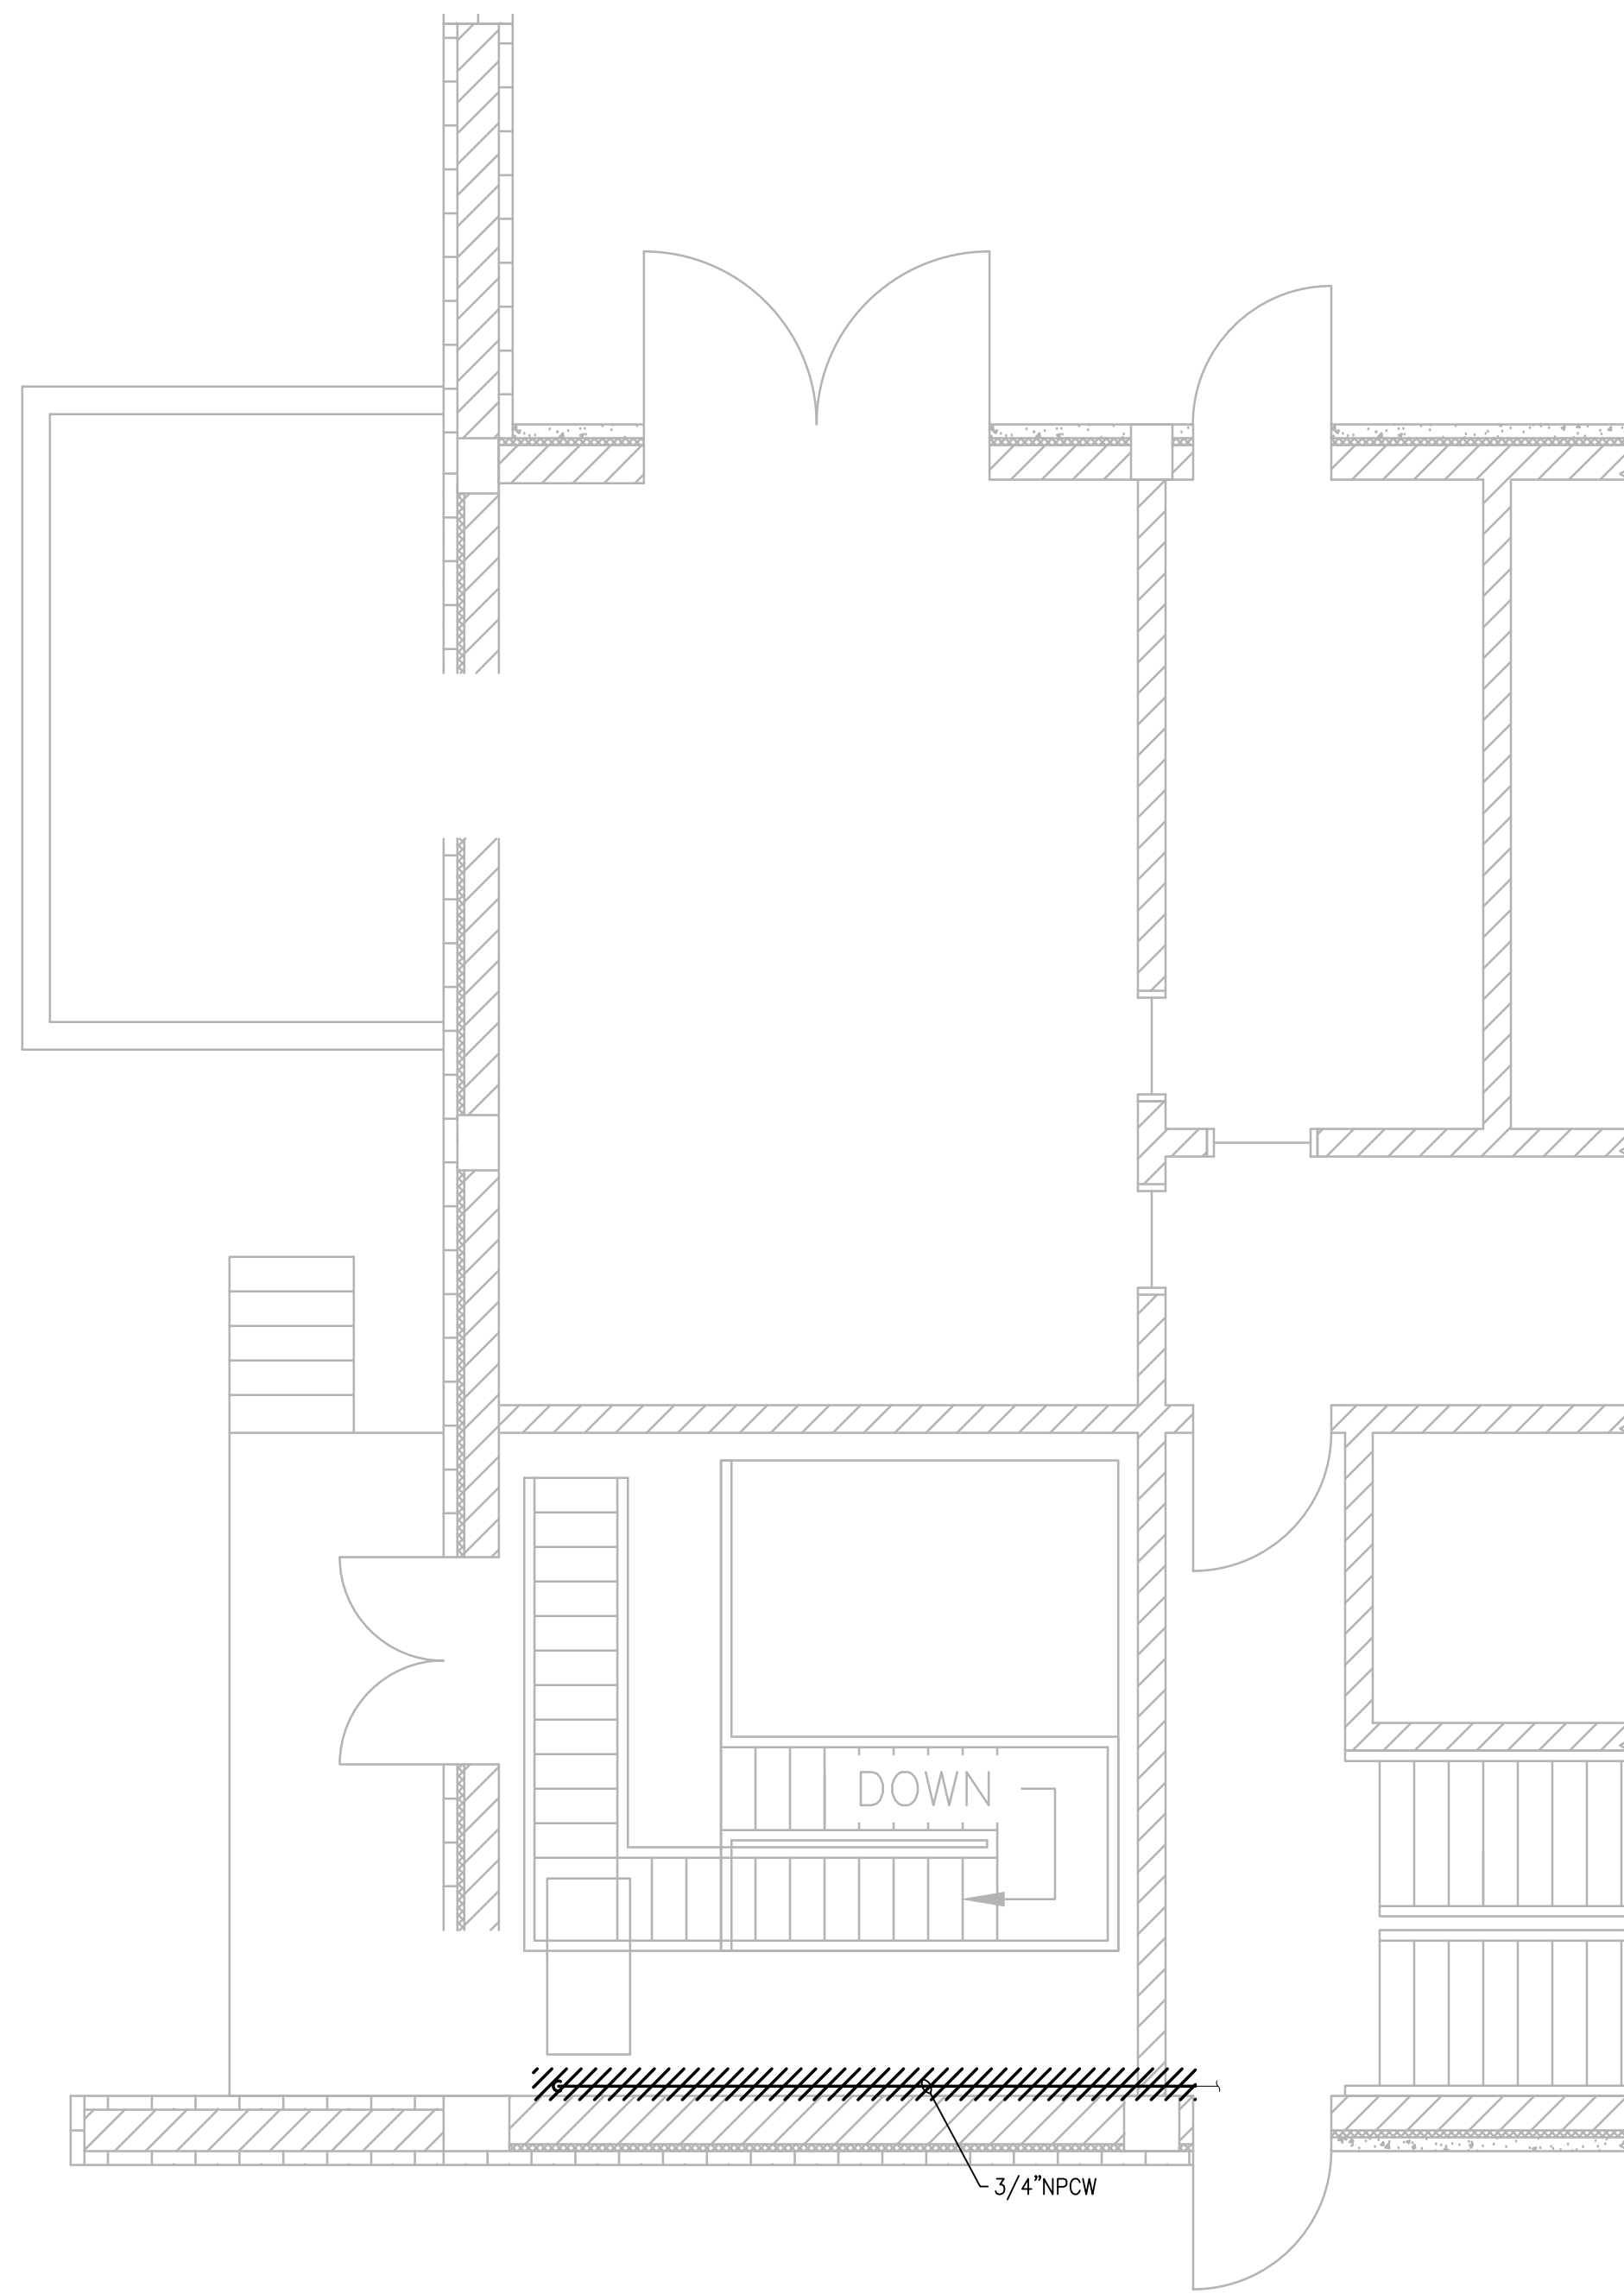
SHEET NO.

P-0.1



LOWER LEVEL DEMOLITION PLAN

SCALE: 1/4"=1'-0"



UPPER LEVEL DEMOLITION PLAN

SCALE: 1/4"=1'-0"

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PROJECT

**BURRILLVILLE WWTF
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BURRILLVILLE, RI

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Headworks

Plumbing
Demolition
Plans

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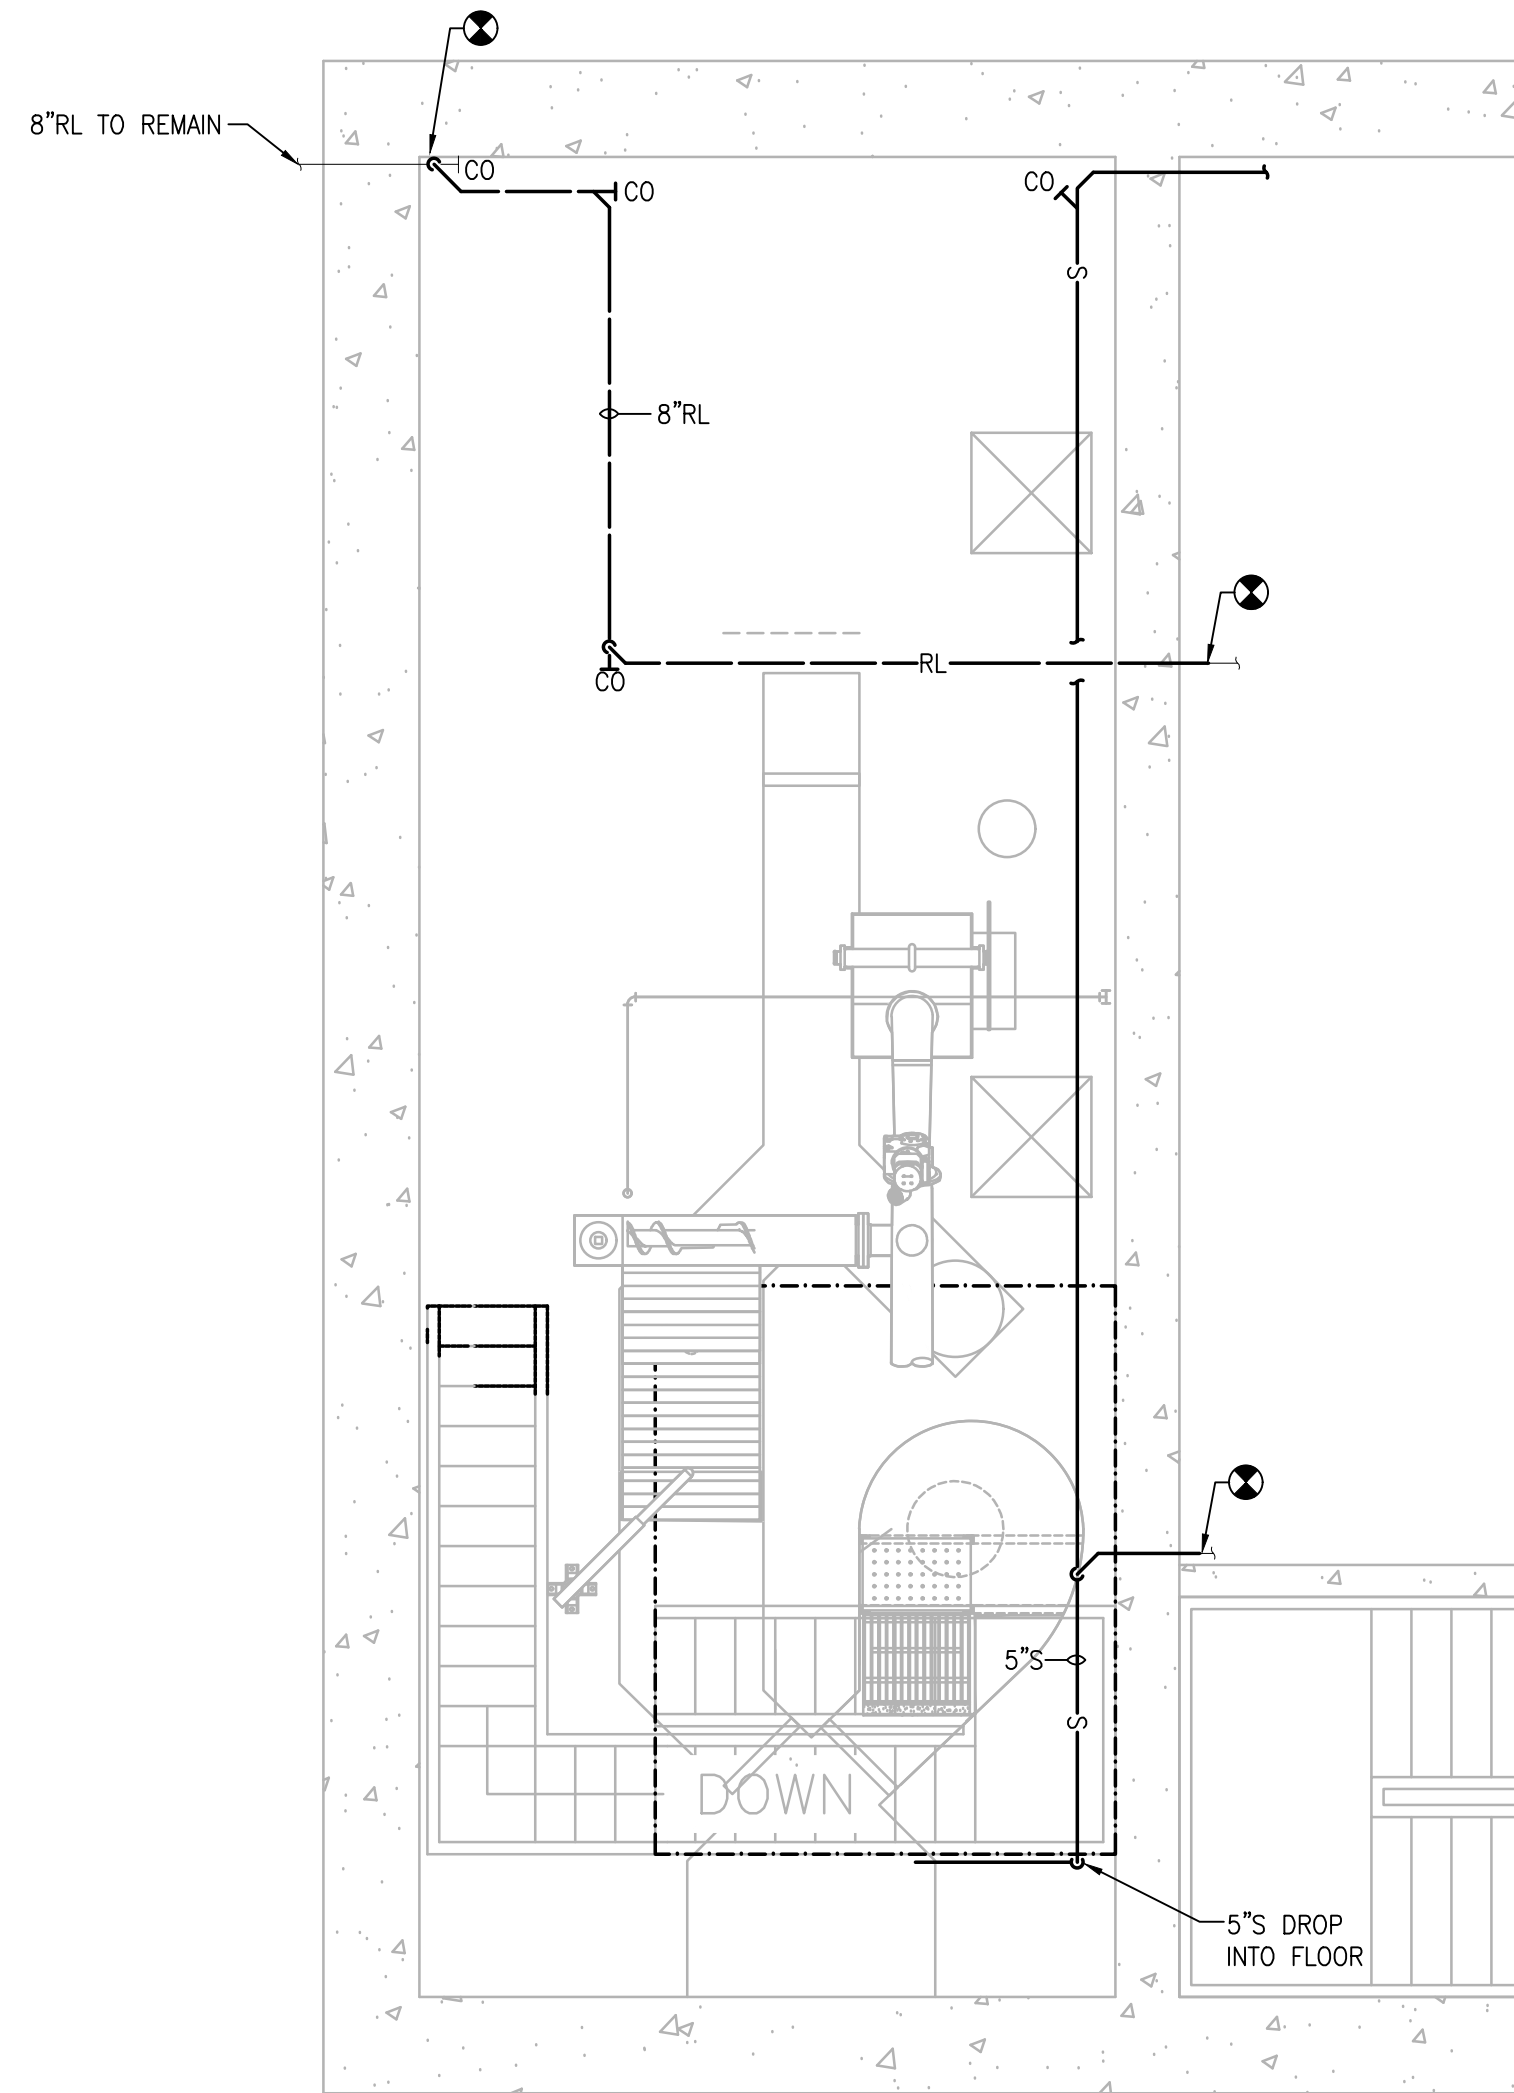
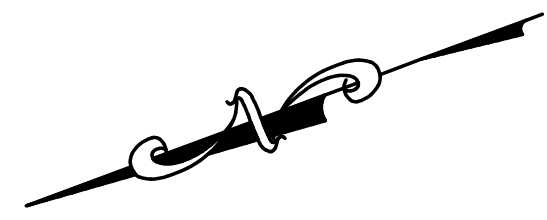
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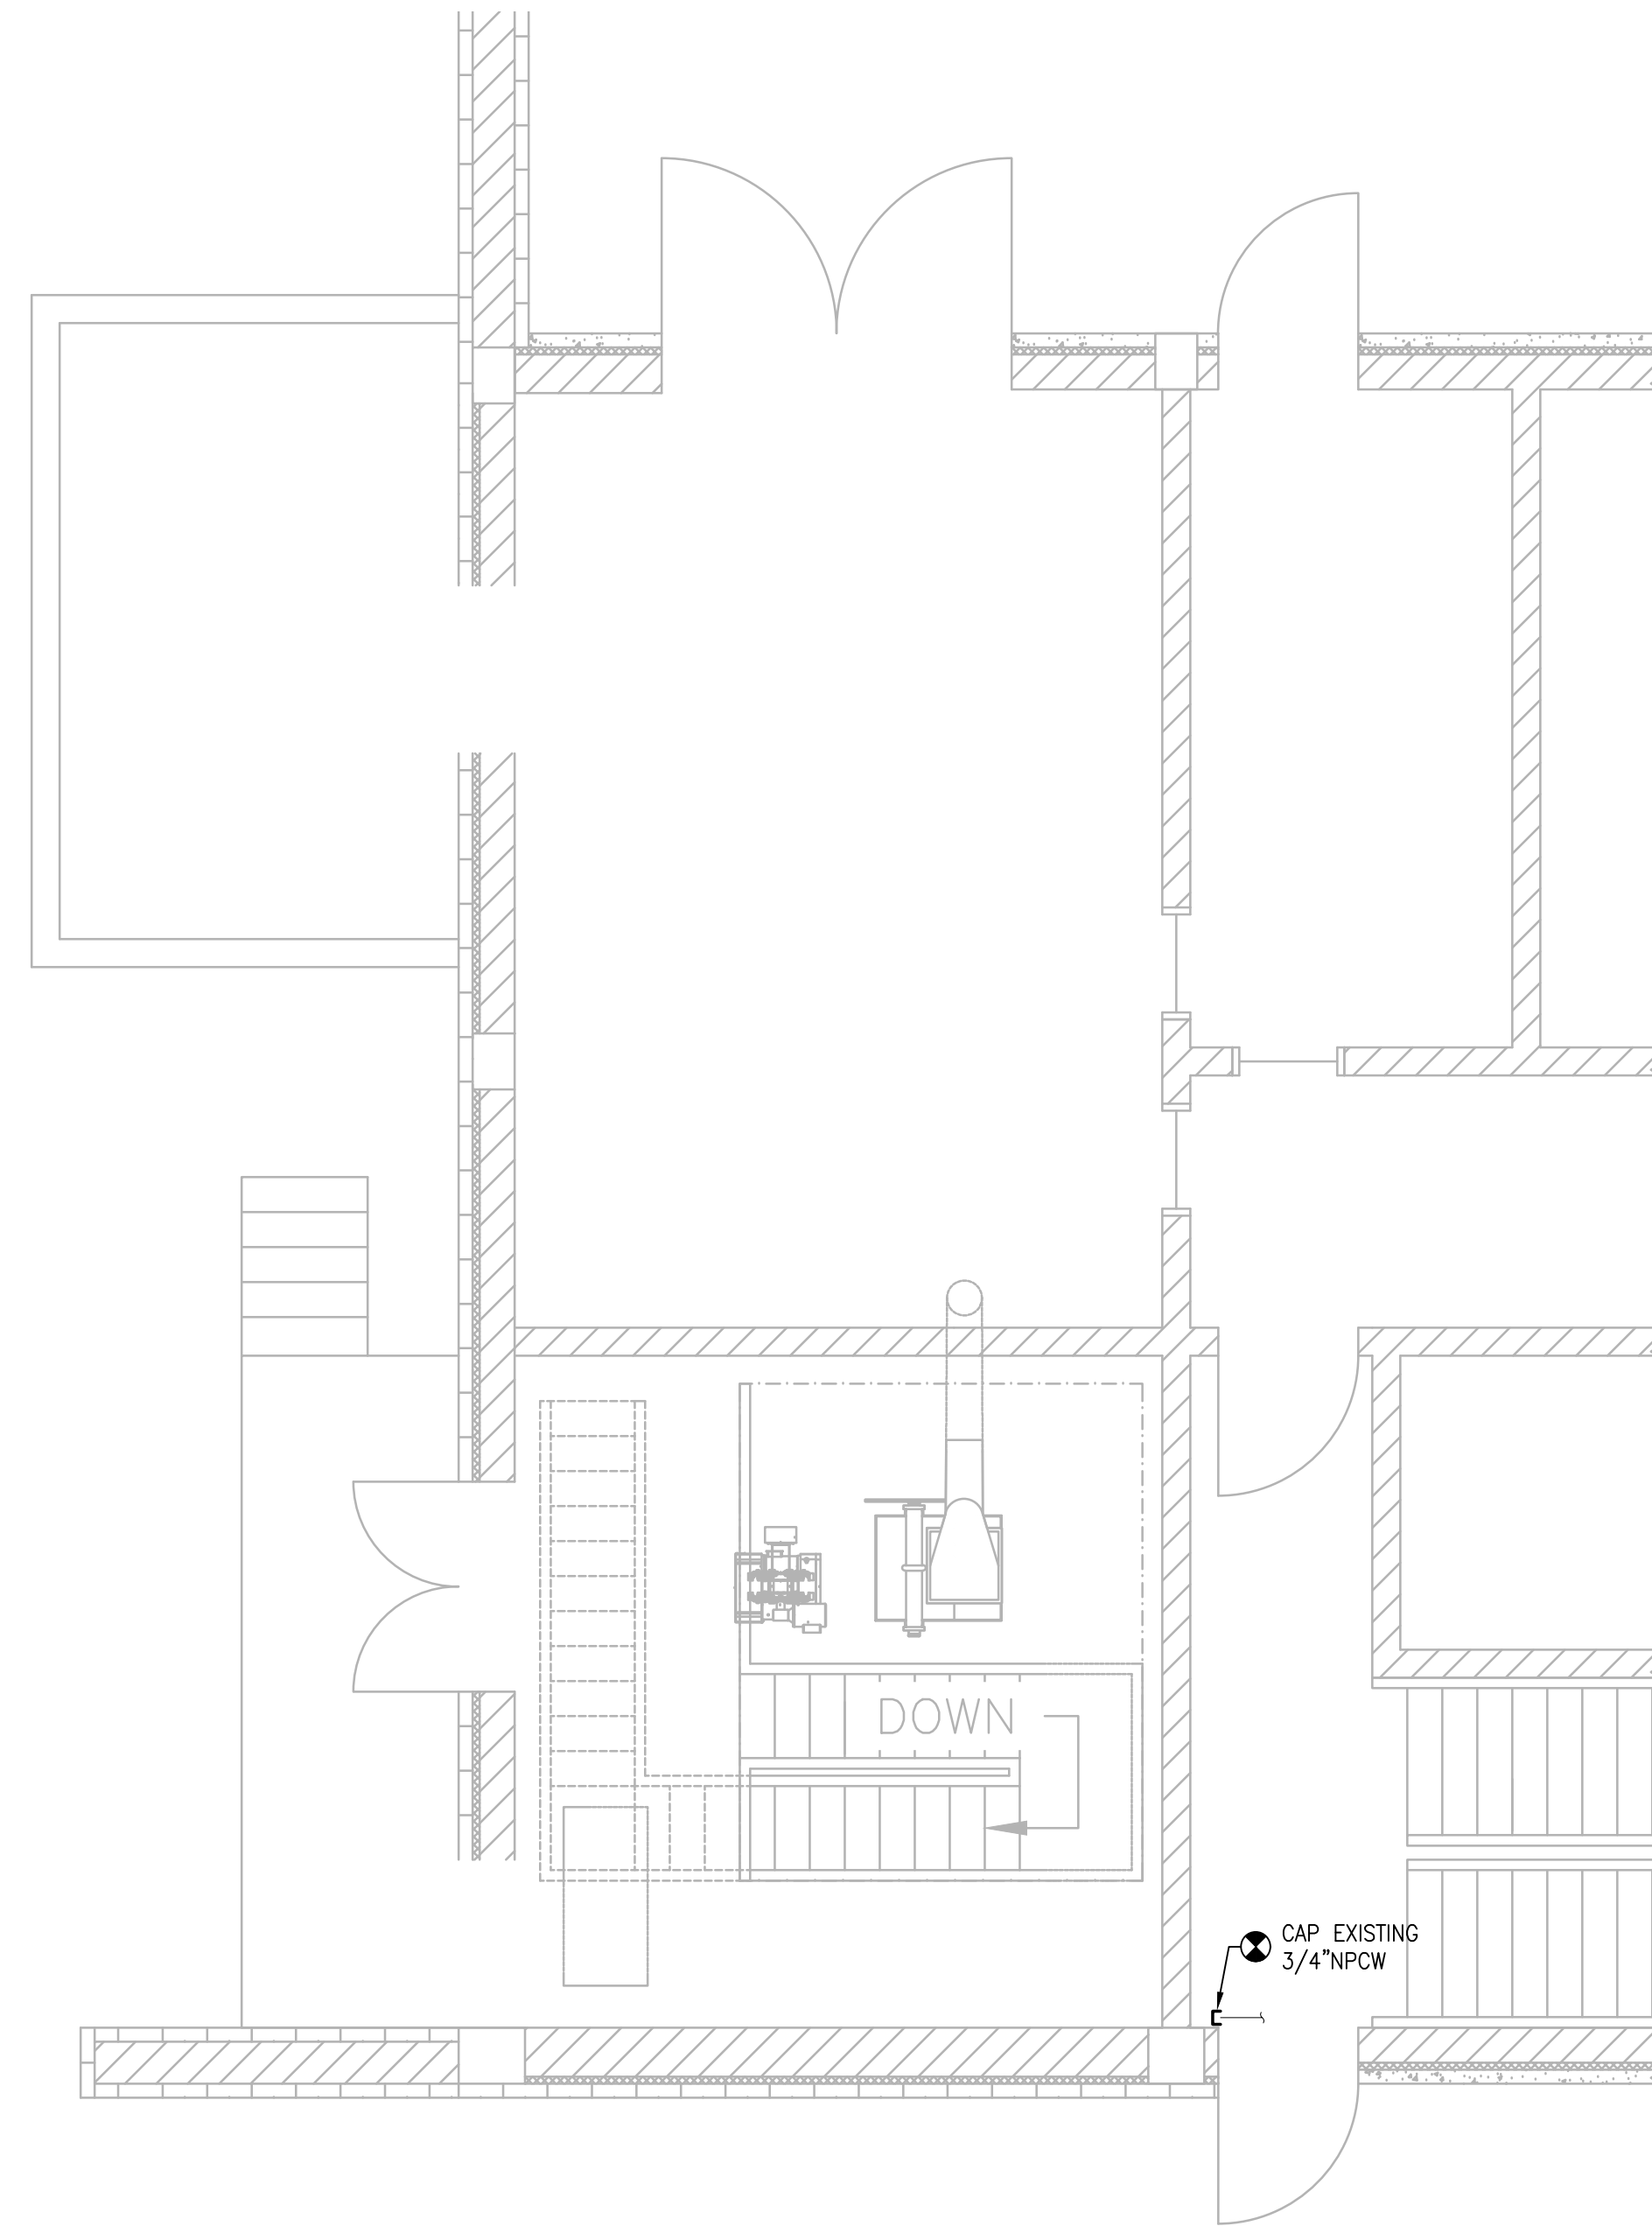
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P-1.1



LOWER LEVEL NEW WORK PLAN

SCALE: 1/4"=1'-0"



UPPER LEVEL NEW WORK PLAN

SCALE: 1/4"=1'-0"

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OAKLAND PUMP
STATION
IMPROVEMENTS**

BURRILLVILLE, RI

TITLE

Headworks

Plumbing New
Work Plans

NO.	REVISIONS	DATE

DRAWN BY: RLB

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CHECKED BY: RHB

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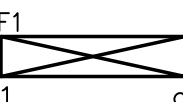
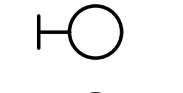
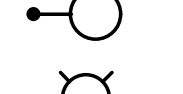



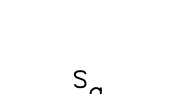
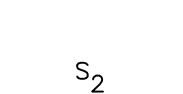
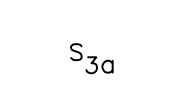
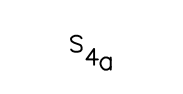



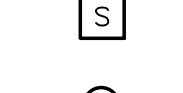





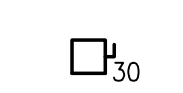
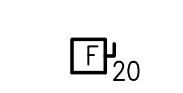

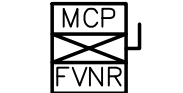
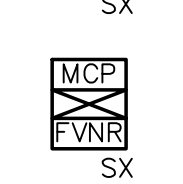
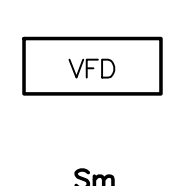
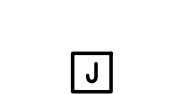



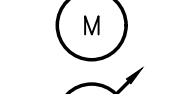

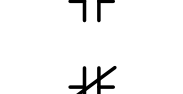
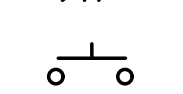

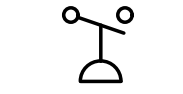
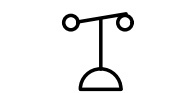
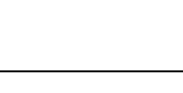




UNLESS OTHERWISE NOTED OR CHANGED BY REPRODUCTION



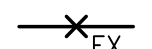



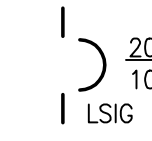
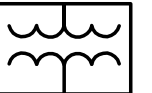





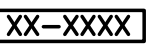



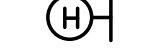


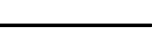


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
ELECTRICAL SYMBOLS

	LINEAR LIGHTING FIXTURES "F1" INDICATES FIXTURE TYPE - TYPICAL FOR ALL FIXTURES "1" INDICATES CIRCUIT NUMBER - TYPICAL FOR ALL FIXTURES "g" INDICATES THE SWITCH CONTROL - TYPICAL FOR ALL FIXTURES
	WALL MOUNTED LIGHTING FIXTURE.
	POLE MOUNTED SITE LIGHT FIXTURE
	SURFACE OR PENDANT MOUNTED FIXTURE.
	EMERGENCY EXIT SIGN
	EMERGENCY LIGHTING BATTERY UNIT WITH TWO LIGHT HEADS
	REMOTE EMERGENCY LIGHTING UNIT WITH TWO LIGHTING HEADS PROVIDE 3/4", 2#10, 1#10GND TO NEAREST THE EMERGENCY LIGHTING BATTERY UNIT
	SINGLE POLE SWITCH 120V, 20A "g" INDICATES THE SWITCH CONTROL
	2-POLE SWITCH 120V, 20A 1 POLE FOR ROOM LIGHT FIXTURES, 1-POLE FOR EXHAUST FAN CONTROL
	3-WAY SWITCH 120V, 20A "g" INDICATES THE SWITCH CONTROL
	4-WAY SWITCH 120V, 20A "g" INDICATES THE SWITCH CONTROL
	DIGITAL TIME CLOCK SWITCH
	MECHANICAL TIMER SWITCH
	WALL MOUNTED DUAL TECHNOLOGY OCCUPANCY SENSOR/SWITCH
	LOW VOLTAGE SWITCH
	CEILING MOUNTED DUAL TECHNOLOGY OCCUPANCY SENSOR
	DUPLEX RECEPTACLE, WEATHER-RESISTANT 120V, 20A WITH WEATHERPROOF COVER. "GFI" INDICATES GROUND FAULT TYPE "1" INDICATES CIRCUIT NUMBER - TYPICAL FOR ALL RECEPTABLES
	DUPLEX RECEPTACLE 120V, 20A
	(2) DUPLEX (QUAD) RECEPTABLES, 120V, 20A "WP" INDICATES WITH WEATHERPROOF COVER
	SIMPLEX RECEPTACLE, WP INDICATES WEATHER RESISTANT 120V, 20A "WP" INDICATES WITH WEATHERPROOF COVER
	UNFUSED DISCONNECT SWITCH, "30" INDICATES 30 AMP RATING, PROVIDE 3-POLE UNLESS OTHERWISE INDICATED.
	FUSED DISCONNECT SWITCH, "20" INDICATES 20 AMP FUSE RATING, PROVIDE 3-POLE UNLESS OTHERWISE INDICATED.
	3-PHASE RECEPTACLE
	WALL MOUNTED COMBINATION MOTOR STARTER WITH MOTOR CIRCUIT PROTECTOR. "FVNR" INDICATES TYPE OF MOTOR STARTER, "SX INDICATES THE MOTOR STARTER NEMA SIZE"
	MOTOR STARTER WITH MOTOR CIRCUIT PROTECTOR. "FVNR" INDICATES TYPE OF MOTOR STARTER, "SX INDICATES THE MOTOR STARTER NEMA SIZE"
	ENCLOSED VARIABLE FREQUENCY DRIVE
	MANUAL MOTOR STARTER 120V, 20A
	JUNCTION BOX OR PULL BOX
	HAND HOLE
	ALARM RELAY, "AR1" REFERS TO RELAY NAME DESIGNATION
	CONTROL RELAY, "CR1" REFERS TO RELAY NAME DESIGNATION
	MOTOR START RELAY
	TIMING RELAY, "TR1" REFERS TO RELAY NAME DESIGNATION
	NORMALLY OPEN RELAY CONTACT
	NORMALLY CLOSED RELAY CONTACT
	OPERATOR PUSH BUTTON NORMALLY OPEN CONTACT
	OPERATOR PUSH BUTTON NORMALLY CLOSED CONTACT
	PRESSURE SWITCH - CLOSING ON HIGH PRESSURE
	PRESSURE SWITCH - CLOSING ON LOW PRESSURE







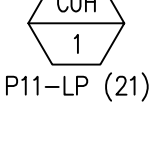




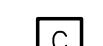

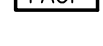
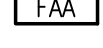

ELECTRICAL SYMBOLS

	UNDERGROUND CONDUIT DUCT BANK
	HOMERUN DESIGNATION TO PANEL PP1 CIRCUIT #1, WITH THE FOLLOWING CONDUIT/WIRES UNLESS OTHERWISE NOTED: <ul style="list-style-type: none"> • 3/4" WITH 2#12, 1#12GND FOR 20AMP SINGLE PHASE CIRCUITS. • 3/4" WITH 3#12, 1#12GND FOR 20AMP THREE PHASE CIRCUITS. • 3/4" WITH 2#10, 1#10GND FOR 30AMP SINGLE PHASE CIRCUITS. • 3/4" WITH 3#10, 1#10GND FOR 30AMP THREE PHASE CIRCUITS. • 3/4" WITH 2#8, 1#10GND FOR 40AMP & 50AMP SINGLE PHASE CIRCUITS. • 3/4" WITH 3#8, 1#10GND FOR 40AMP & 50AMP THREE PHASE CIRCUITS.
	EYS TYPE CONDUIT SEAL, "EX" REPRESENTS PROVIDING UL LISTED EXPLOSION PROOF SEALANT IN CONDUIT SEAL, "NEX" REPRESENTS PROVIDE ELECTRICAL SEALANT PUTTY IN CONDUIT SEAL.
	SURGE PROTECTION DEVICE
	GROUND FAULT MONITOR AND INDICATION LIGHT
	UTILITY POLE
	MOLDED CASE CIRCUIT BREAKER, 3-POLE UNLESS OTHERWISE INDICATED, "20" INDICATES TRIP AMPERE RATING, "100" INDICATES FRAME SIZE, "LSIG" LONG, SHORT, INSTANTANEOUS AND GROUND FAULT PROTECTION RESPECTIVELY
	DRY TYPE TRANSFORMER
	ELECTRIC HAND HOLE (REFER TO SITE DETAILS)
	3/4" X 10'-0" COPPER CLAD GROUND ROD
	BUILDING GROUNDING SYSTEM
	MOTOR, "10" INDICATES HORSEPOWER RATING
	CABLE/CONDUIT DESIGNATION, "XX" REFERS CABLE CONDUIT REFERENCE, REFER TO CABLE/CONDUIT SCHEDULES. "T" REFERS TO TEMPORARY WIRING
	UNLESS OTHERWISE NOTED INSTRUMENTATION OR PROCESS EQUIPMENT (SUPPLIED BY OTHER DIVISIONS) "XX-XXXX" REFERS TO TAGNAME ID
	INTRINSICALLY SAFE BARRIER PANEL (SUPPLIED BY DIV. 13)
	GENERATOR EMERGENCY STOP
	GAS DETECTION SYSTEM - AMBER ALARM BEACON (SUPPLIED BY DIV. 17)
	GAS DETECTION SYSTEM - ALARM HORN (SUPPLIED BY DIV.17)
	OCCUPIED/UNOCCUPIED SELECTOR SWITCH. (SUPPLIED BY DIV. 16)
	THERMOSTAT (SUPPLIED BY DIV. 15)
	MOTOR OPERATED DAMPER (SUPPLIED BY DIV. 15)
	ELECTRIC UNIT HEATER, "X" INDICATES UNIT ELECTRIC COIL RATING (SUPPLIED BY DIV. 15)
	EQUIPMENT CIRCUIT NUMBER DESIGNATION TO PANEL PP1-LP CIRCUIT #21.

SECURITY SYMBOLS

	MAGNETIC DOOR SWITCH
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FIRE ALARM SYSTEM SYMBOLS

	MANUAL FIRE ALARM STATION
	FIRE ALARM AUDIO/VISUAL DEVICE
	FIRE ALARM VISUAL ONLY DEVICE
	FIRE ALARM BEACON
	SMOKE DETECTOR
	DUCT SMOKE DETECTOR
	REMOTE TEST STATION AND ALARM FOR DUCT SMOKE DETECTOR
	HEAT DETECTOR, COMBINATION RATE-OF-RISE AND FIXED TEMPERATURE
	CARBON MONOXIDE DETECTOR
	INPUT MONITORING MODULE
	RELAY CONTROL MODULE
	FIRE ALARM CONTROL PANEL
	FIRE ALARM ANNUNCIATOR PANEL
	REMOTE ALARM INDICATING LIGHT
	MASTER BOX
	KEY DEPOSITORY - KNOX BOX

GENERAL NOTES

- PROVIDE CONCRETE HOUSEKEEPING PADS ON ALL FLOOR OR GRADE MOUNTED ELECTRICAL EQUIPMENT, THE FOLLOWING EQUIPMENT IS THE MINIMUM REQUIREMENT FOR HOUSEKEEPING PADS. ADDITIONAL PADS MAYBE REQUIRED BASED ON THE MOUNTING METHODS. 1.1. GENERATOR
- ALL CONDUIT AND EQUIPMENT SHALL BE INSTALLED AND GROUNDED IN ACCORDANCE WITH THE LATEST EDITION OF THE NATIONAL ELECTRICAL CODE AND APPLICABLE LOCAL CODES.
- BONDING JUMPERS, CONDUIT CLAMPS AND POINTS OF ATTACHMENT ARE NOT SHOWN ON DRAWINGS. SIZE BONDING JUMPERS IN ACCORDANCE WITH THE NATIONAL ELECTRICAL CODE. THE POINTS OF ATTACHMENT OF THE GROUND CLAMPS SHALL BE ACCESSIBLE LOCATIONS.
- EQUIPMENT & CONDUIT INSTALLATIONS ARE SHOWN DIAGRAMMATICALLY ONLY AND SHALL BE INSTALLED IN A MANNER TO PREVENT CONFLICTS WITH EQUIPMENT AND STRUCTURAL CONDITIONS. EXPOSED CONDUITS SHALL BE INSTALLED PARALLEL TO BEAMS AND WALLS.
- CONDUITS SHALL BE TERMINATED SO AS TO PERMIT NEAT CONNECTIONS TO MOTORS AND OTHER EQUIPMENT.
- NO CONDUIT SMALLER THAN 3/4" PIPE SIZE NOR WIRE SMALLER THAN NO. 12 A.W.G. SHALL BE USED UNLESS OTHERWISE NOTED.
- RECEPTABLES AND SWITCHES SHALL BE MOUNTED 45" ABOVE FINISHED FLOOR.
- THE WIRING AND BLOCK DIAGRAMS, QUANTITY AND SIZE OF WIRES AND CONDUIT REPRESENT A SUGGESTED ARRANGEMENT BASED UPON SELECTED STANDARD COMPONENTS OF ELECTRICAL AND PROCESS EQUIPMENT. MODIFICATIONS ACCEPTABLE TO THE ENGINEER MAY BE MADE BY THE CONTRACTOR TO ACCOMMODATE EQUIPMENT ACTUALLY PURCHASED. THE BASIC SEQUENCE AND METHOD OF CONTROL MUST BE MAINTAINED AS INDICATED ON THE DRAWINGS AND/OR SPECIFICATIONS.

DEMOLITION NOTES

- UNLESS OTHERWISE NOTED AS SALVAGE, ALL EXISTING ELECTRICAL SYSTEMS WITHIN HATCH MARKS (POWER, LIGHTING, LOW VOLTAGE, CONTROLS, ETC) AND ASSOCIATED EQUIPMENT IS TO BE DEMOLISHED. DISCONNECT AND DE-ENERGIZE THE EQUIPMENT. REMOVE THE EQUIPMENT TO BE DEMOLISHED OR SALVAGED PER SECTION 02050. ALL CONTROL DEVICES, CONDUIT, CABLING, BOXES, SUPPORTS, ETC, ASSOCIATED WITH THE DEMOLISHED EQUIPMENT SHALL BE REMOVED. THE CONDUIT AND CABLING SHALL BE REMOVED BACK TO SOURCE.
- NO DEVICE OR EQUIPMENT INDICATED FOR DEMOLITION WILL BE REUSED OR SALVAGED UNLESS SPECIFICALLY NOTED AS SUCH. ALL EQUIPMENT REMOVED SHALL BE REMOVED FROM SITE AND PROPERLY DISPOSED OF. PRIOR TO REMOVAL OF EQUIPMENT COORDINATE WITH OWNER FOR ANY EQUIPMENT THE OWNER WILL KEEP.
- EXISTING EQUIPMENT INDICATED ON THE DEMOLITION PLANS ARE BASED ON SITE OBSERVATIONS AND IT IS NOT THE INTENTION OF THESE DRAWINGS TO SHOW ALL EQUIPMENT AND MATERIALS TO BE DISCONNECTED AND/OR REMOVED.
- THE EXISTING CONVENTIONAL FIRE ALARM SYSTEM INDICATED TO BE DEMOLISHED SHALL REMAIN COMPLETE AND IN FUNCTION UNTIL THE NEW FIRE ALARM SYSTEM IS INSTALLED, TESTED, AND ACCEPTED BY THE FIRE DEPARTMENT.

ABBREVIATIONS


(2)1" C, 3#8, #10GND	2, 1-INCH CONDUITS EACH CONDUIT CONTAINING 3-#8 AWG WIRES AND 1-#10 GROUND CONDUCTOR
3/4" CE	EMPTY CONDUIT. NUMERAL DENOTES SIZE
ABL	ALARM BEACON LIGHT
AFF	ABOVE FINISHED FLOOR
AFG	ABOVE FINISHED GRADE
AR	ALARM RELAY
ATS	AUTOMATIC TRANSFER SWITCH
CR	CONTROL RELAY
CP	CONTROL PANEL
DRG. DWG.	DRAWING
EA	EXCEPT AS NOTED
EC	ELECTRICAL CONTRACTOR
ETM	ELAPSED TIME METER
FE	FLOW ELEMENT
FIT	FLOW INDICATOR TRANSMITTER
FS	FLOW SWITCH
FT	FLOW TRANSMITTER
FVNR	FULL VOLTAGE NON-REVERSING
GND, GRD	GROUNDING CONDUCTOR (EQUIPMENT)
HO	HAND-OFF SELECTOR SWITCH
HOA	HAND-OFF-AUTOMATIC SELECTOR SWITCH
HH	HANDHOLE
ISBP	INTRINSICALLY SAFE BARRIER PANEL
J OR JB	JUNCTION BOX
JPB	JOG PUSHBUTTON
LE	LEVEL ELEMENT
LIT	LEVEL INDICATOR TRANSMITTER
LL	LOW LEVEL
LSX	LEVEL SWITCH, X = "H" FOR HIGH, "L" FOR LOW
LT	LEVEL TRANSMITTER
MC	MOTOR CONTROLLER (STARTER)
MCC	MOTOR CONTROL CENTER
MH	MANHOLE
MFR	MANUFACTURER
MS	MOTION SENSOR
NTS	NOT TO SCALE
OEM	ORIGINAL EQUIPMENT MANUFACTURE SUPPLIED
OH	OVERHEAD
OL	MOTOR OVERLOAD HEATER
OS	OPERATOR STATION
PB	PUSHBUTTON CONTROL STATION MOMENTARY CONTACT TYPE, STOP-START
PBE	PUSHBUTTON CONTROL STATION MAINTAINED EMERGENCY STOP TYPE, TWIST TO RELEASE
PBL	PUSHBUTTON CONTROL STATION MOMENTARY TYPE WITH LOCK-OUT DEVICE, STOP-START
PBM	SELECTOR SWITCH CONTROL STATION, CONTACT TYPE, HAND-OFF
PIT	PRESSURE INDICATOR TRANSMITTER
PL	PUSHBUTTON CONTROL STATION MOMENTARY TYPE WITH LOCK-OUT DEVICE, STOP
PSH	PRESSURE SWITCH HIGH
PSL	PRESSURE SWITCH LOW
PT	PRESSURE TRANSMITTER
RGS	RIGID GALVANIZED STEEL
RVNR	REDUCED VOLTAGE NON-REVERSING
SPD	SURGE SUPPRESSOR DEVICE
SOV	SOLENOID VALVE
S/S	SOFT STARTER
TB	TERMINAL BOX
TD	MOTOR TEMPERATURE DETECTOR
TR	TIMING RELAY
TS	TEMPERATURE SWITCH
TSP	TWISTED SHIELDED PAIR
TSTW	TWO SPEED TWO WINDING
TYP	TYPICAL
UG	UNDERGROUND
UNO	UNLESS OTHERWISE NOTED
VFD	VARIABLE FREQUENCY DRIVE
WP	WATER PROOF
WSH	TORQUE SWITCH HIGH
XFMR	TRANSFORMER
XS	LIMIT SWITCH

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PROJECT

BURRILLVILLE WWTF HEADWORKS & OAKLAND PUMP STATION IMPROVEMENTS


BURRILLVILLE, RI

TITLE

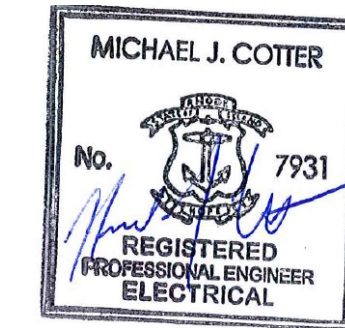
Electrical Legend and Notes

NO.	REVISIONS	DATE


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DESIGNED BY:	RLB
CHECKED BY:	MC
ISSUE DATE:	MAY 2023
BETA JOB NO.:	6861-105
SCALE	NONE
UNLESS OTHERWISE NOTED OR CHANGED BY REPRODUCTION	
SHEET NO.	E-0.1

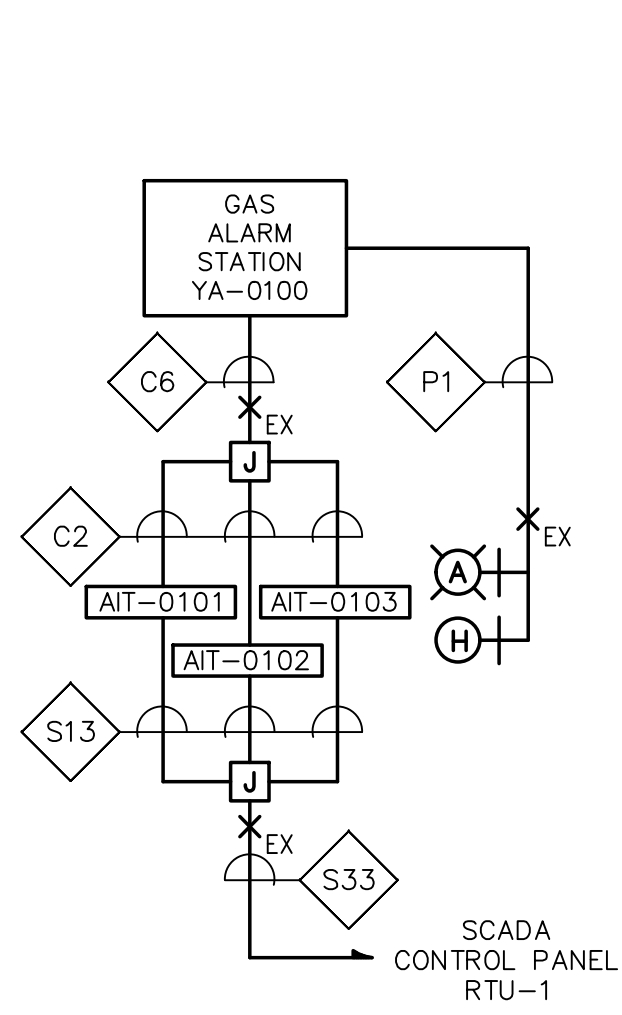


CONTROL BLOCK WIRING DIAGRAM
GAS DETECTION SYSTEM
 NOT TO SCALE

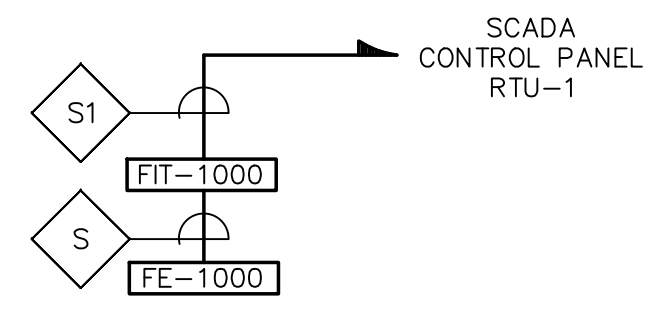


CONTROL BLOCK WIRING DIAGRAM
INFLUENT FLOW METER
 NOT TO SCALE

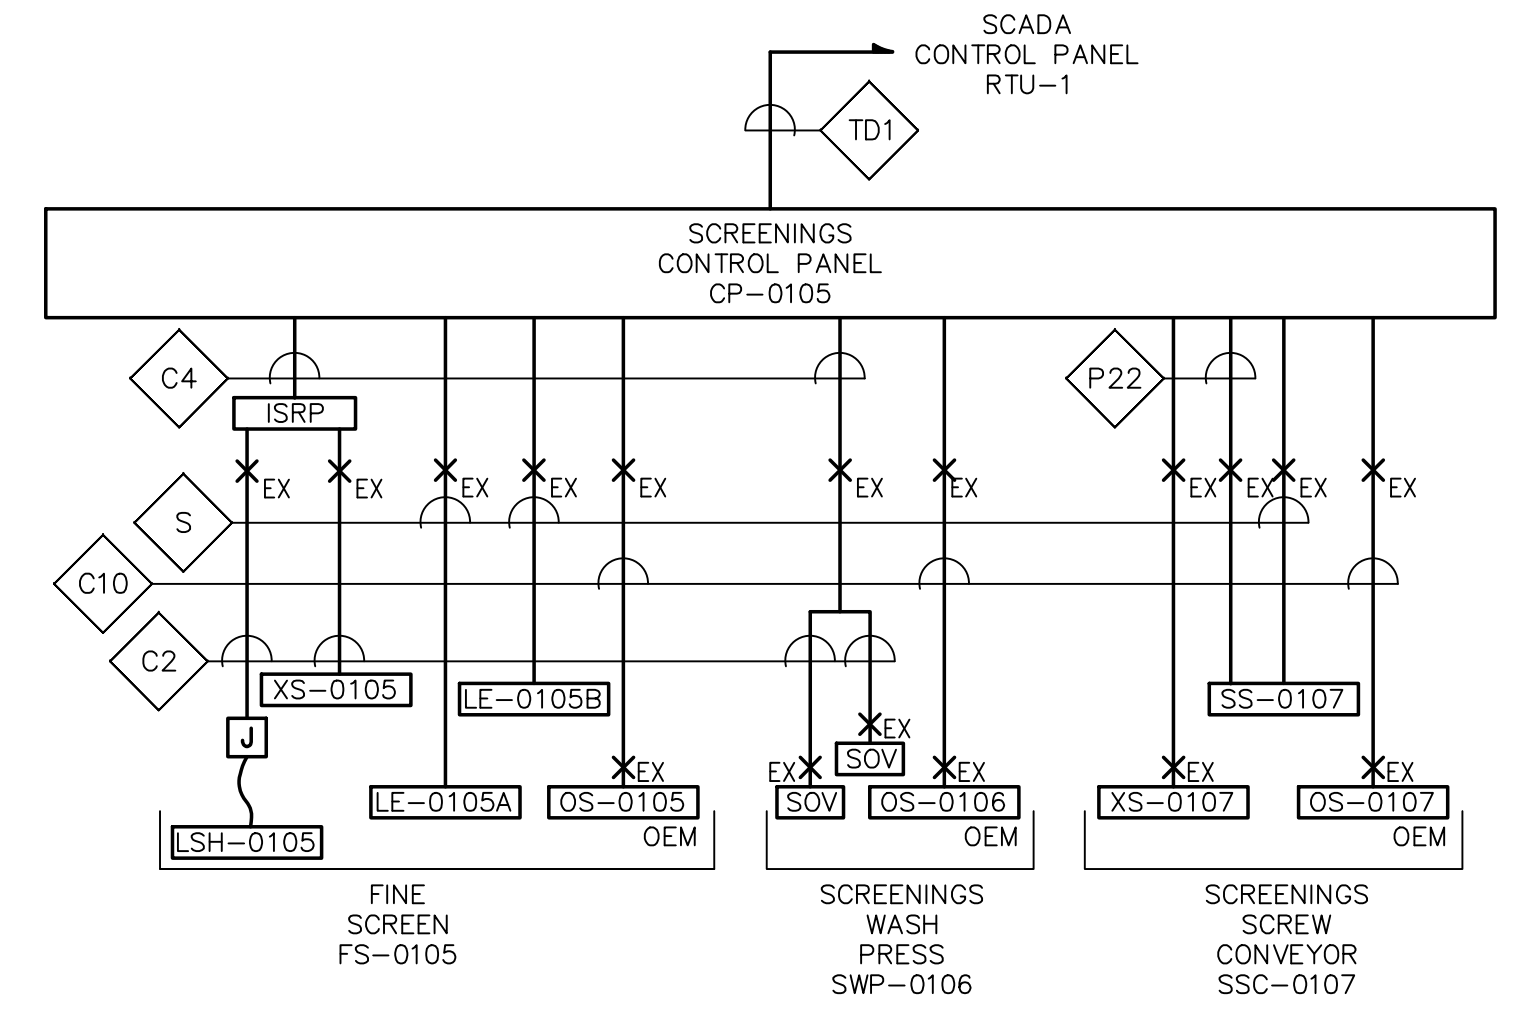


CONTROL BLOCK WIRING DIAGRAM
HEAD WORKS SCREENINGS
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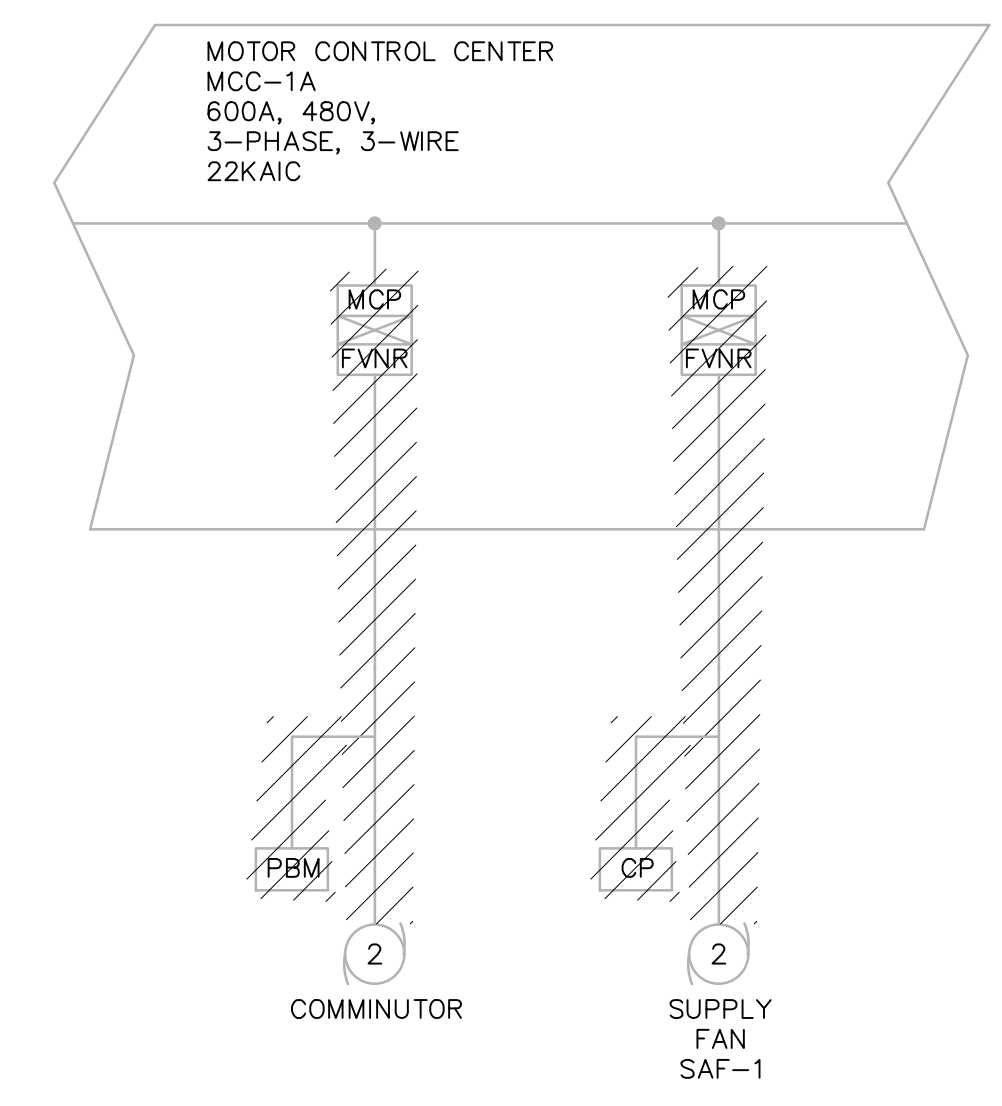
CONTROL BLOCK WIRING DIAGRAM
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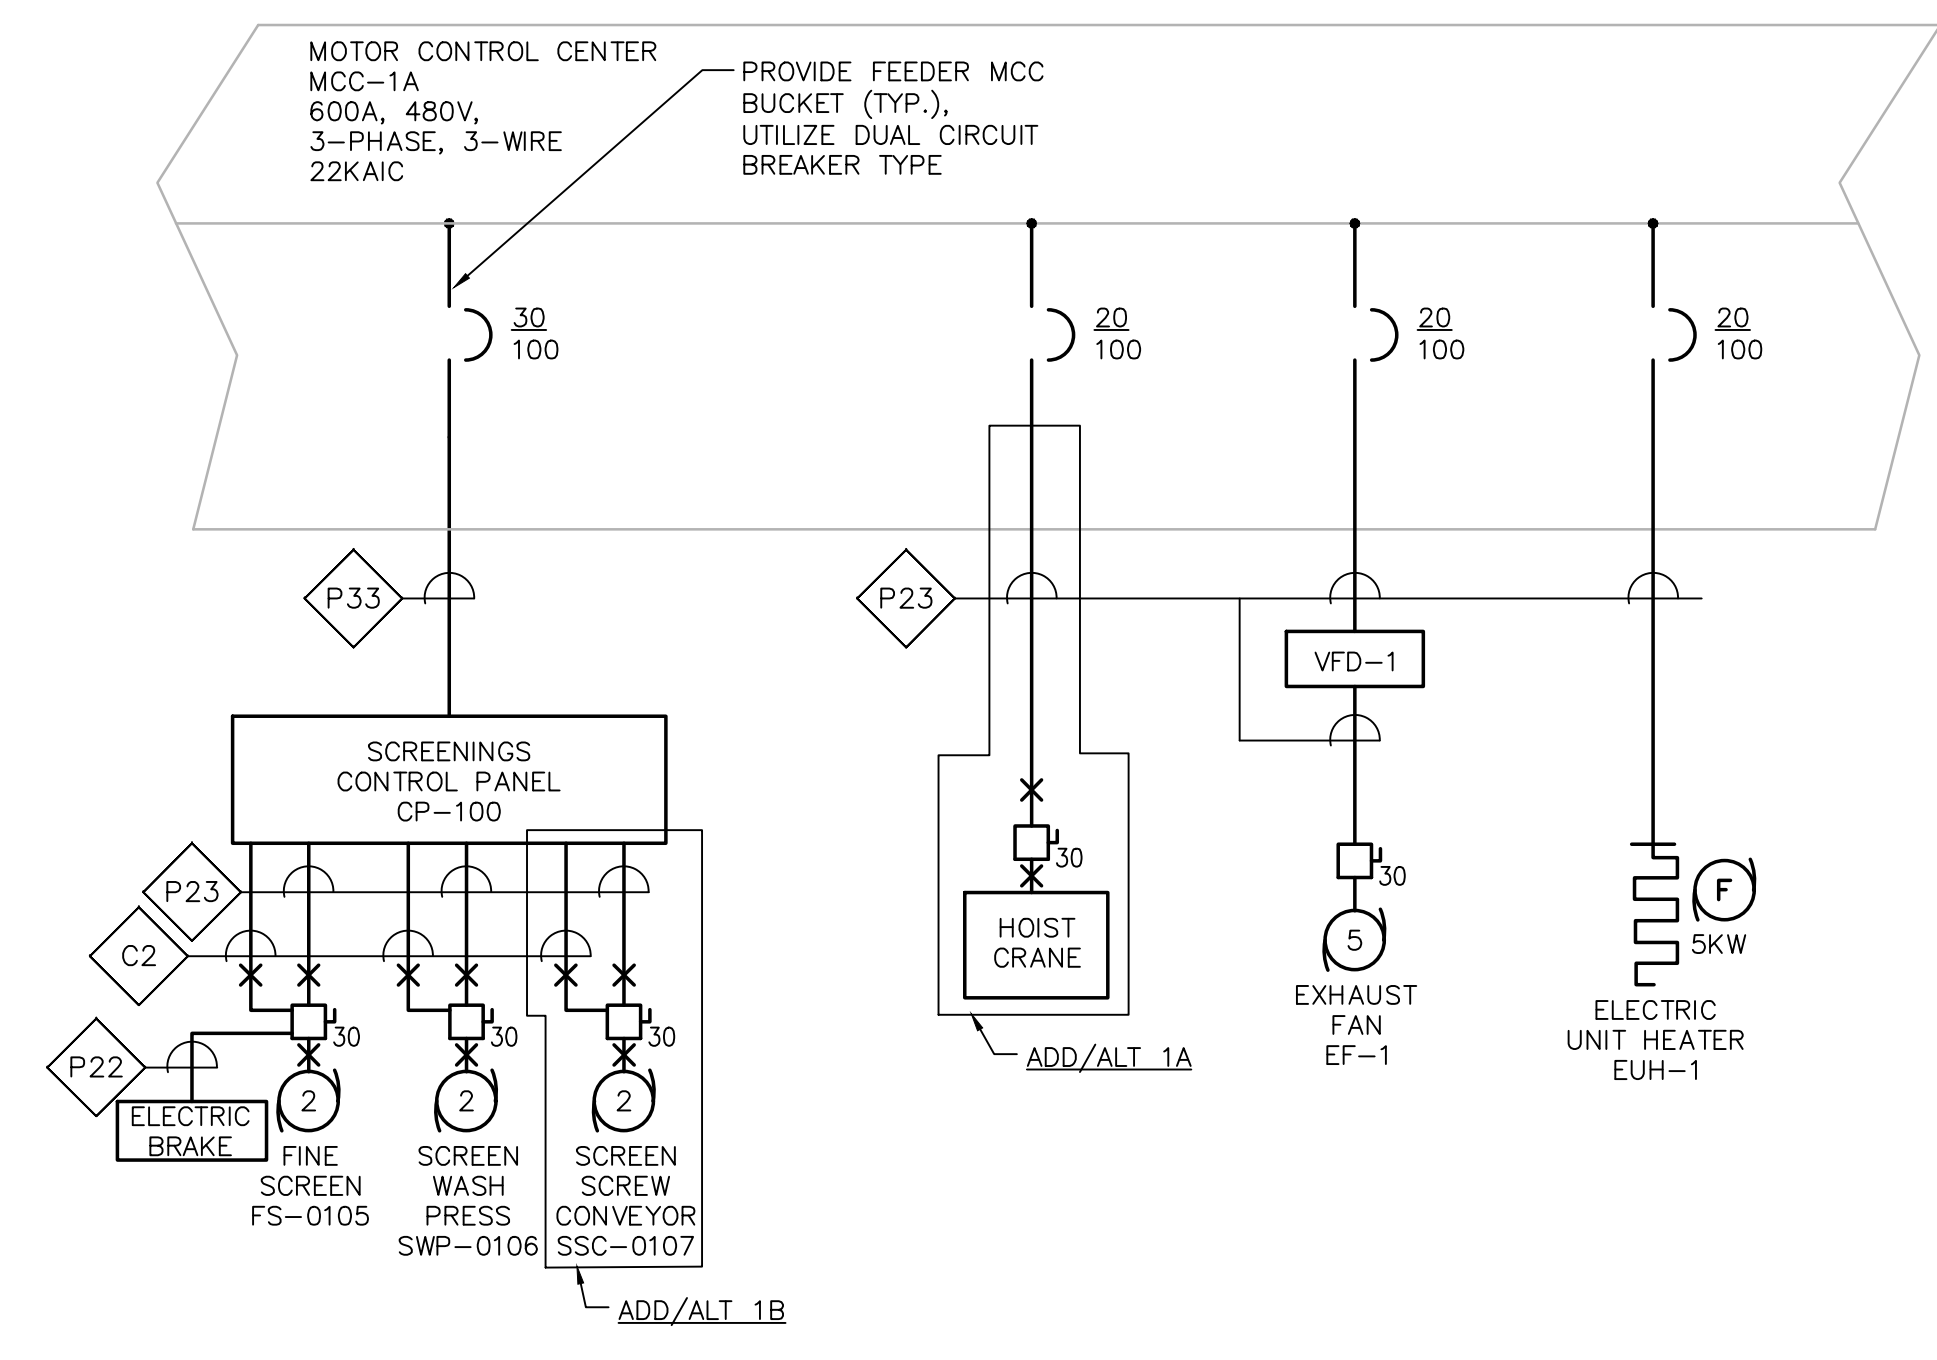
CONTROL BLOCK WIRING DIAGRAM
EXHAUST FAN EF-1
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HEADWORKS LIGHT SWITCHING
WIRING DIAGRAM
 NOT TO SCALE

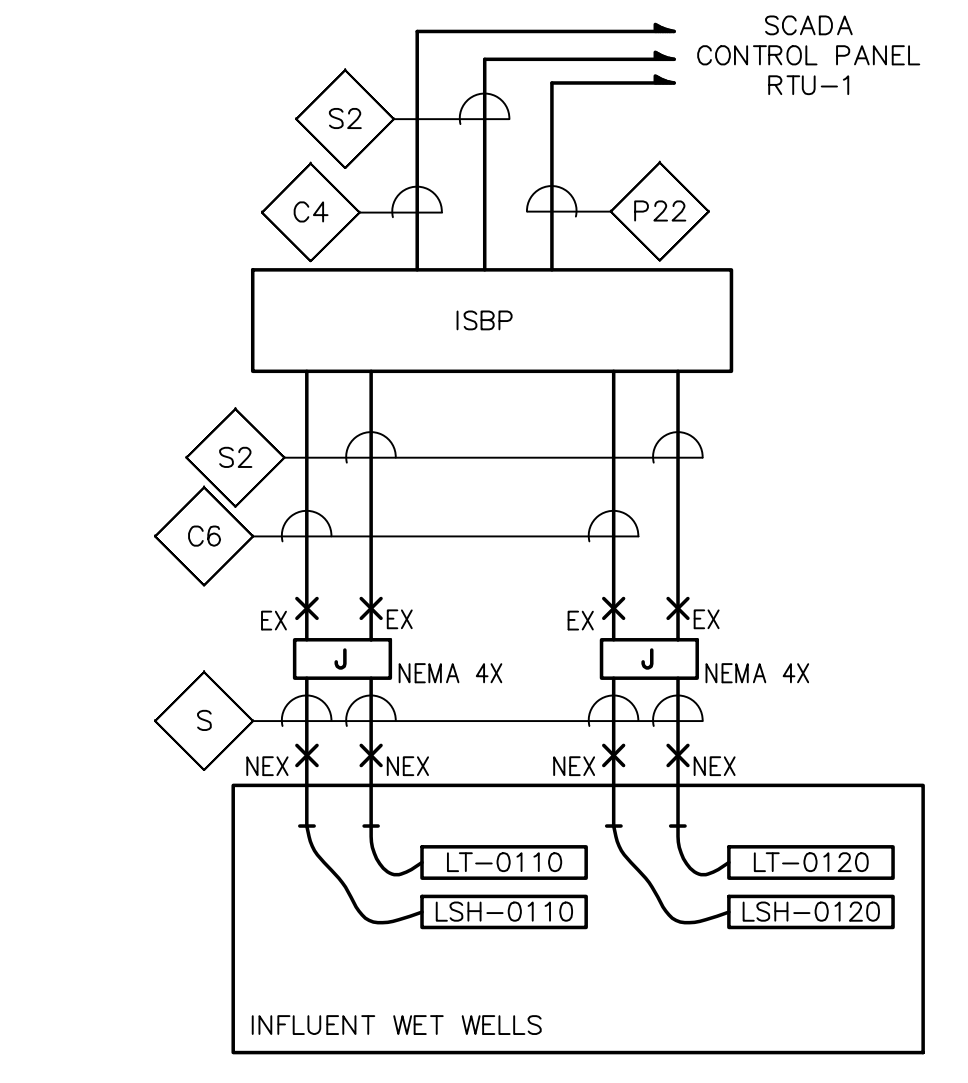

OPERATIONS BUILDING DEMOLITION ONE LINE DIAGRAM
 NOT TO SCALE

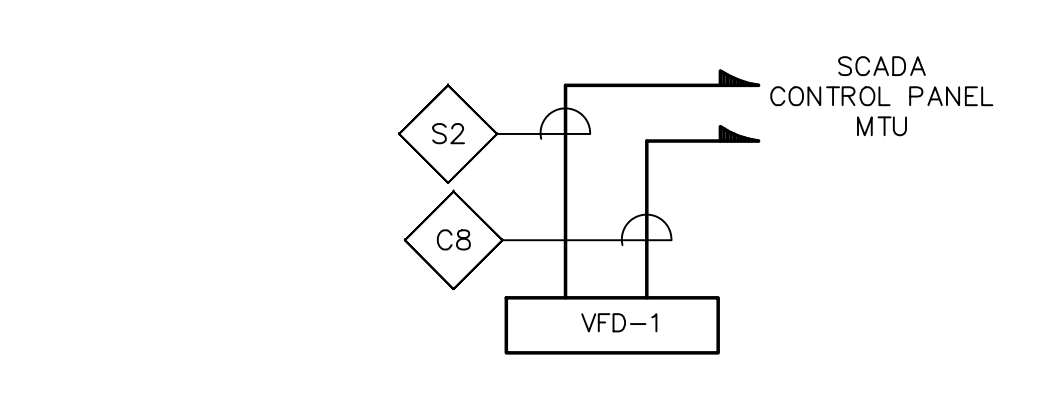


OPERATIONS BUILDING ONE LINE DIAGRAM
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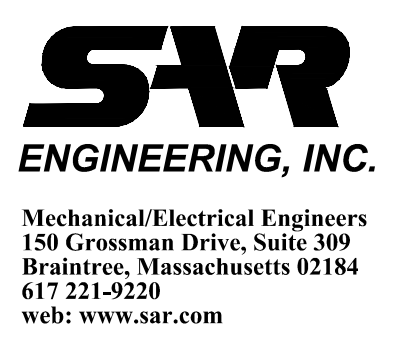
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PROJECT

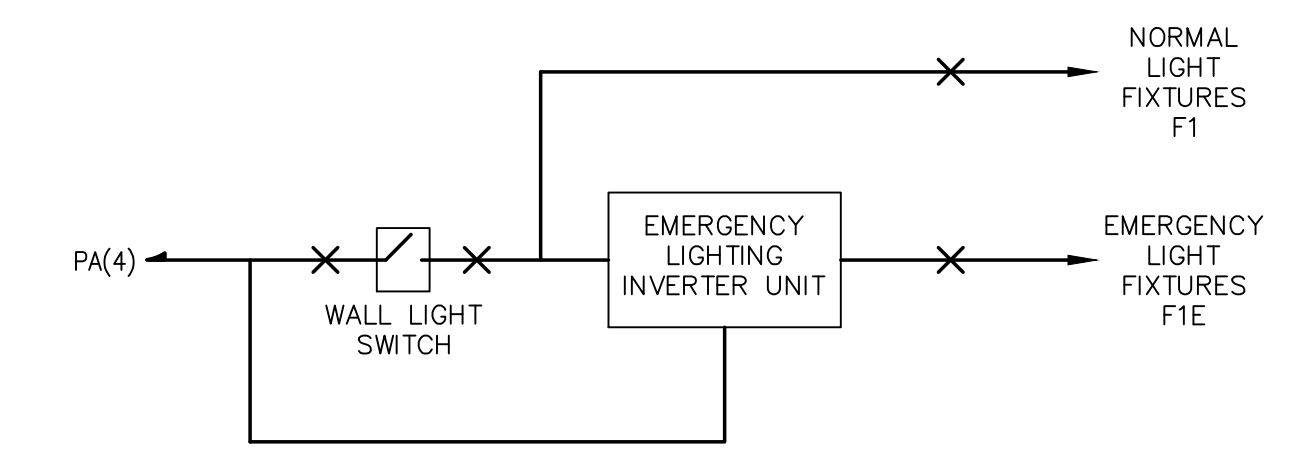BURRILLVILLE WWTF
HEADWORKS &
OAKLAND PUMP
STATION
IMPROVEMENTS

BURRILLVILLE, RI

TITLE

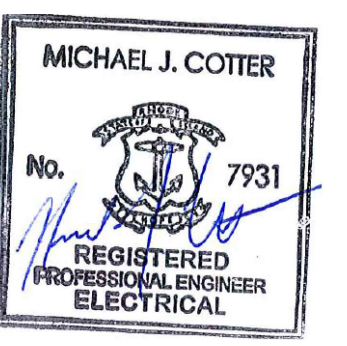WWTF
HEADWORKS
 Electrical One Line
 and Wiring
 Diagrams

NO.	REVISIONS	DATE

DRAWN BY:	RLB
DESIGNED BY:	RLB
CHECKED BY:	MC
ISSUE DATE:	MAY 2023
BETA JOB NO.:	6861-105


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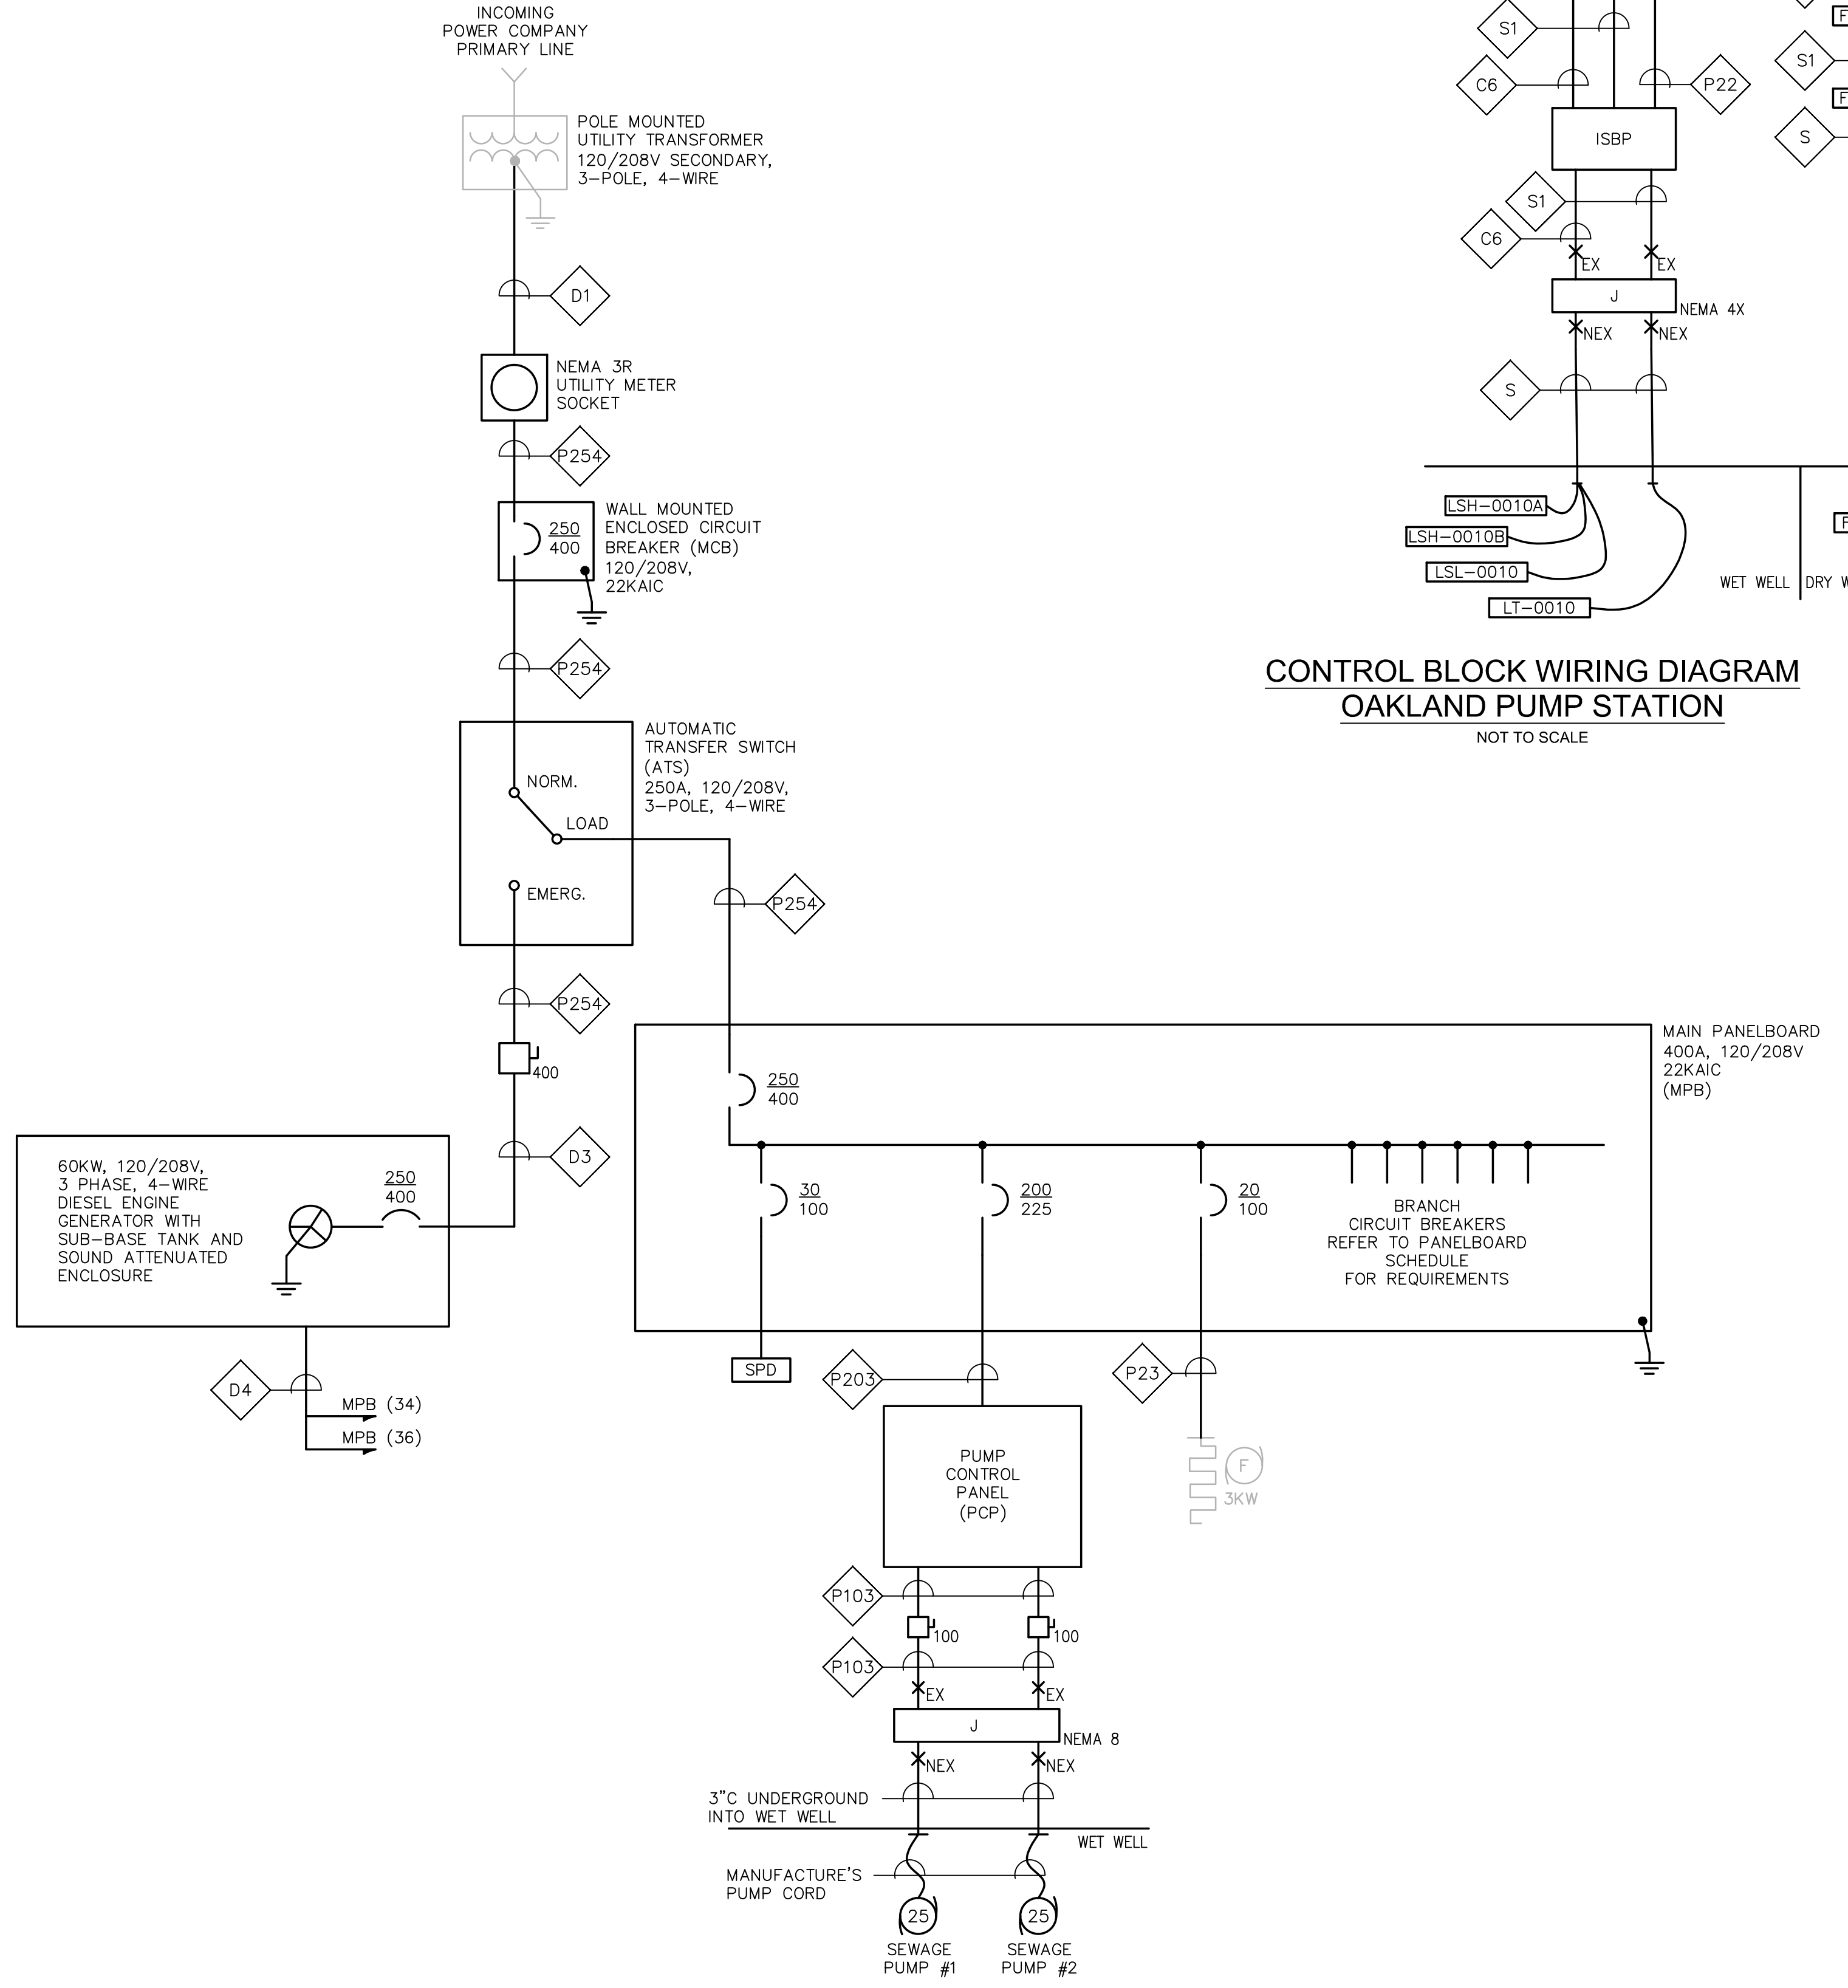
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SHEET NO.


E-0.2



OAKLAND PUMP STATION DEMOLITION ONE LINE DIAGRAM
NOT TO SCALE

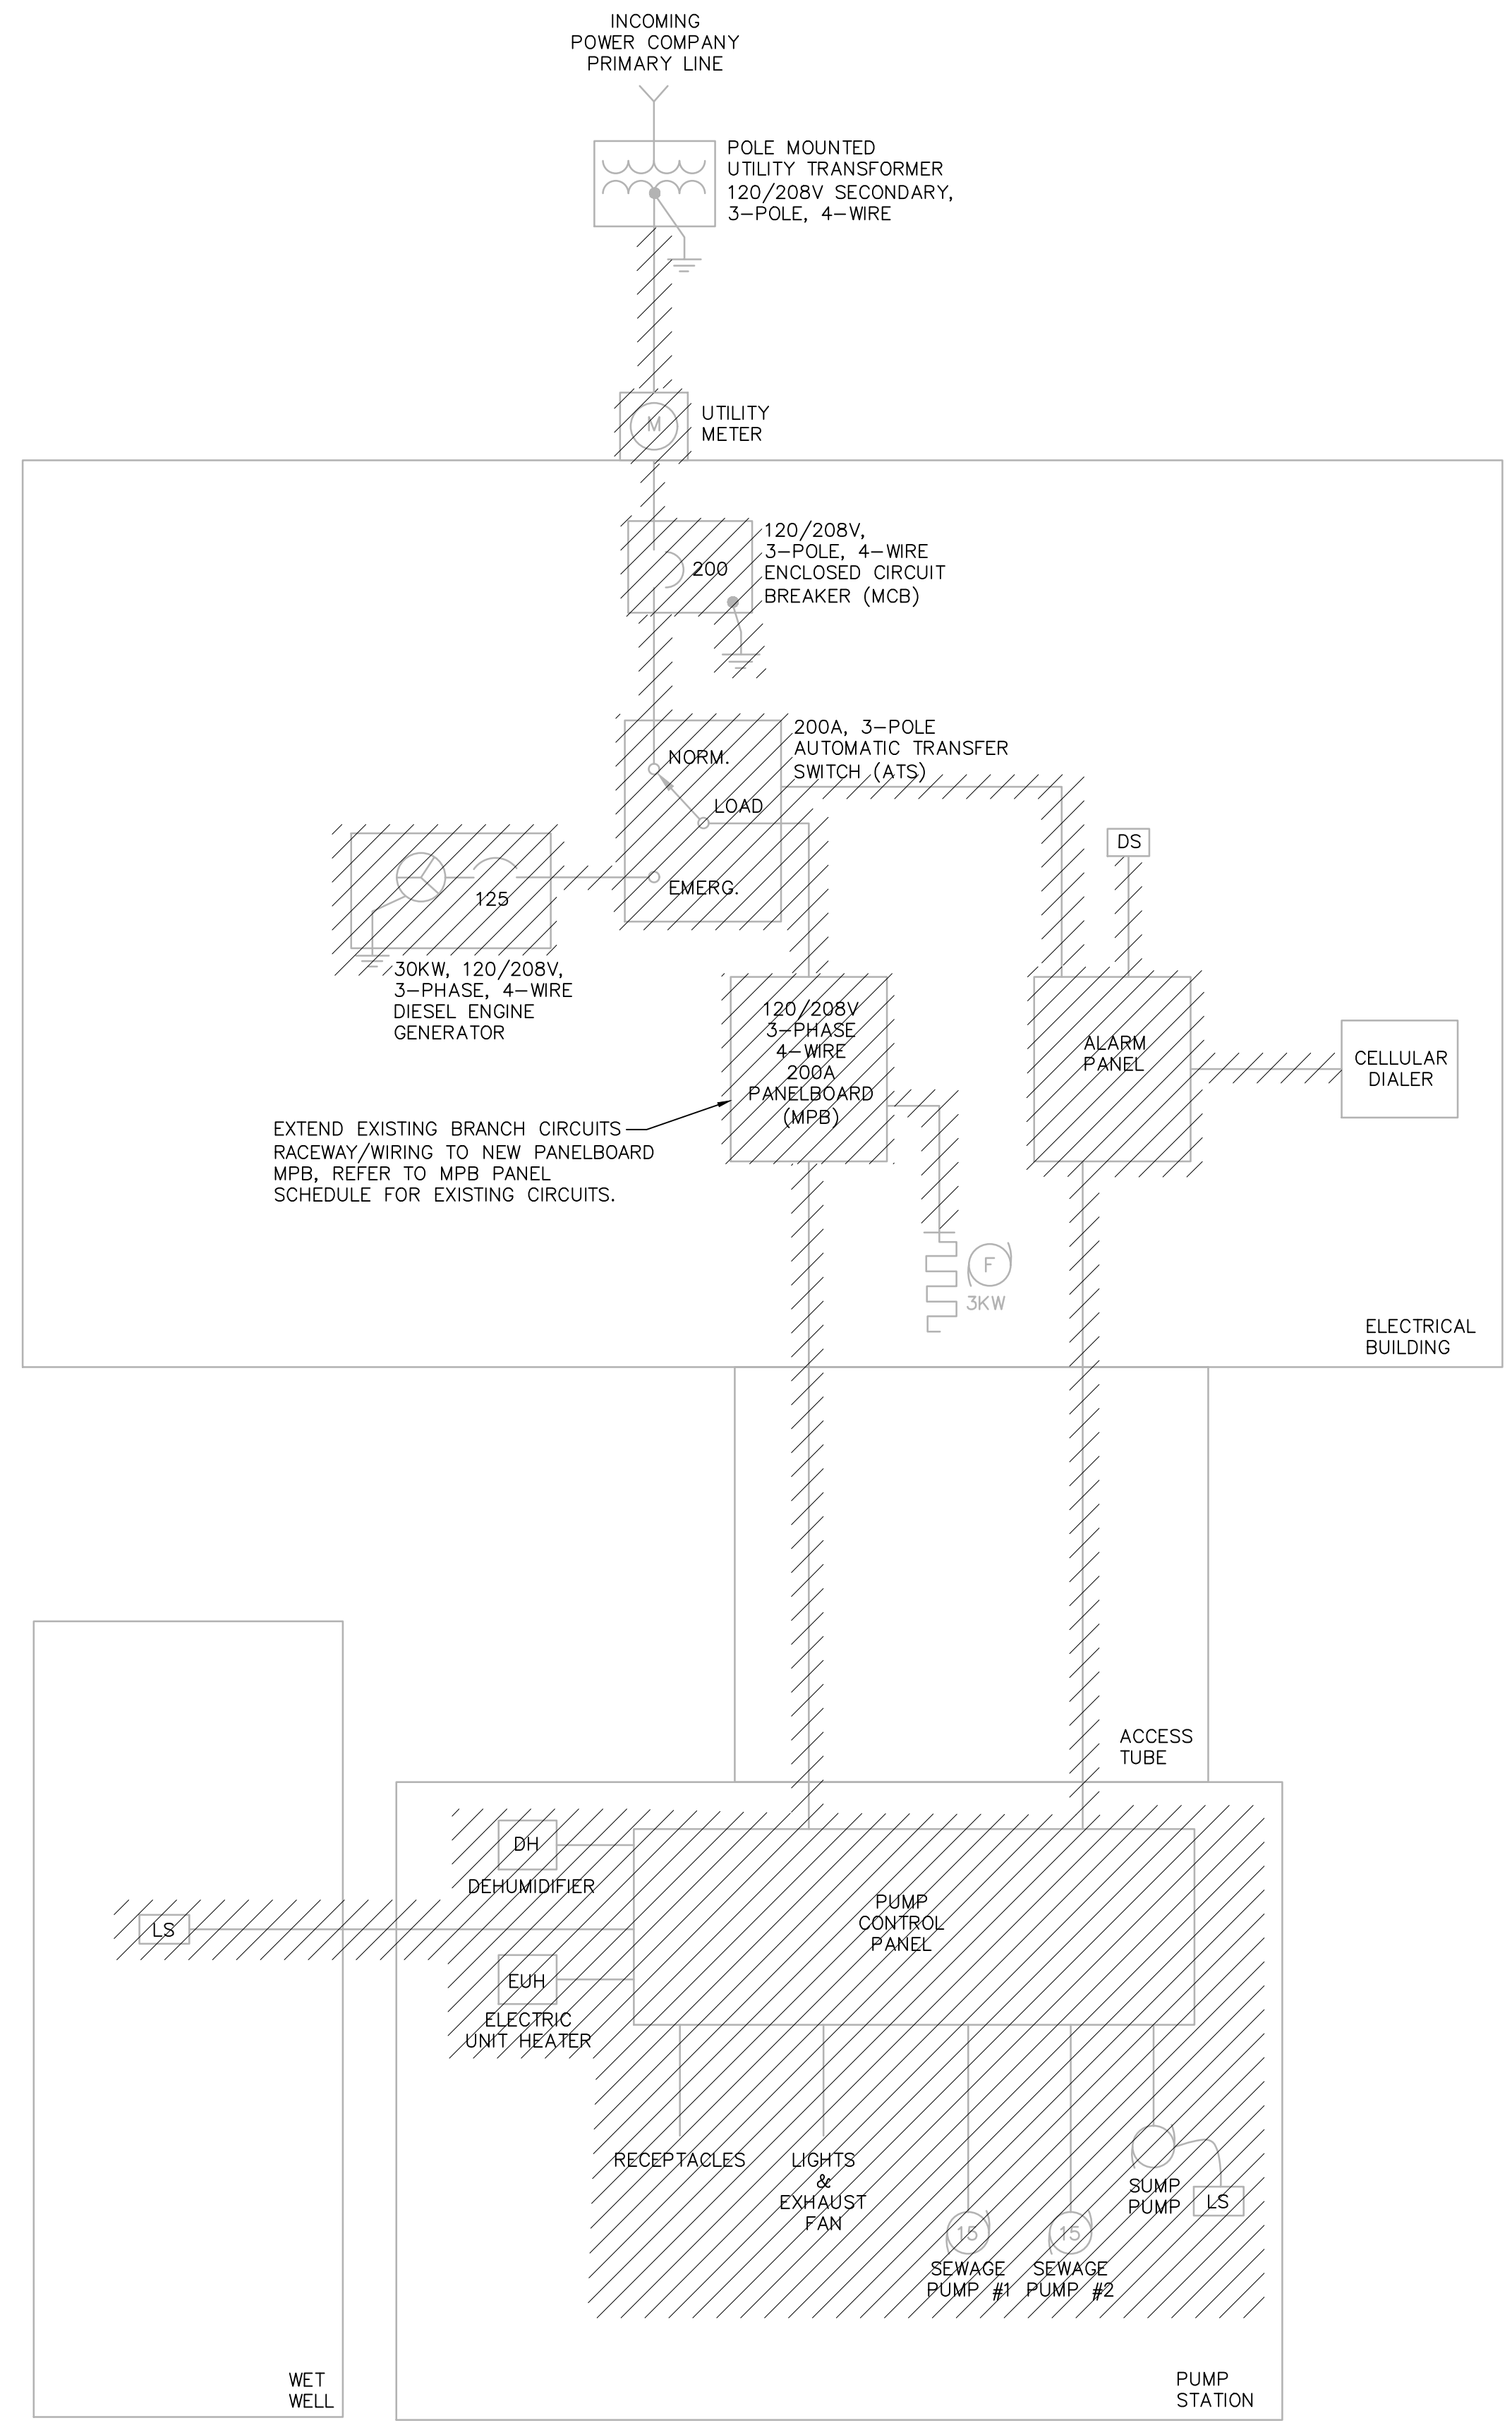




OAKLAND PUMP STATION ONE LINE DIAGRAM
NOT TO SCALE

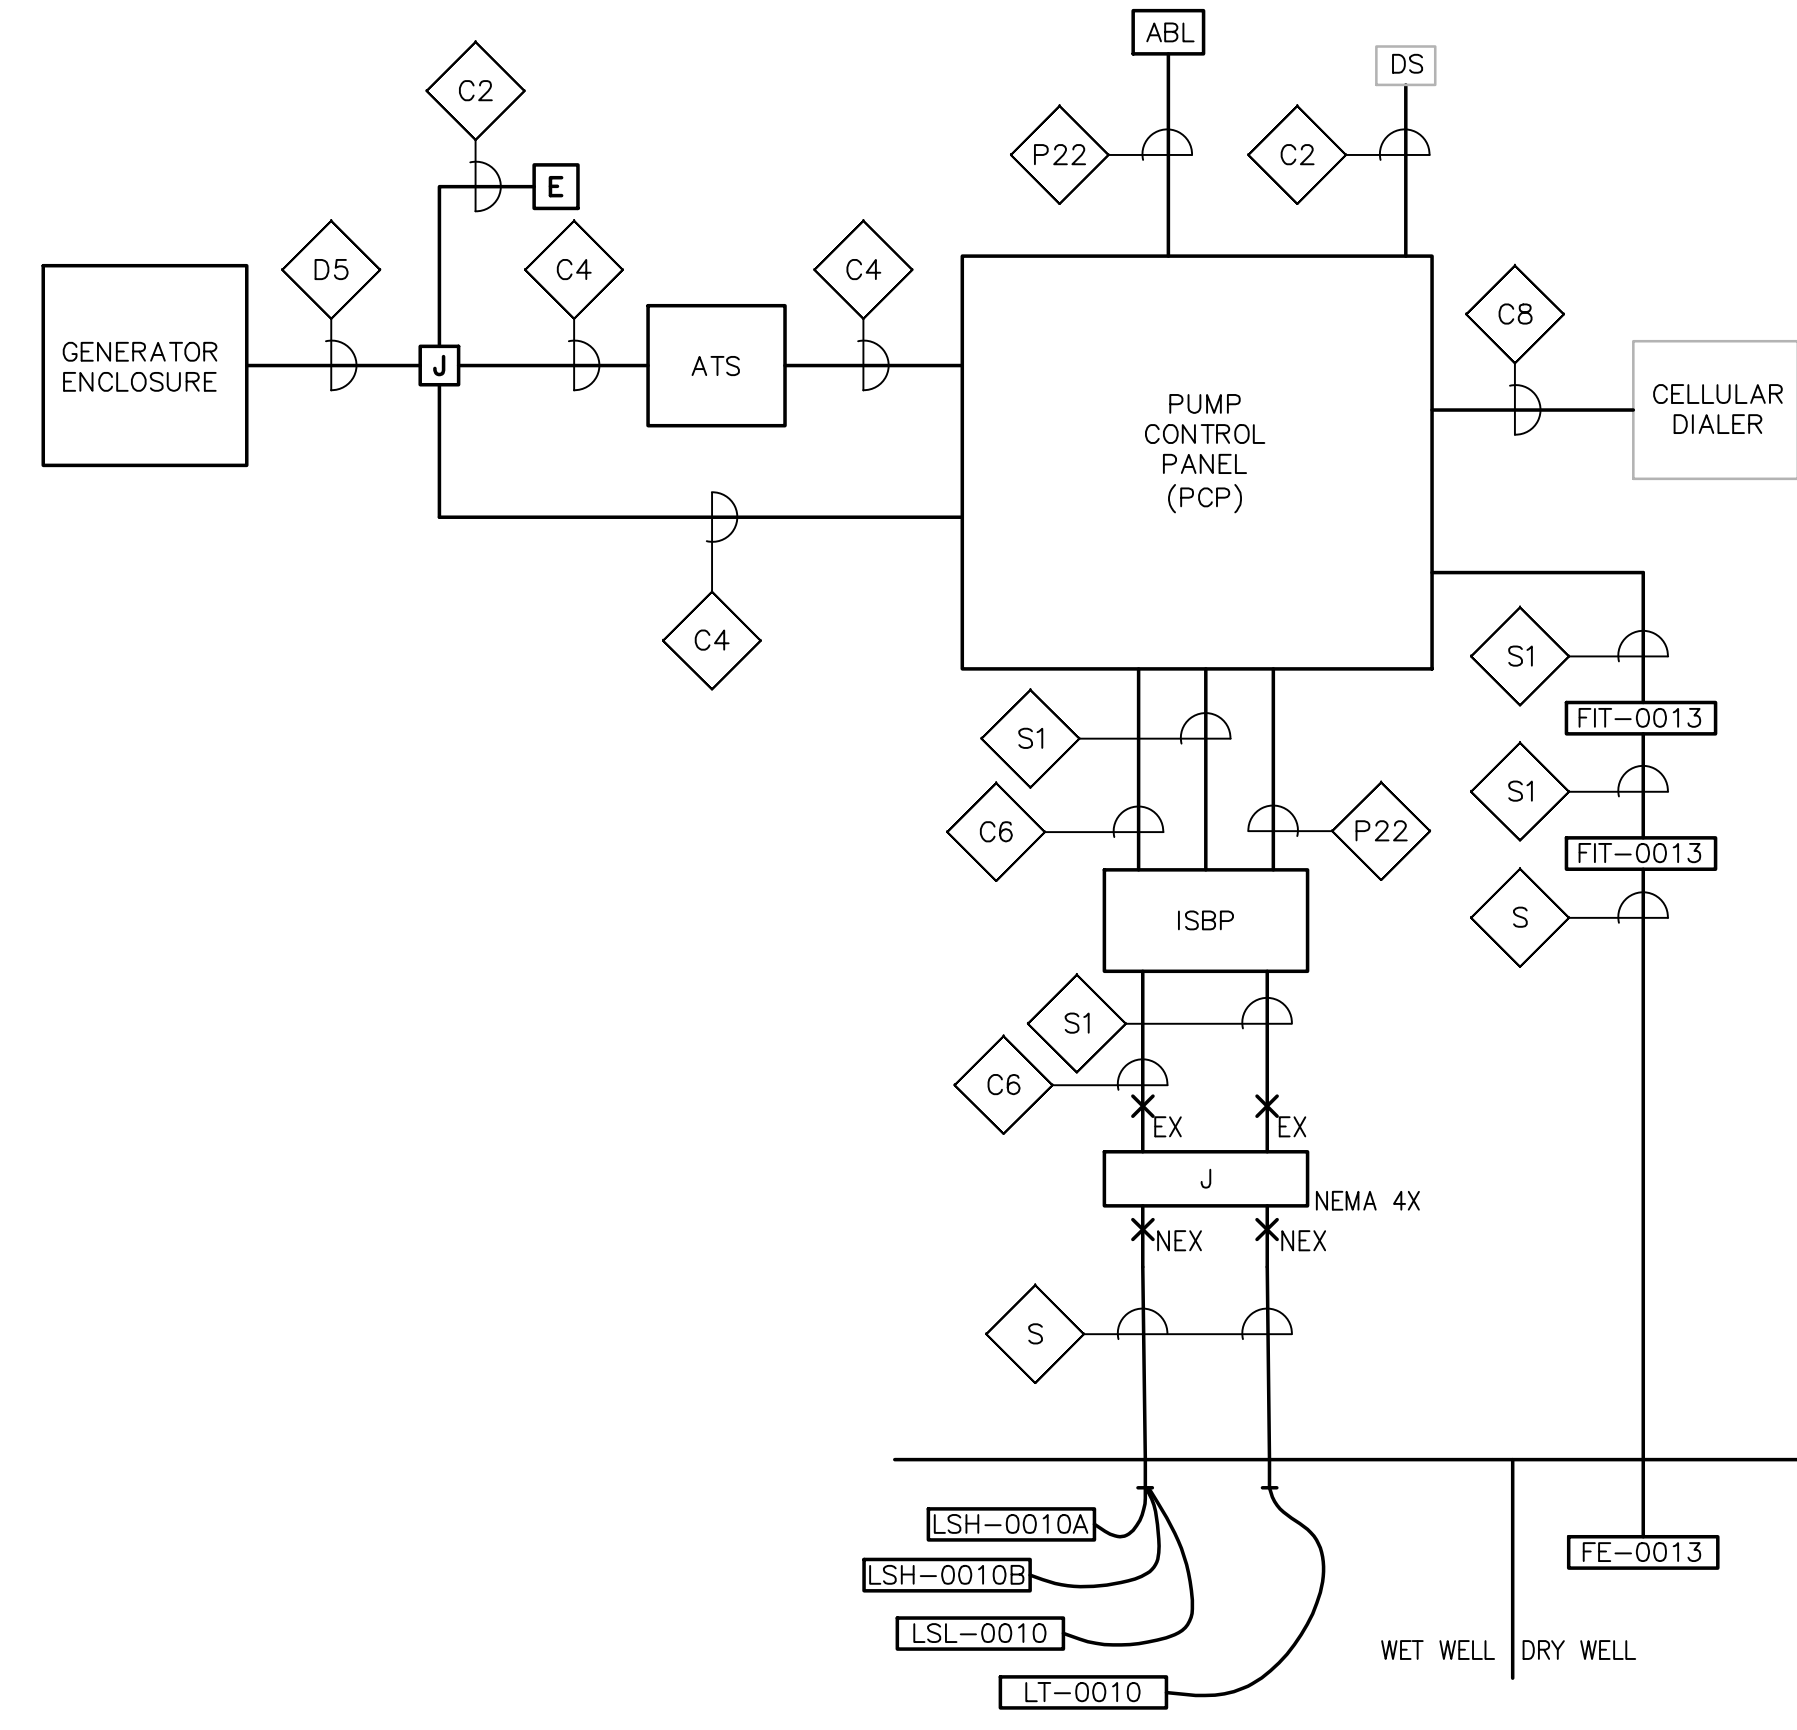

CONTROL BLOCK WIRING DIAGRAM
OAKLAND PUMP STATION
NOT TO SCALE

NO.	REVISIONS	DATE



DRAWN BY:	RLB
DESIGNED BY:	RLB
CHECKED BY:	MC
ISSUE DATE:	MAY 2023
BETA JOB NO.:	6861-105

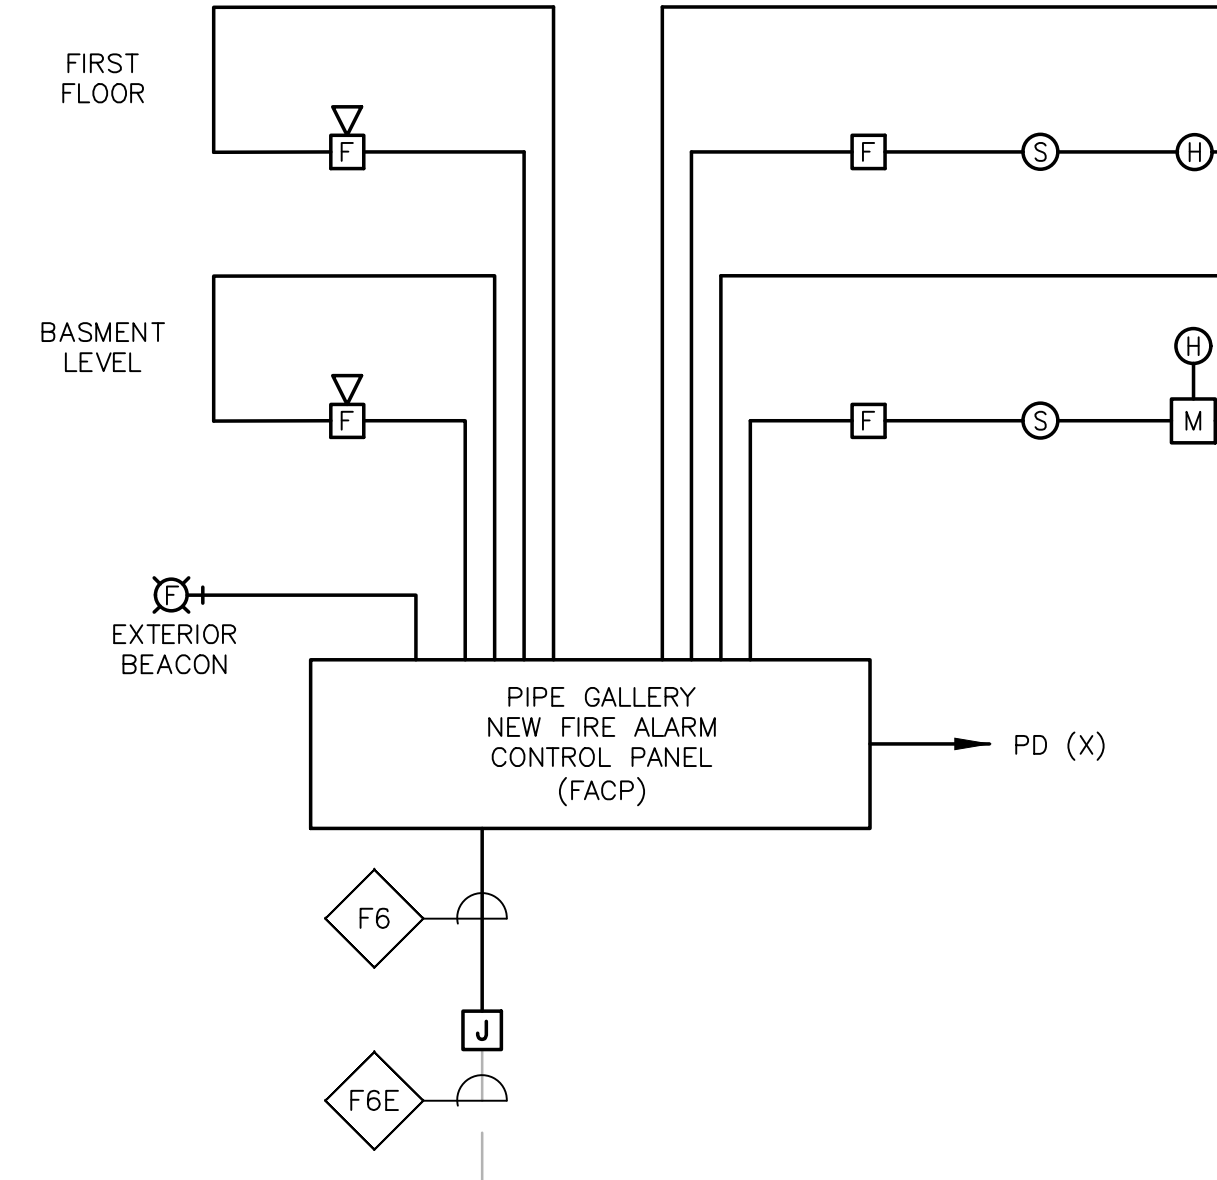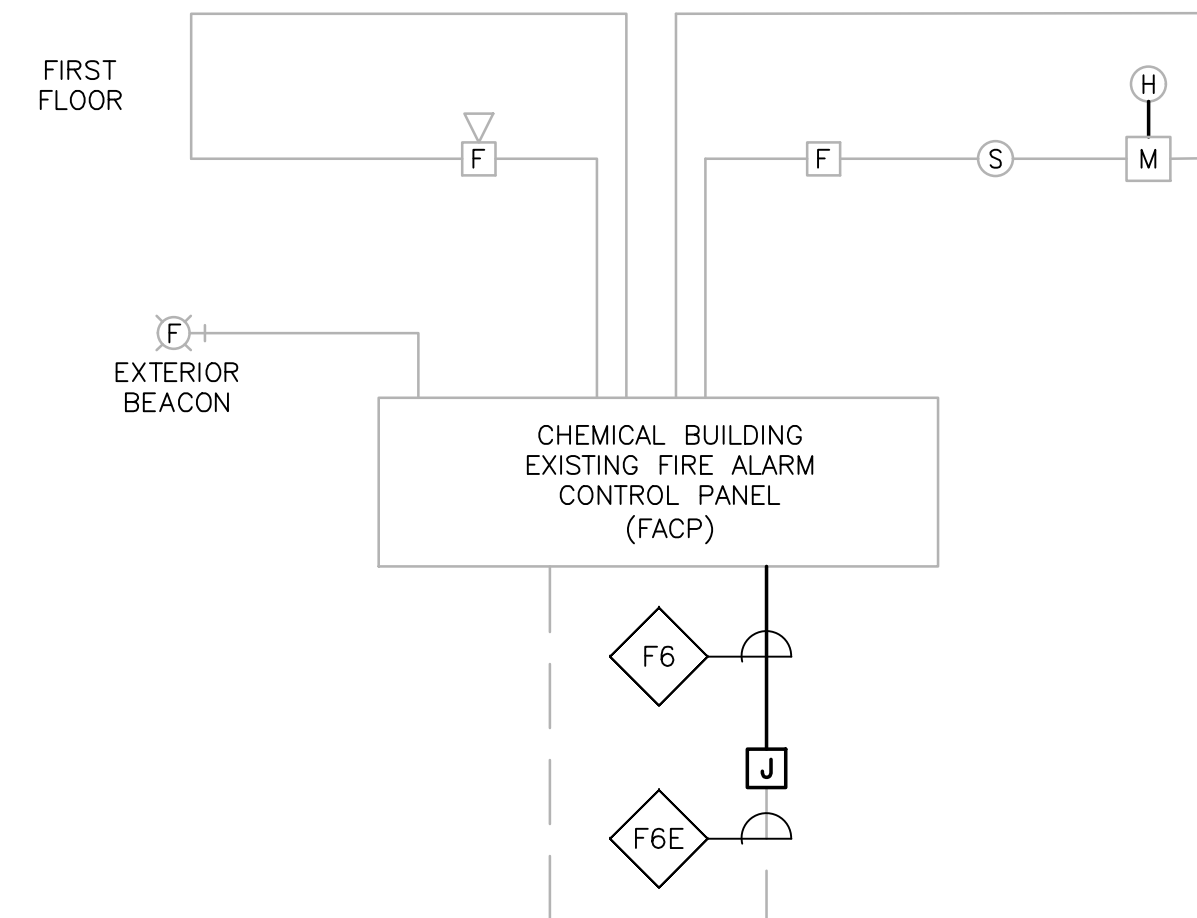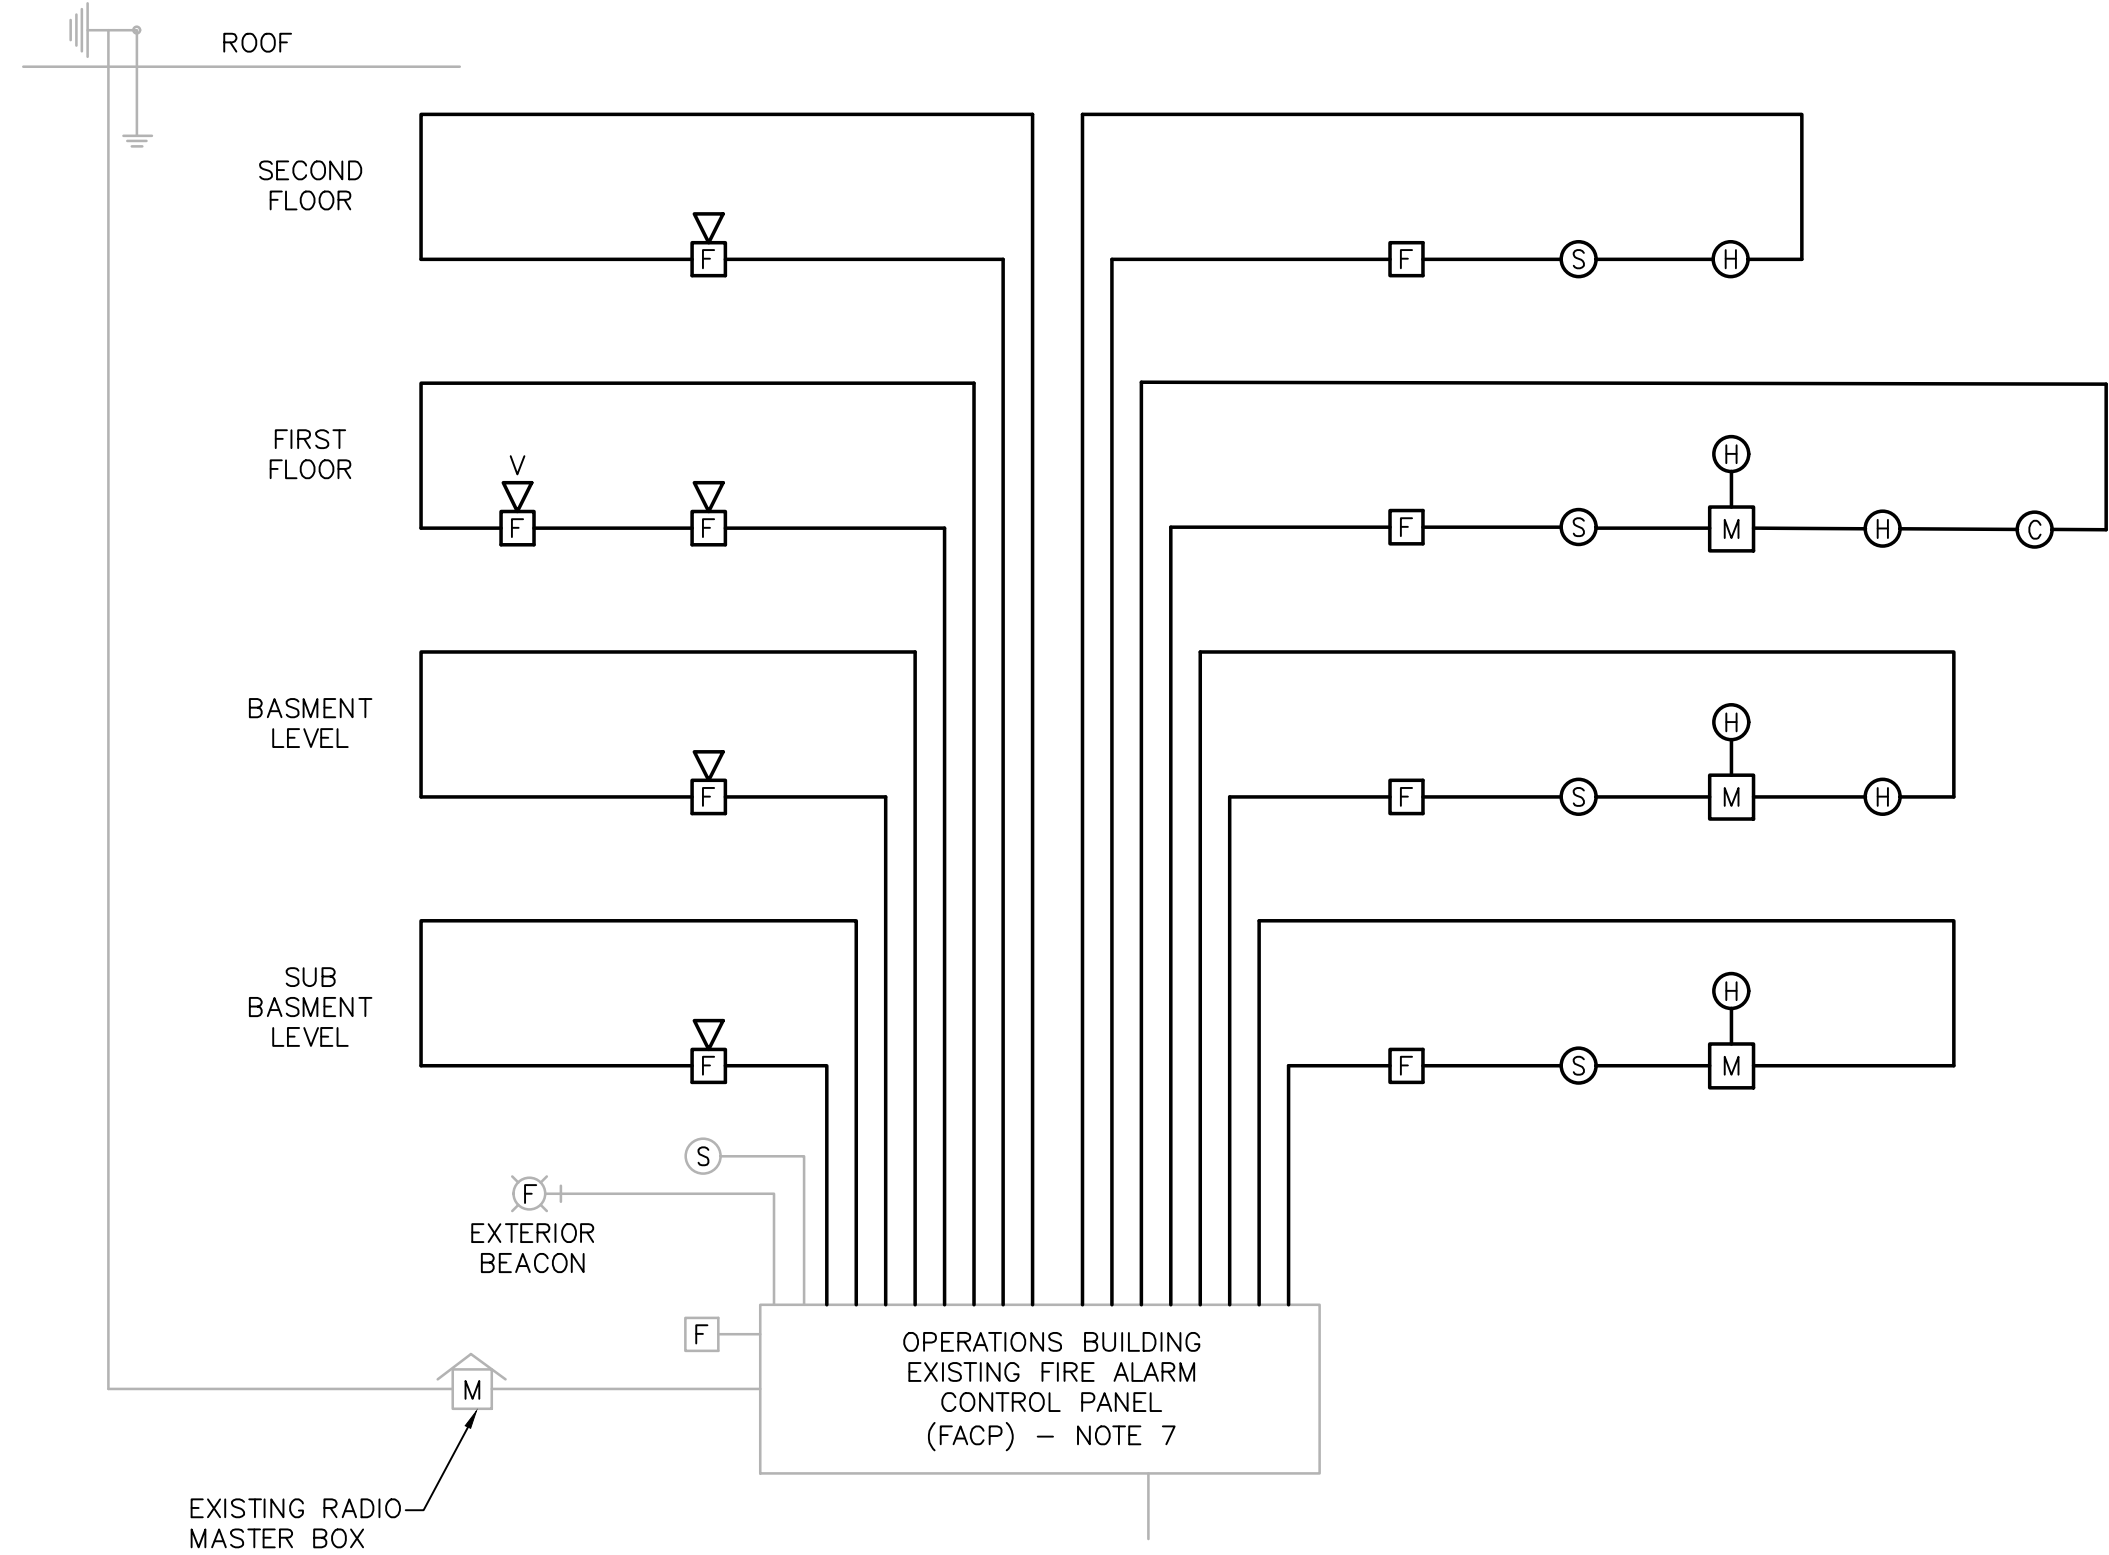

FIRE ALARM NOTES:

1. RISER DIAGRAMS ONLY REPRESENTS TYPE OF DEVICES WITHIN AN AREA AND DOES NOT REPRESENT ACTUAL QUANTITIES. REFER TO PLAN DRAWINGS FOR EXACT QUANTITIES AND LOCATIONS OF DEVICES.
2. MINIMUM SIZE CONDUIT SHALL BE 3/4" UNLESS NOTED OTHERWISE.
3. SYSTEM CONDUIT/CABLING SHALL BE INSTALLED IN ACCORDANCE WITH EQUIPMENT SUPPLIERS APPROVED SHOP DRAWINGS AND WIRING DIAGRAMS.
4. PROVIDE RED COLORED CIRCUIT BREAKER HANDLE LOCK ON POWER CIRCUIT. HANDLE LOCK SHALL ALLOW THE CIRCUIT BREAKER TO TRIP, BUT PREVENT SWITCHING OF THE CIRCUIT BREAKER TO THE "OFF" POSITION.
5. ALL COMPONENTS OF THE SYSTEM SHALL BE MOUNTED IN ACCORDANCE WITH ADA REQUIREMENTS.
6. THE FIRE ALARM SYSTEM SHALL BE ADDRESSABLE TYPE. CONTRACTOR TO PROVIDE THE NECESSARY INTERFACE MODULES FOR THE FIRE ALARM DEVICES THAT REQUIRES THEM.
7. THE EXISTING (2) 40 AMP-HOUR BATTERIES ARE TO BE REPLACED WITH NEW HIGHER AMP-HOUR CAPACITY BATTERIES BASED ON SYSTEM DEVICES WITHIN THE OPERATIONS BUILDING.

FIRE ALARM RISER DIAGRAM
NOT TO SCALE

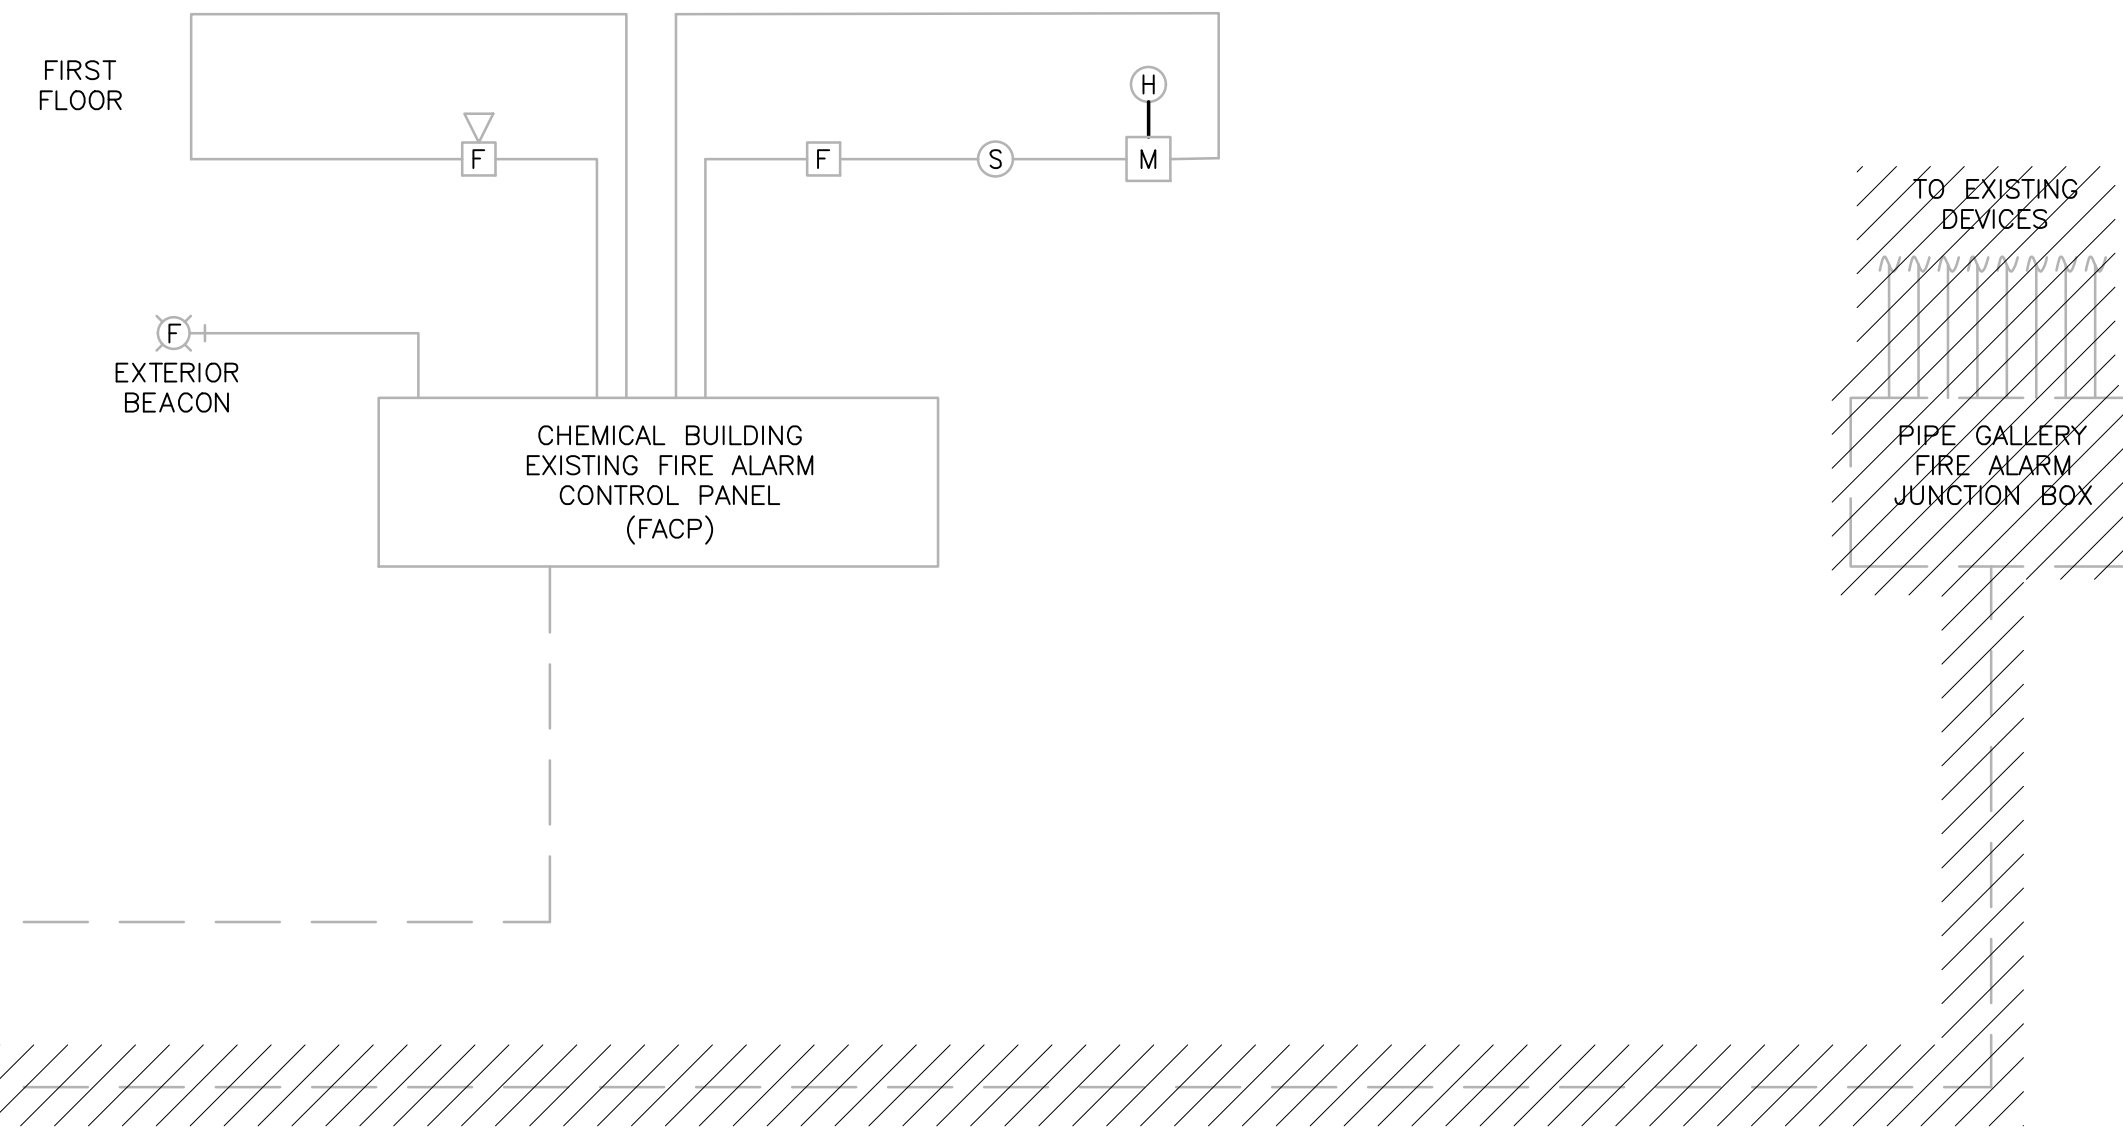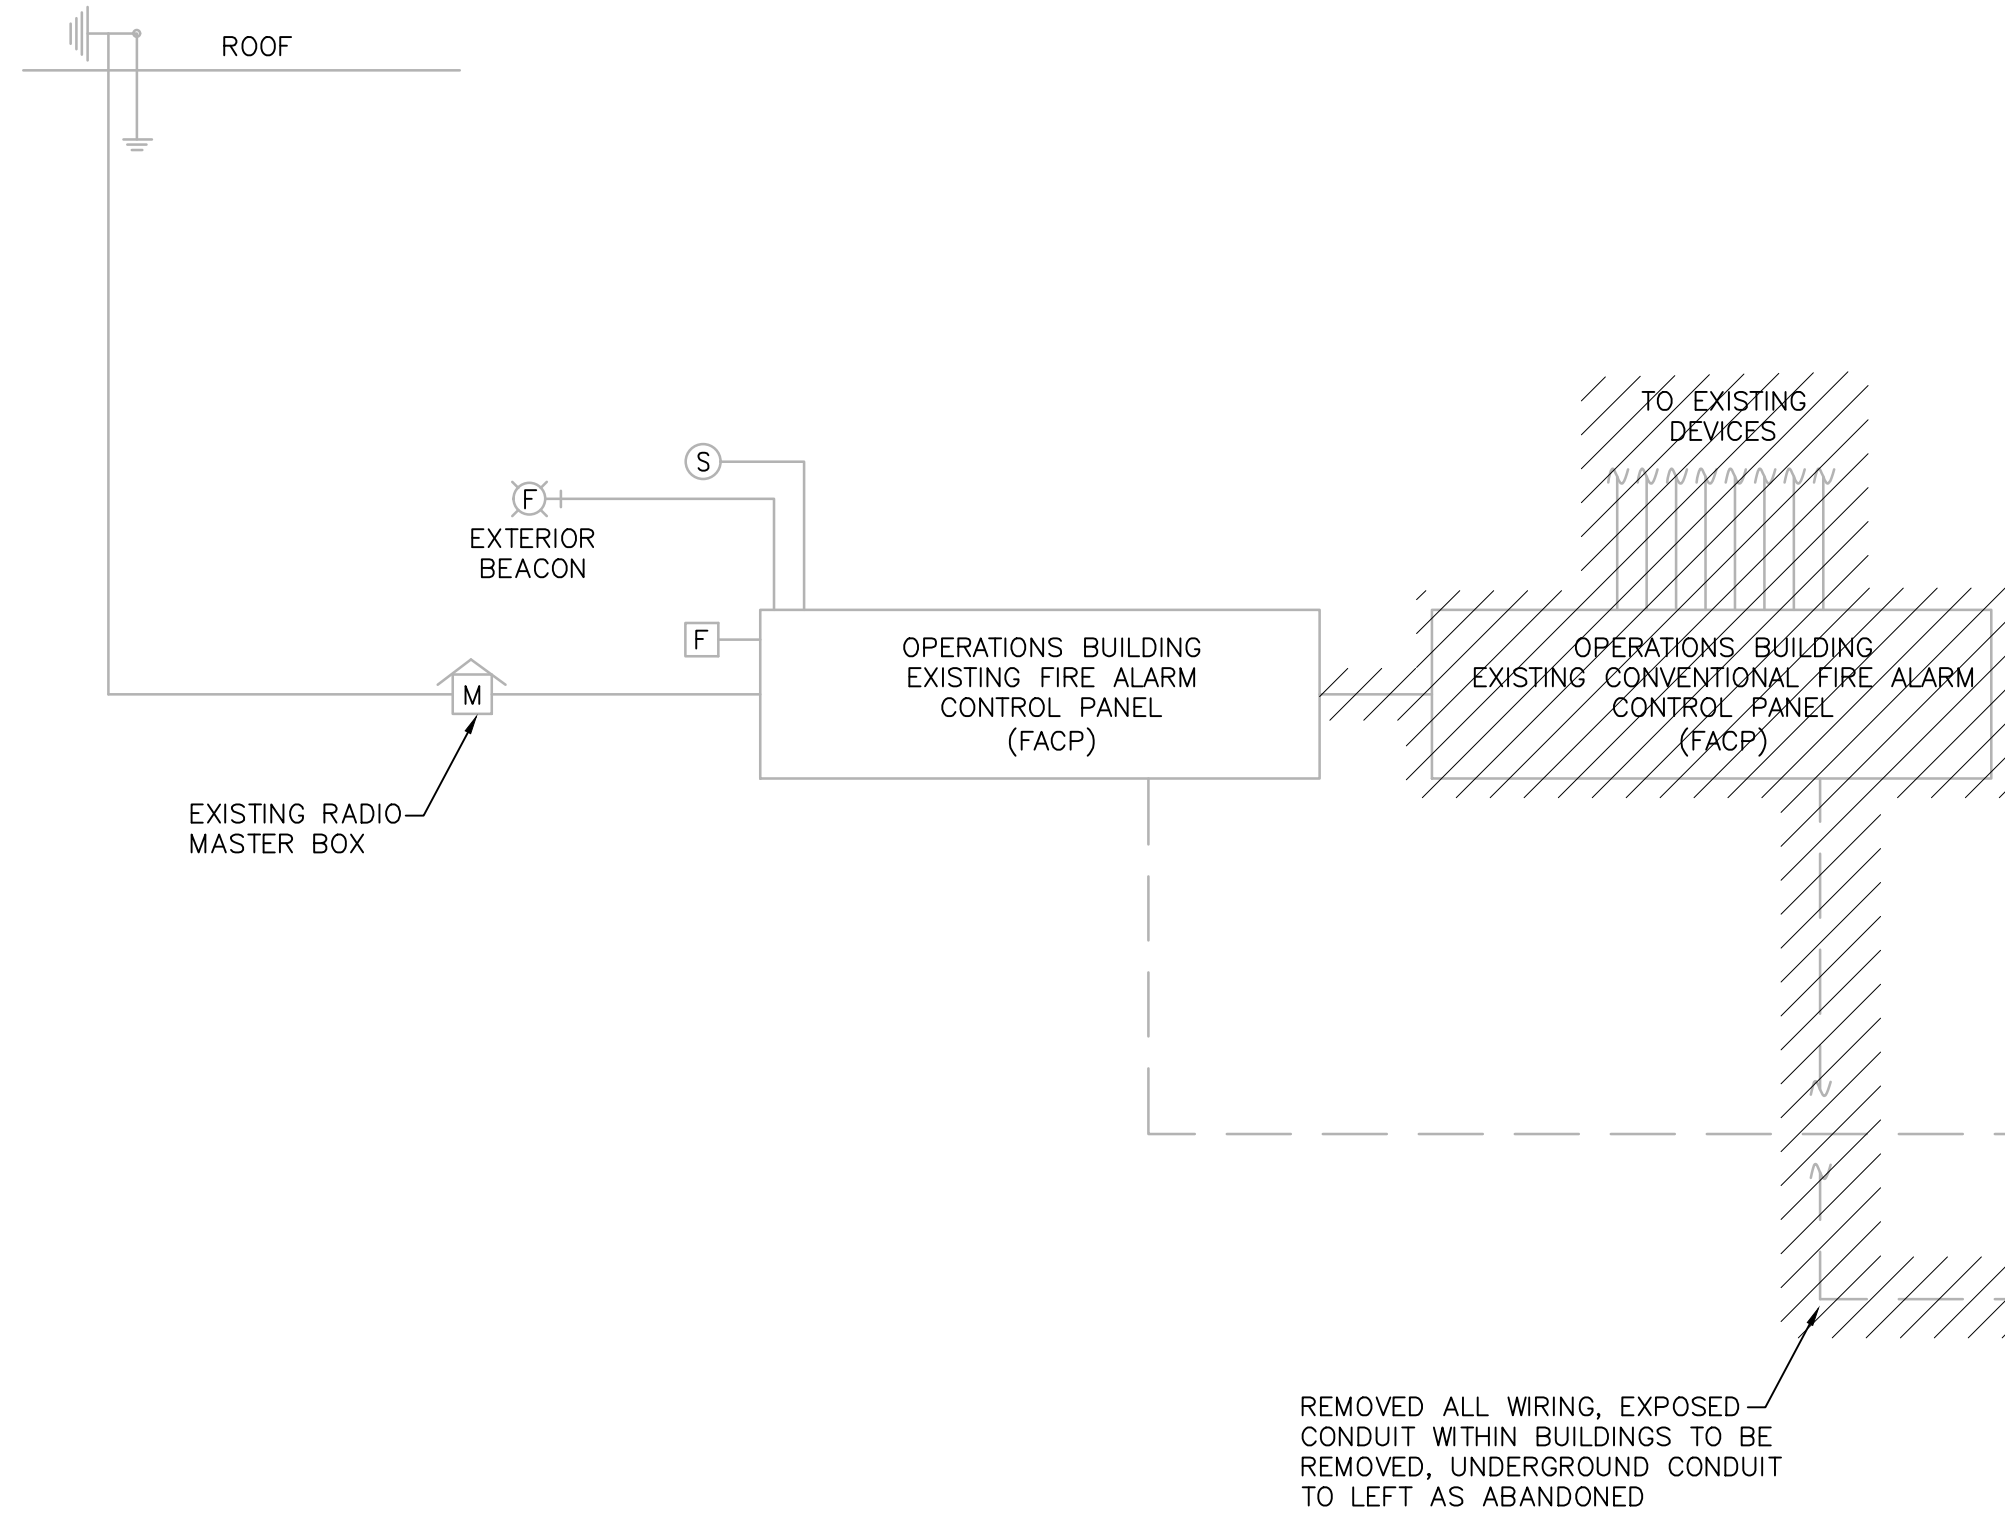


FIRE ALARM DEMOLITION RISER DIAGRAM
NOT TO SCALE

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PROJECT

**BURRILLVILLE WWTF
HEADWORKS &
OAKLAND PUMP
STATION
IMPROVEMENTS**

BURRILLVILLE, RI

TITLE

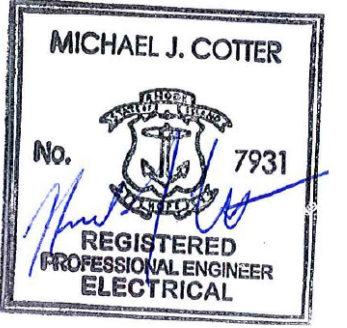WWTF

Fire Alarm
Riser Diagrams

NO.	REVISIONS	DATE

DRAWN BY: RLB
DESIGNED BY: RLB
CHECKED BY: MC
ISSUE DATE: MAY 2023
BETA JOB NO.: 6861-105


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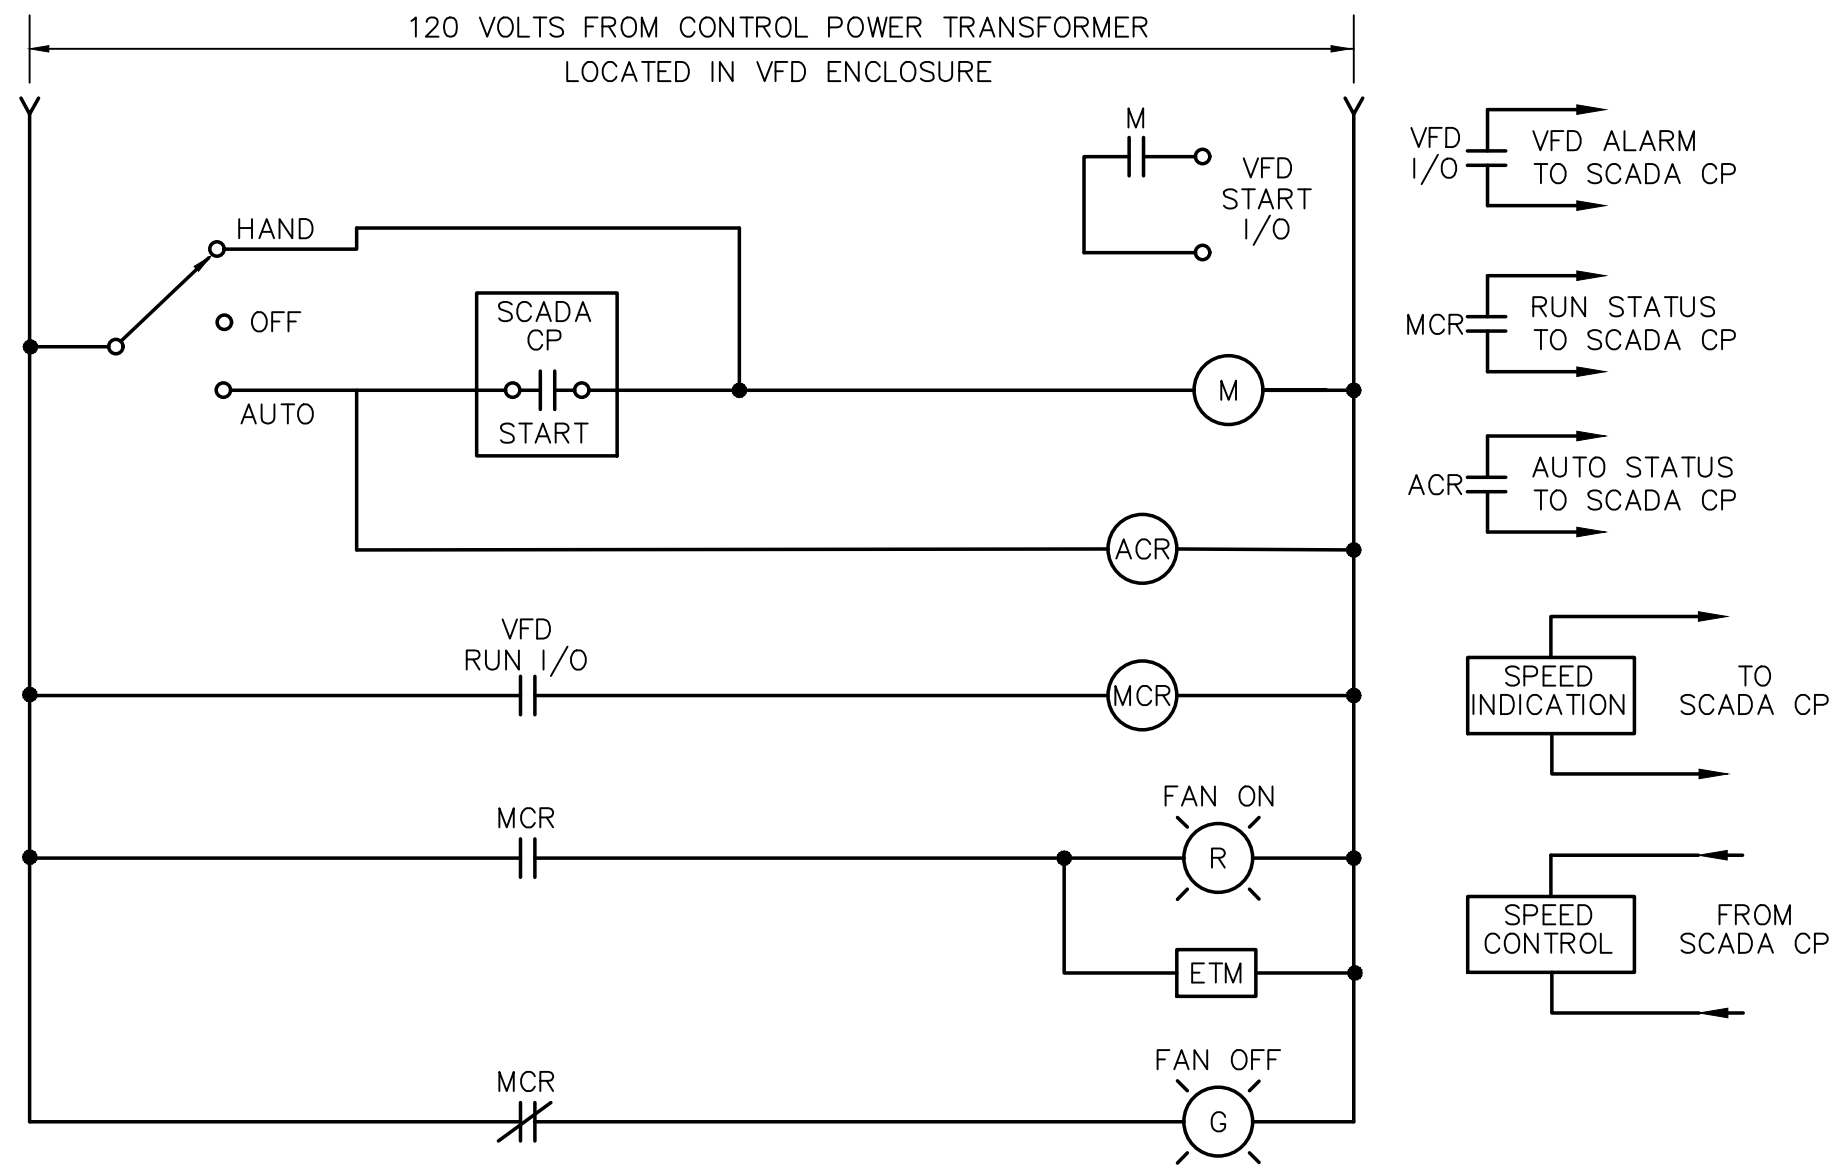
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SHEET NO.

E-0.4



**CONTROL WIRING DIAGRAM
SEWAGE PUMPS**
NOT TO SCALE

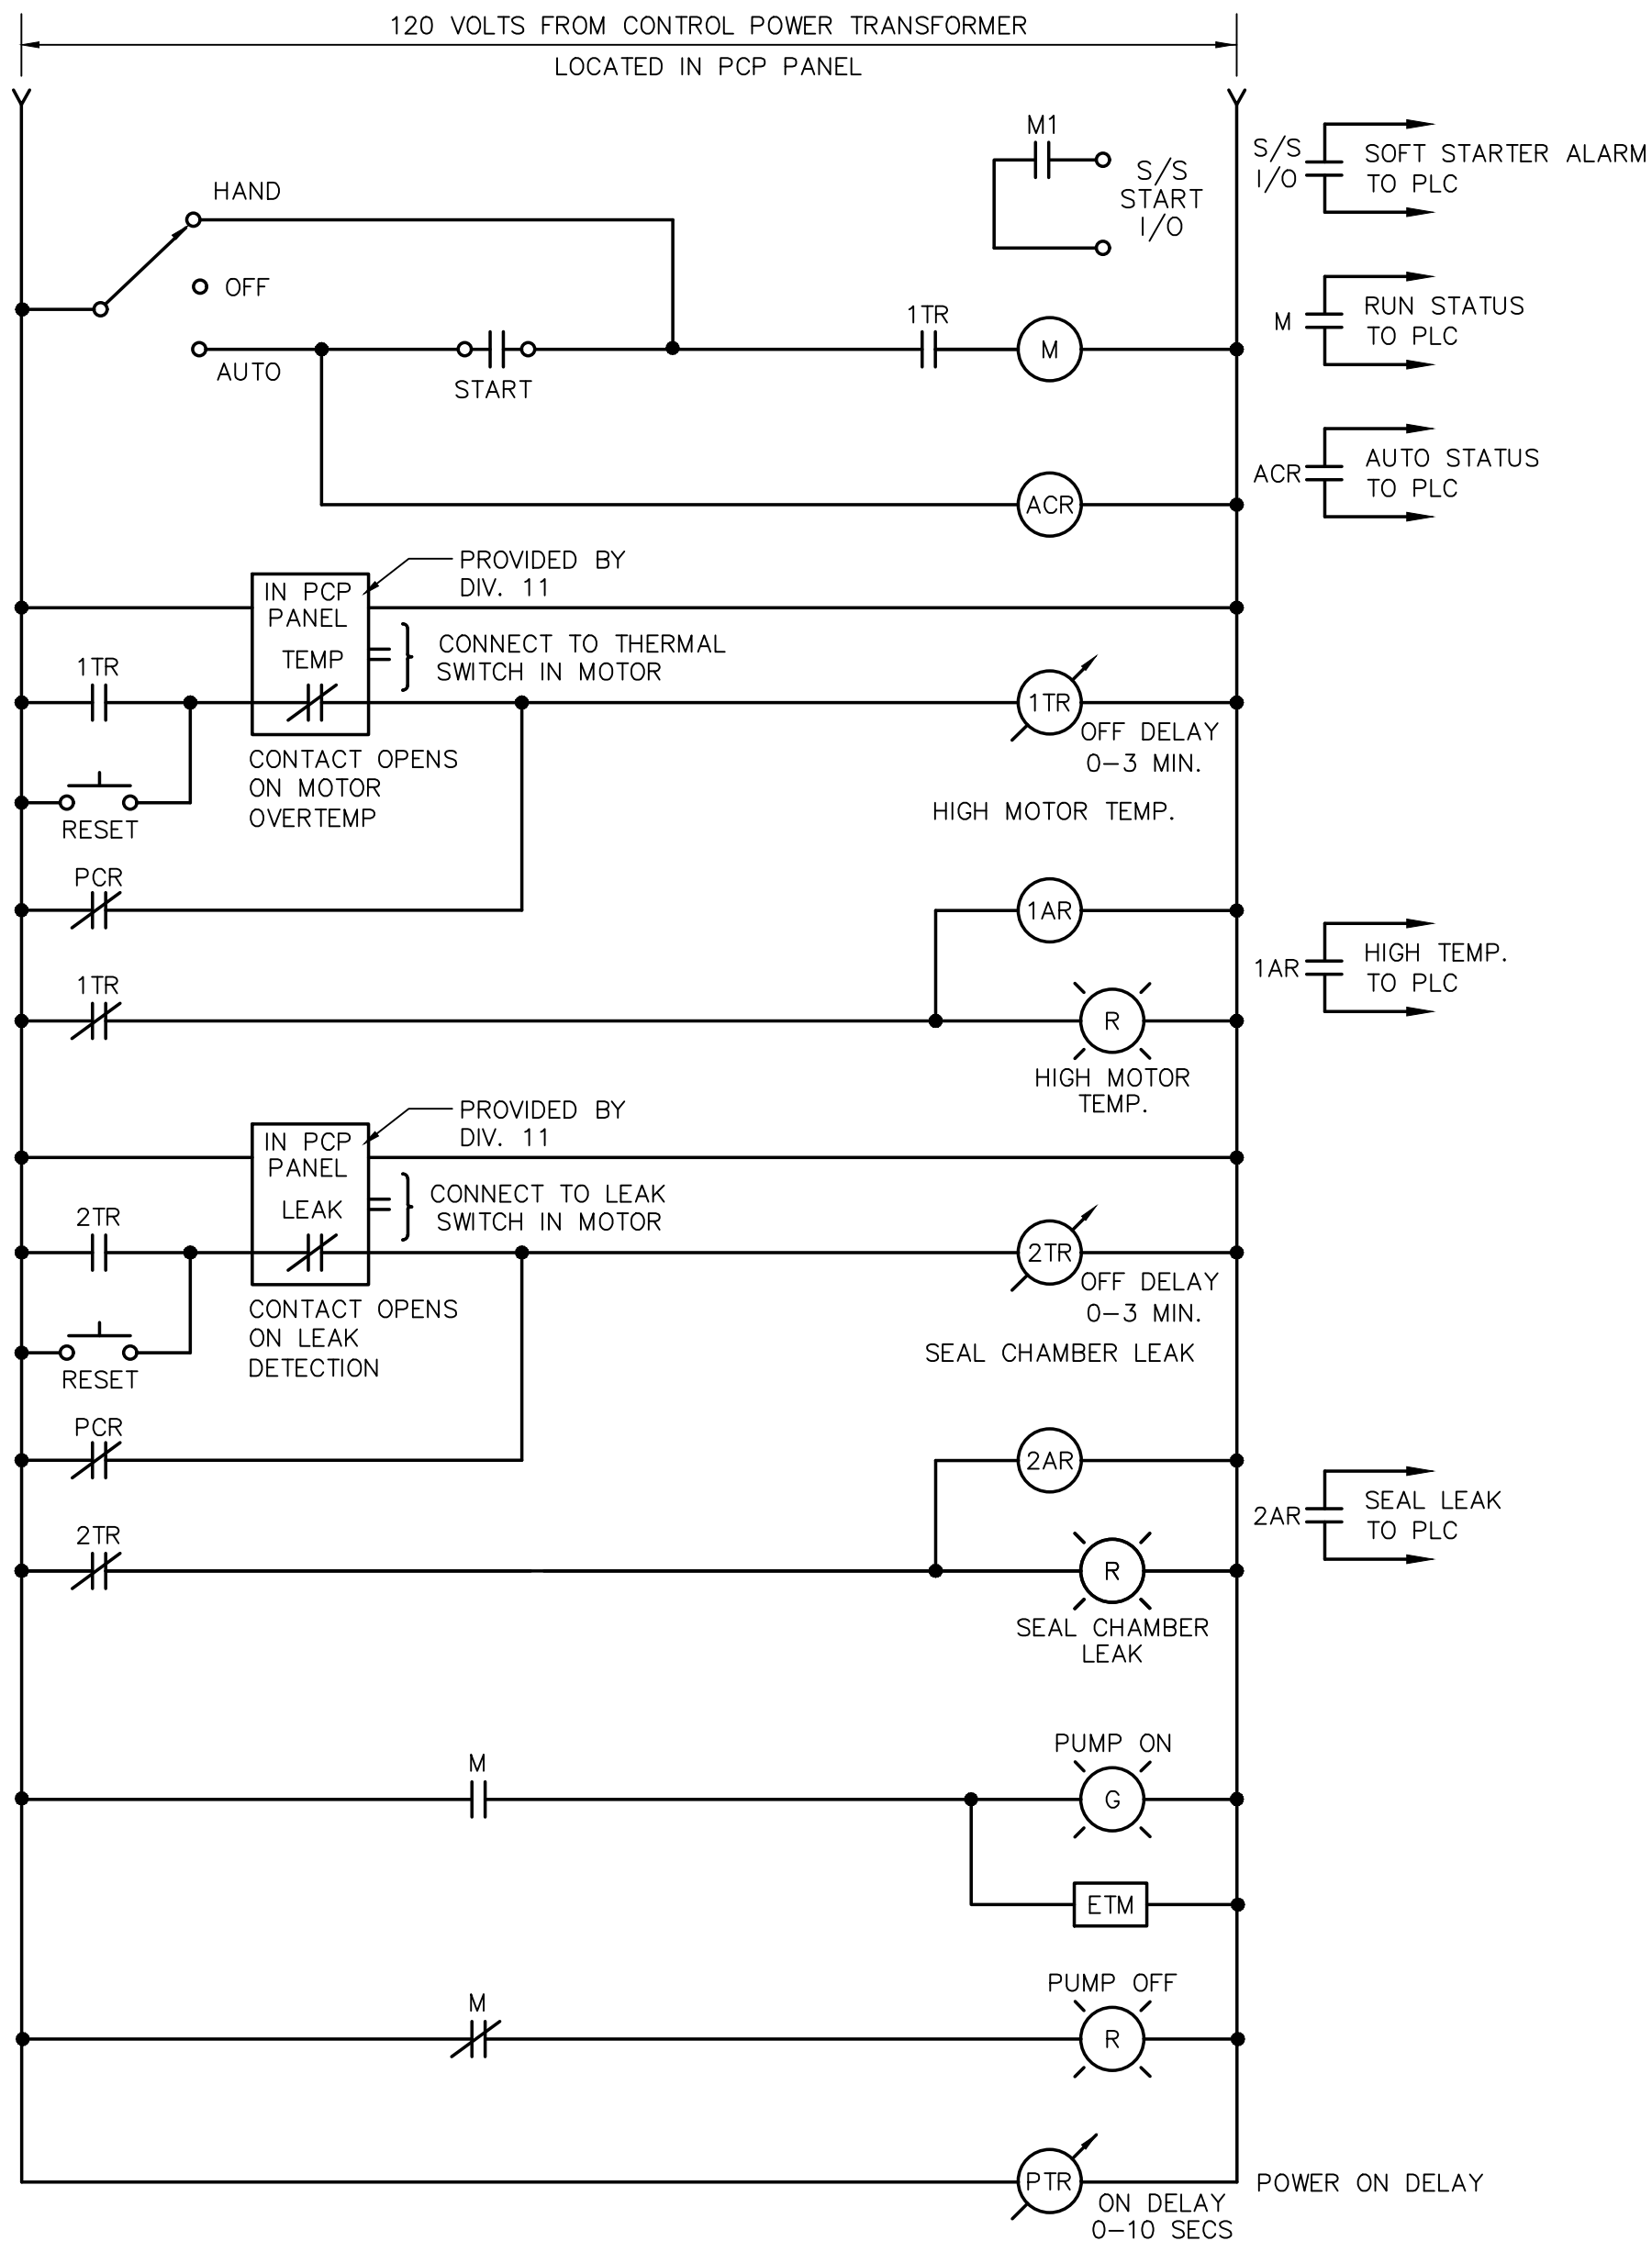


**MOTOR CONTROL WIRING DIAGRAM
EXHAUST FAN EF-1**
NOT TO SCALE

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PROJECT

**BURRILLVILLE WWTF
HEADWORKS &
OAKLAND PUMP
STATION
IMPROVEMENTS**

BURRILLVILLE, RI

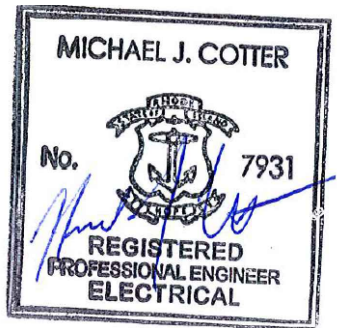TITLE

**Electrical
Motor Control
Wiring Diagrams**

NO.	REVISIONS	DATE
-----	-----------	------

DRAWN BY:	RLB
DESIGNED BY:	RLB
CHECKED BY:	MC
ISSUE DATE:	MAY 2023
BETA JOB NO.:	6861-105

SCALE

NONE

UNLESS OTHERWISE NOTED OR CHANGED BY REPRODUCTION

SHEET NO.

E-0.5

POWER CABLE/CONDUIT SCHEDULE			
SYMBOL	CONDUIT SIZE*	CONDUCTORS*	GND*
P22	3/4"	(2)#12	(1)#12
P23	3/4"	(3)#12	(1)#12
P26	3/4"	(6)#12	(1)#12
P32	3/4"	(2)#10	(1)#10
P33	3/4"	(3)#10	(1)#10
P53	3/4"	(3)#8	(1)#10
P54	3/4"	(4)#8	(1)#10
P63	1"	(3)#8	(1)#8
P64	1"	(4)#6	(1)#8
P83	1 1/4"	(3)#4	(1)#8
P84	1 1/4"	(4)#4	(1)#8
P103	1 1/2"	(3)#3	(1)#6
P104	1 1/2"	(4)#3	(1)#6
P113	1 1/2"	(3)#2	(1)#6
P114	1 1/2"	(4)#2	(1)#6
P133	2"	(3)#1	(1)#6
P134	2"	(4)#1	(1)#6
P153	2"	(3)#1/0	(1)#6
P154	2"	(4)#1/0	(1)#6
P173	2 1/2"	(3)#2/0	(1)#6
P174	2 1/2"	(4)#2/0	(1)#6
P203	2 1/2"	(3)#3/0	(1)#4
P204	2 1/2"	(4)#3/0	(1)#4
P254	3"	(4)250KCMIL	(1)#4

SIGNAL CABLE/CONDUIT SCHEDULE		
SYMBOL	CONDUIT SIZE	CONDUCTORS
S	1"	VENDER PROVIDED
S1	3/4"	1-2/C#16 TSP
S13	3/4"	1-3/C#16 TSP
S2	3/4"	2-2/C#16 TSP
S23	3/4"	2-3/C#16 TSP
S3	1"	3-2/C#16 TSP
S33	1"	3-3/C#16 TSP
S4	1"	4-2/C#16 TSP
S5	1"	5-2/C#16 TSP
S6	1 1/2"	6-2/C#16 TSP
S7	1 1/2"	7-2/C#16 TSP
S8	1 1/2"	8-2/C#16 TSP
S9	1 1/2"	9-2/C#16 TSP
S10	2"	10-2/C#16 TSP
TC1	3/4"	8/C#18

TELE/DATA CABLE/CONDUIT SCHEDULE		
SYMBOL	CONDUIT SIZE	CABLES
TD1	1"	1-CAT6
TD2	1"	2-CAT6
F6	2"	6 STRAND FIBER OPTIC
F6E	EXISTING 2"	6 STRAND FIBER OPTIC

CONTROL CABLE/CONDUIT SCHEDULE		
SYMBOL	CONDUIT SIZE	CONDUCTORS
C2	3/4"	2#14
C4	3/4"	4#14
C5	3/4"	5#14
C6	3/4"	6#14
C7	3/4"	7#14
C8	3/4"	8#14
C9	3/4"	9#14
C10	3/4"	10#14
C12	3/4"	12#14
C16	1"	16#14
C20	1"	20#14
C30	1"	30#14
C50	1 1/2"	50#14
C100	2"	100#14
C200	3"	200#14

NOTE: CONDUIT AND CONDUCTOR SIZES ARE TO BE PER THE ABOVE SCHEDULES UNLESS OTHERWISE NOTED.

PANELBOARD SCHEDULE															
NO. MPB _____				LOCATION: ELECTRIC ROOM _____											
208/120 V, 3 PH, 4 W, 400 A MAINS				400 A SOLID NEUTRAL				250 A MCB							
22,000 AIC AT 120 V				400 A GROUND BUS				A MLO SURFACE MOUNTING							
CIRCUIT	DESCRIPTION OF LOAD	LOAD (KVA)			BREAKER		B	C	BREAKER		LOAD (KVA)			DESCRIPTION OF LOAD	CIRCUIT
		Aø	Bø	Cø	TRIP	POLE			POLE	TRIP	Aø	Bø	Cø		
1	ELECTRIC ROOM RECEPTACLES - EXISTING CIRCUIT	1.0			20	1				1	20	0.4		DRY WELL RECETPACLE	2 *
3	ELECTRIC ROOM LIGHTS - EXISTING CIRCUIT		0.5		20	1				1	20		0.4	DRY WELL LIGHTS	4 *
5	CELLULAR DIALER - EXISTING CIRCUIT			0.2	20	1				1	20		1.0	DRY WELL SUMP PUMP	6 *
7	EXISTING CIRCUIT	0.5			20	1				1	20	1.0		DRY WELL EXHAUST FAN	8 *
9	EXISTING CIRCUIT		0.5		20	1				1	20		0.4	EXTERIOR RECETPACLES	10 *
11	EXISTING CIRCUIT			0.5	20	1				1	20		0.60	FLOW METER AND CHART RECORDER	12 *
13	SPARE	-	-	-	20	1				1	30	-	-	SPARE	14
15	SPARE	-	-	-	20	1				1	20	-	-	SPARE	16
17	SPARE	-	-	-	20	1				1	20	-	-	SPARE	18
19	SPARE	-	-	-	20	1				1	20	-	-	SPARE	20
21	SPARE	-	-	-	20	1				1	20	-	-	SPARE	22
23	SPARE	-	-	-	20	1				1	20	-	-	SPARE	24
25	SPARE	-	-	-	20	1				1	20	-	-	SPARE	26
27	SPARE	-	-	-	20	1				1	20	-	-	SPARE	28
29	SPARE	-	-	-	20	1				1	20	-	-	SPARE	30
31		1.0								1	20	-	-	SPARE	32
33	ELECTRIC UNIT HEATER 3KW		1.0		20	3				1	20		0.6	GENERATOR BATTERY CHARGER & ALTERNATOR HEATER	34
35				1.0						1	20		1.0	GENERATOR JACKET HEATER	36
	PUMP CONTROL PANEL	18.5			200	3				3	30			SPD	
			18.5												
				18.5											
SUB-TOTAL CONNECTED		21.0	20.5	20.2						1.4	1.4	2.6	SUB-TOTAL CONNECTED		
* PROVIDE GFCI BREAKER															
				SUB-TOTAL CONNECTED				KVA Aø = 22.4							
				SUB-TOTAL CONNECTED				KVA Bø = 22.9							
				SUB-TOTAL CONNECTED				KVA Cø = 22.8							
				TOTAL CONNECTED				KVA = 68.1							

LIGHTING FIXTURE SCHEDULE										
TYPE	DESCRIPTION	MANUFACTURER & CATALOG SERIES	LAMPS		VOLTS	WATTS	MOUNTING		REMARKS	
			TYPE	LUMENS			TYPE	HEIGHT		
F1	CLASS I DIV.1 EXPLOSION PROOF LED LIGHT FIXTURE	LIGHTLOGIX LLEX-20W-4000K-120-A1-N	LED 4000K	2800lm	120	20	CEILING	-	-	
F2	UTILITY CLEAR GLOBE LED LIGHT FIXTURE WITH GUARD	HUBBELL VSL-16-30-V2-P-N	LED 5000K	1328lm	120	16	WALL	6' AFF	-	

LIGHTING FIXTURE SCHEDULES NOTES:


- THE CATALOG NUMBERS LISTED ARE GIVEN AS A GUIDE TO THE DESIGN AND QUALITY OF FIXTURE DESIRED. EQUIVALENT DESIGNS, MATERIALS, DIMENSIONS, COEFFICIENT OF UTILIZATIONS AND EQUAL QUALITY FIXTURES OF OTHER MANUFACTURERS WILL BE ACCEPTABLE.

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PROJECT

**BURRILLVILLE WWTF
HEADWORKS &
OAKLAND PUMP
STATION
IMPROVEMENTS**

BURRILLVILLE, RI

TITLE

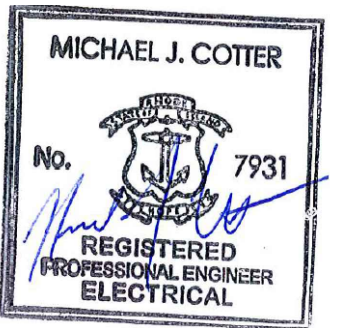Electrical
Schedules

NO. REVISIONS DATE

DRAWN BY: RLB

DESIGNED BY: RLB

CHECKED BY: MC

ISSUE DATE: MAY 2023

BETA JOB NO.: 6861-105


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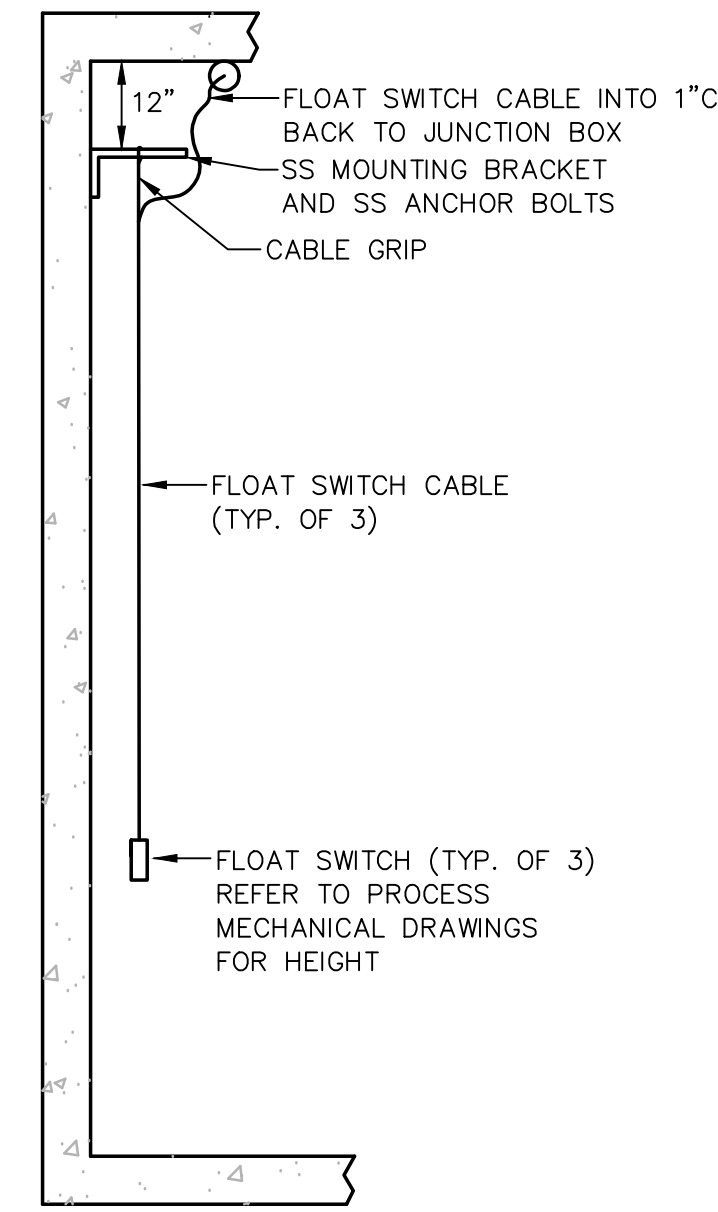
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SHEET NO.


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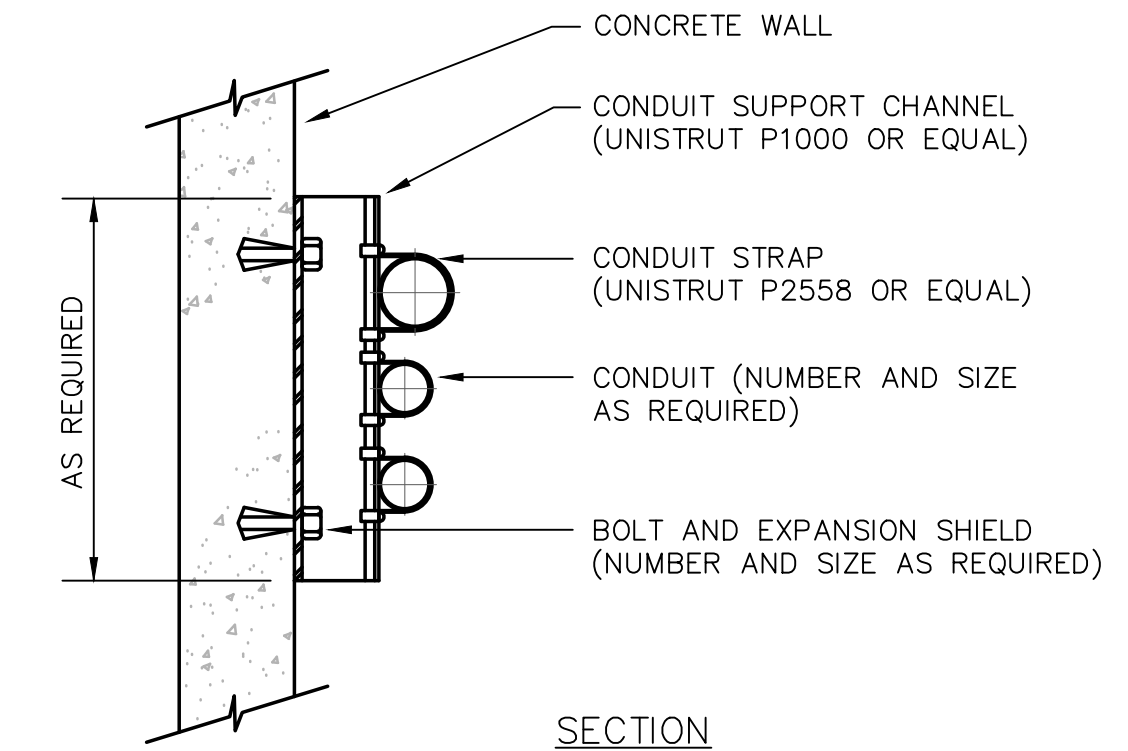
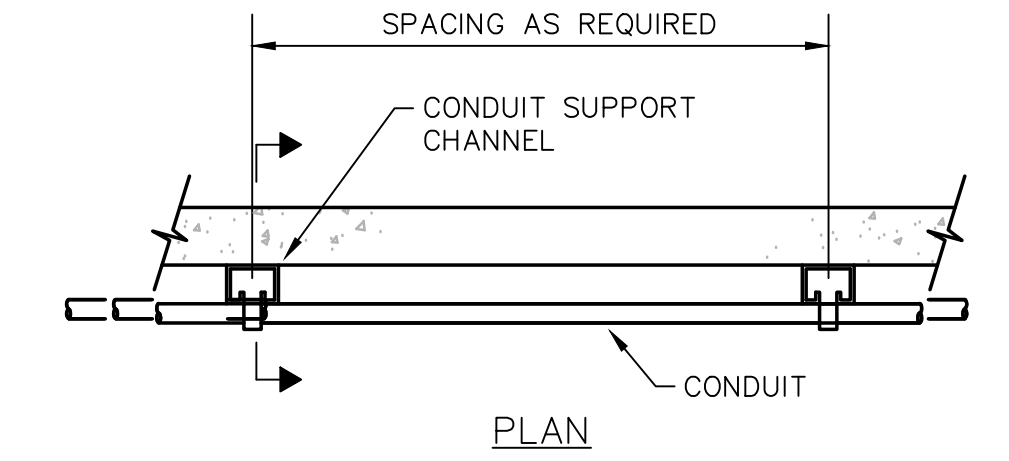
**SUBMERSIBLE LEVEL TRANSDUCER
IN WET WELL**
NOT TO SCALE




**FLOAT LEVEL SWITCH
IN WET WELL**
NOT TO SCALE

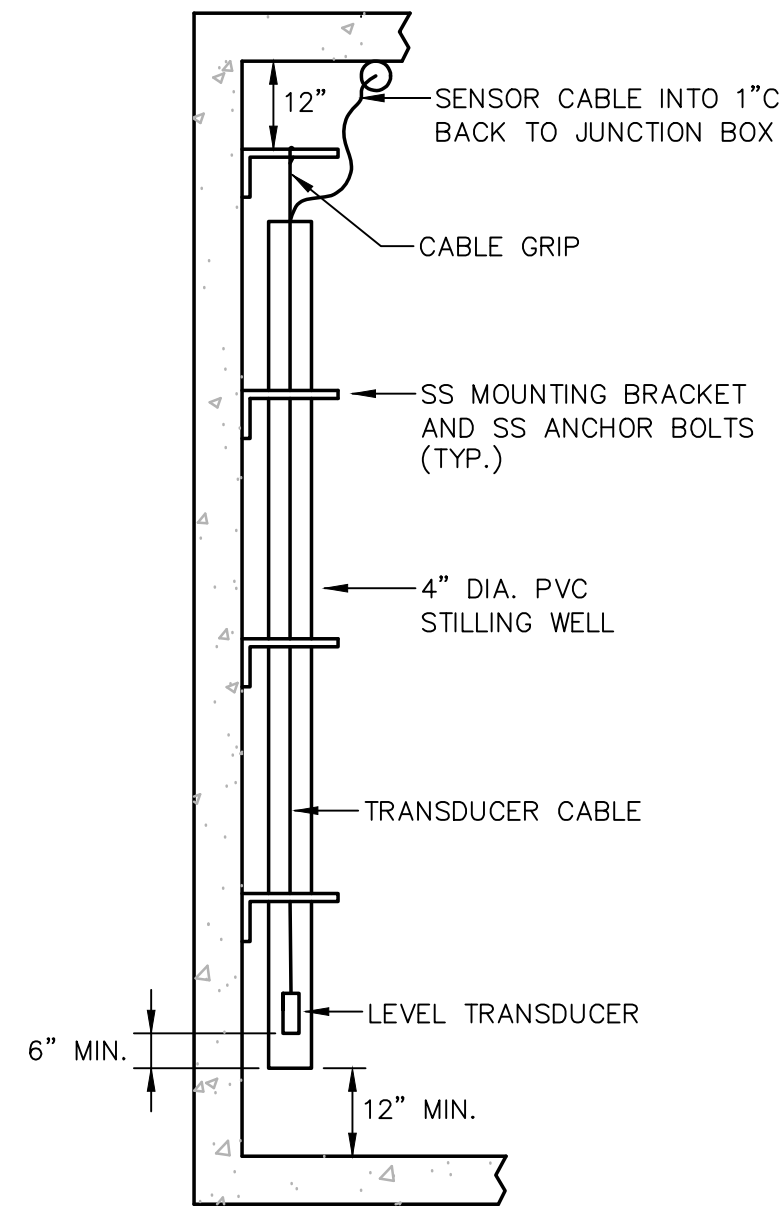

**ELECTRICAL EQUIPMENT
STANCHION MOUNTING DETAIL**
NOT TO SCALE

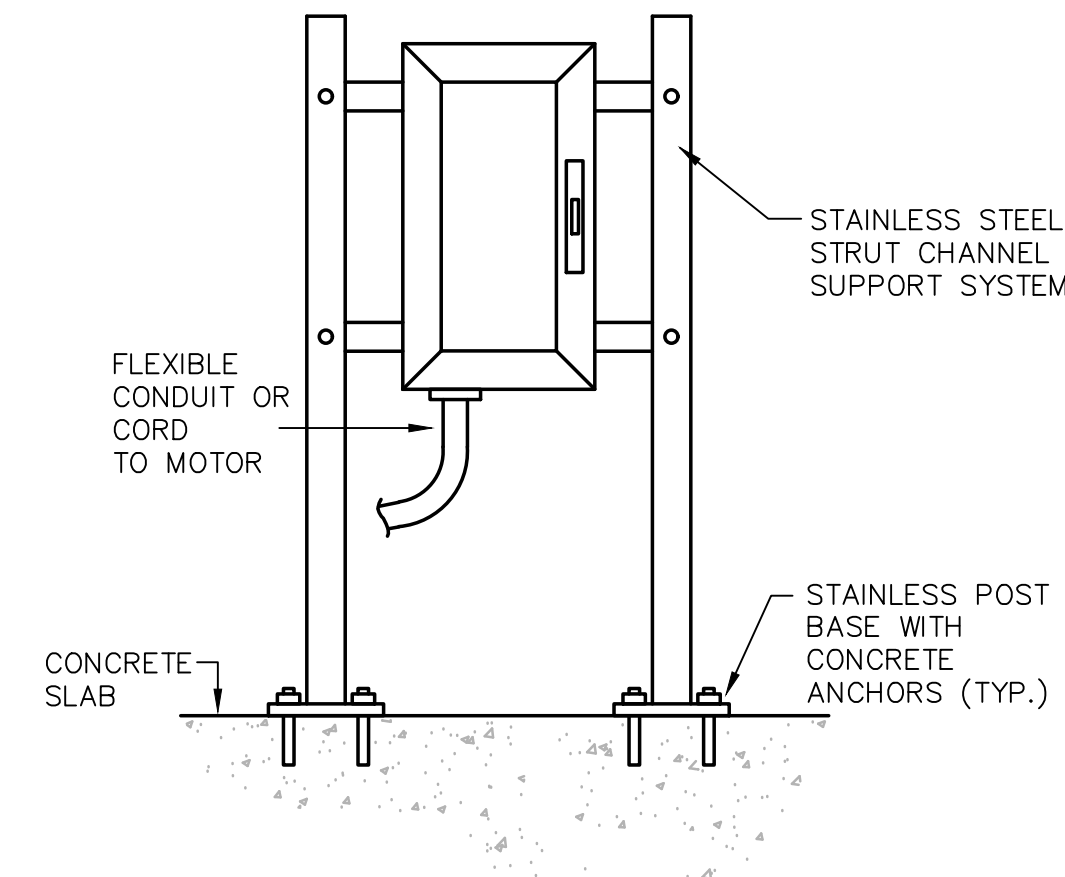


TYPICAL CONDUIT WALL SUPPORT
NOT TO SCALE

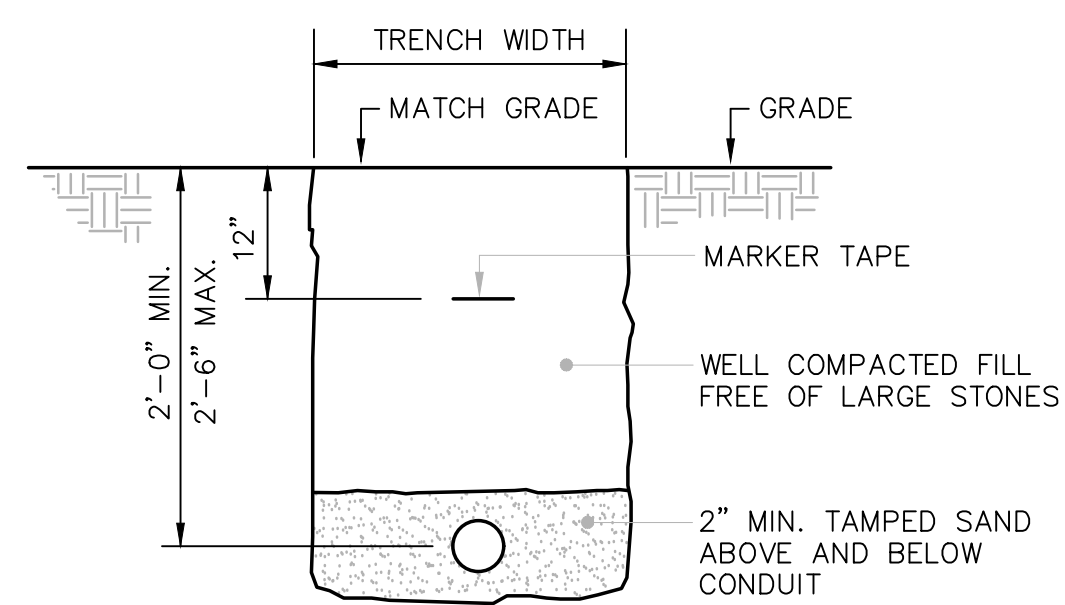


- NOTES:**
- BACKFILL IN LAYERS AND MANUALLY TAMP. PROVIDE RED DUCT BANK MARKER TAPE, READING "CAUTION - ELECTRICAL LINES BELOW", OVER ENTIRE LENGTH OF DUCTLINE. LOCATE TAPE 12 INCHES BELOW GRADE. PROVIDE A TAPE FOR EVERY 12 INCHES OF WIDTH OF DUCTLINE.
 - TRENCHING AND BACKFILLING SHALL BE PERFORMED UNDER DIVISION 2 OF THIS CONTRACT.


TYPICAL UNDERGROUND CONDUIT SECTION
NOT TO SCALE

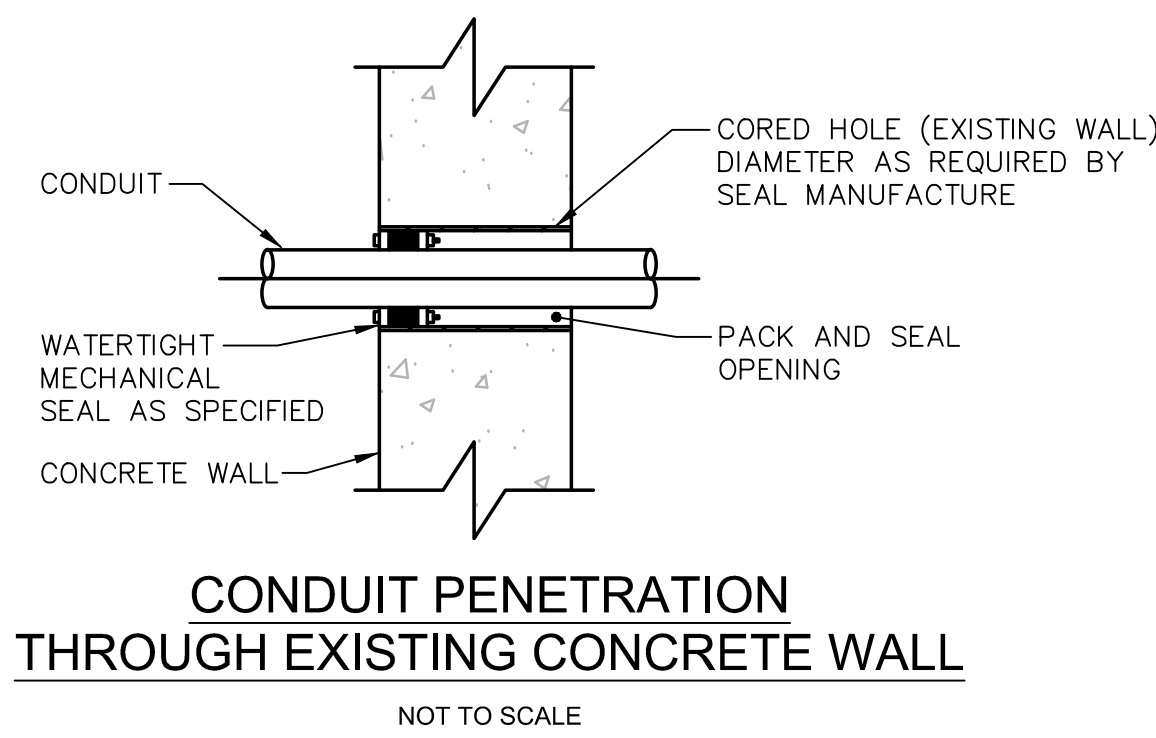

**CONDUIT PENETRATION
THROUGH EXISTING CONCRETE WALL**
NOT TO SCALE

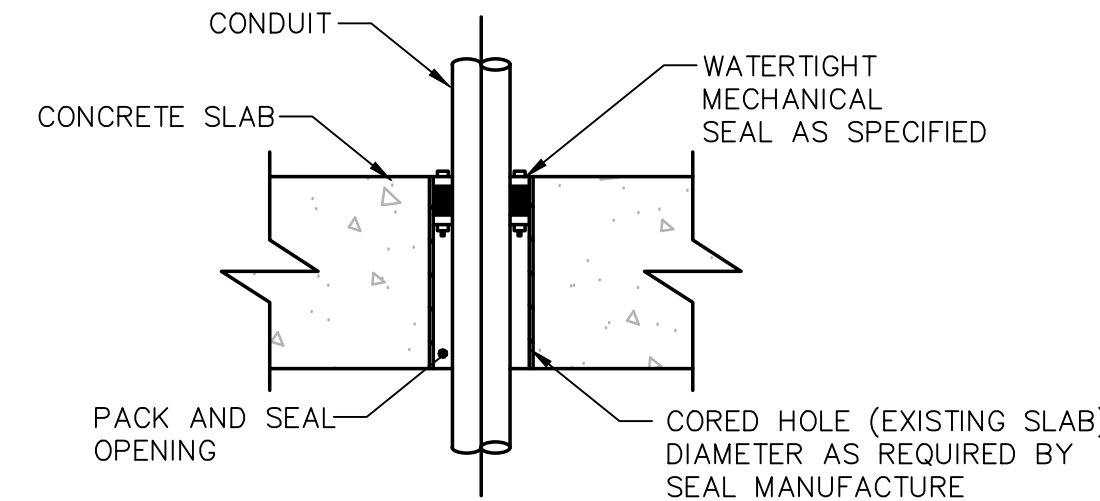

**CONDUIT PENETRATION PASSING
THROUGH EXISTING CONCRETE SLAB**
NOT TO SCALE

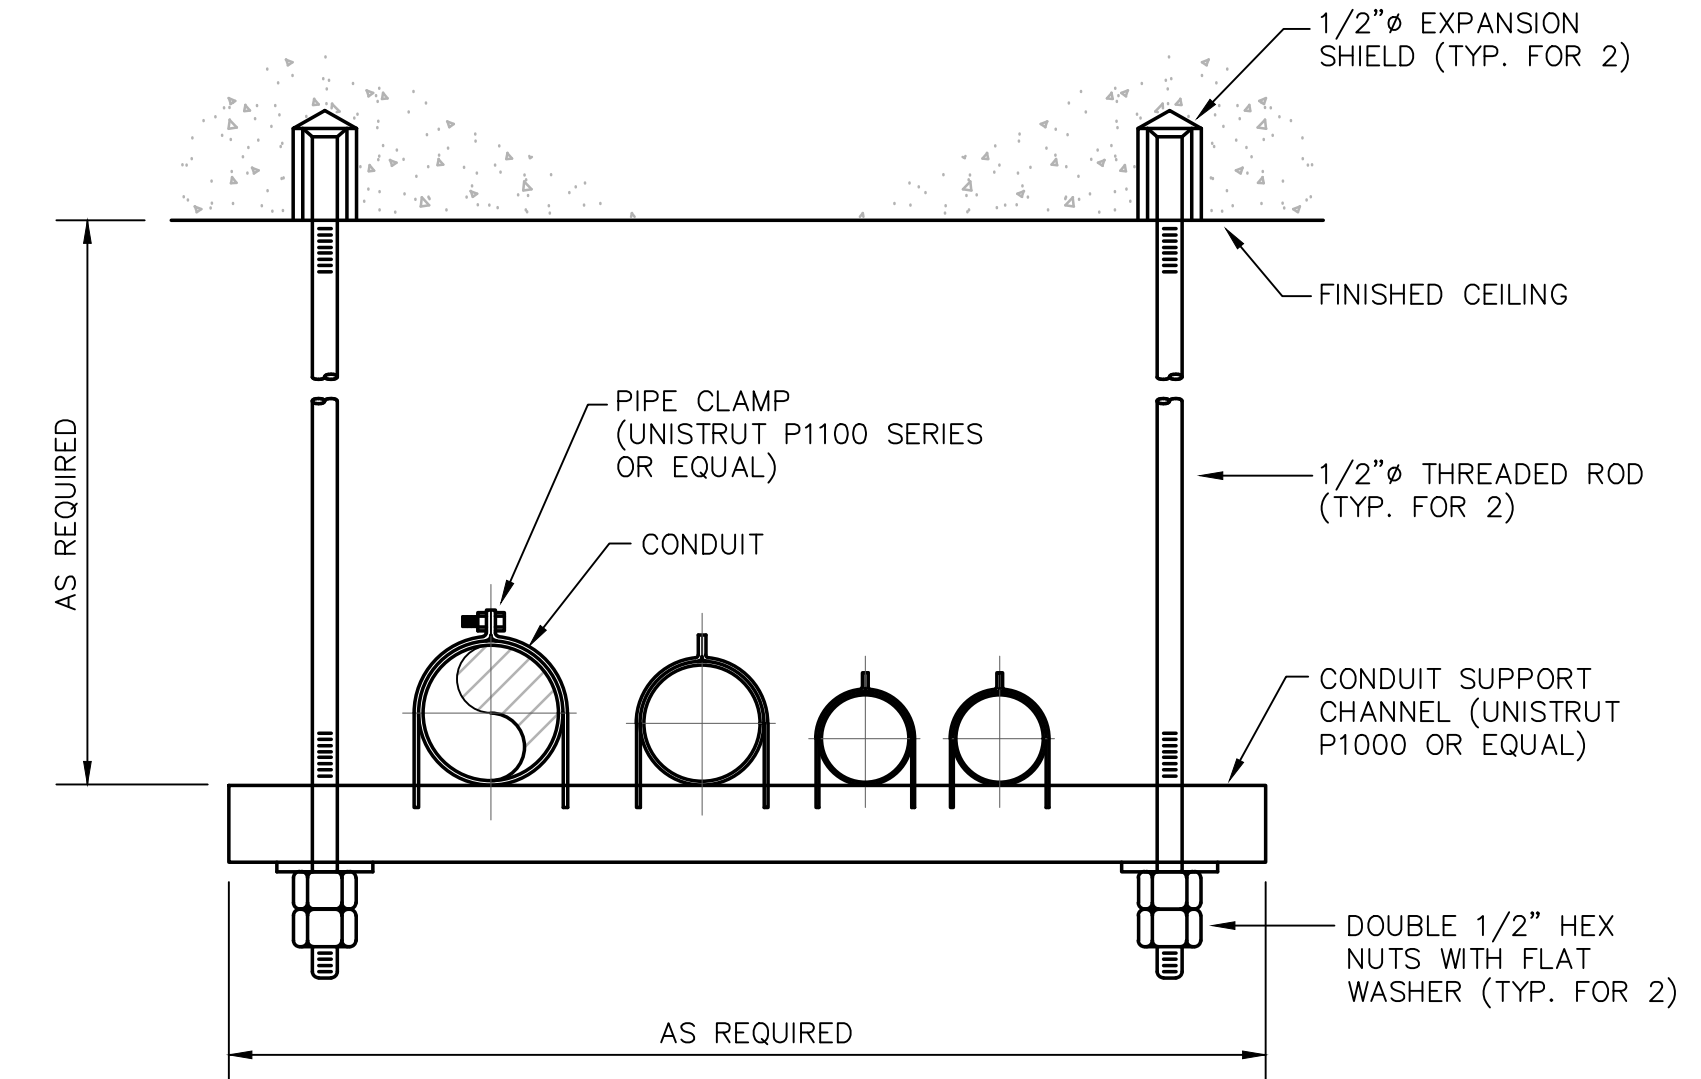


TYPICAL CONDUIT CEILING SUPPORT
NOT TO SCALE

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PROJECT

**BURRILLVILLE WWTF
HEADWORKS &
OAKLAND PUMP
STATION
IMPROVEMENTS**

BURRILLVILLE, RI

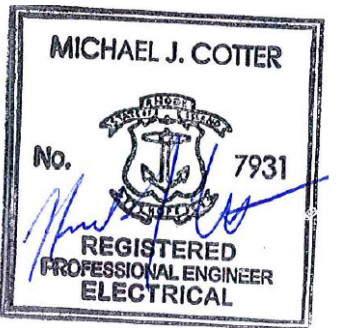TITLE

**Electrical
Details**

NO. REVISIONS DATE

DRAWN BY: RLB

DESIGNED BY: RLB

CHECKED BY: MC

ISSUE DATE: MAY 2023

BETA JOB NO.: 6861-105


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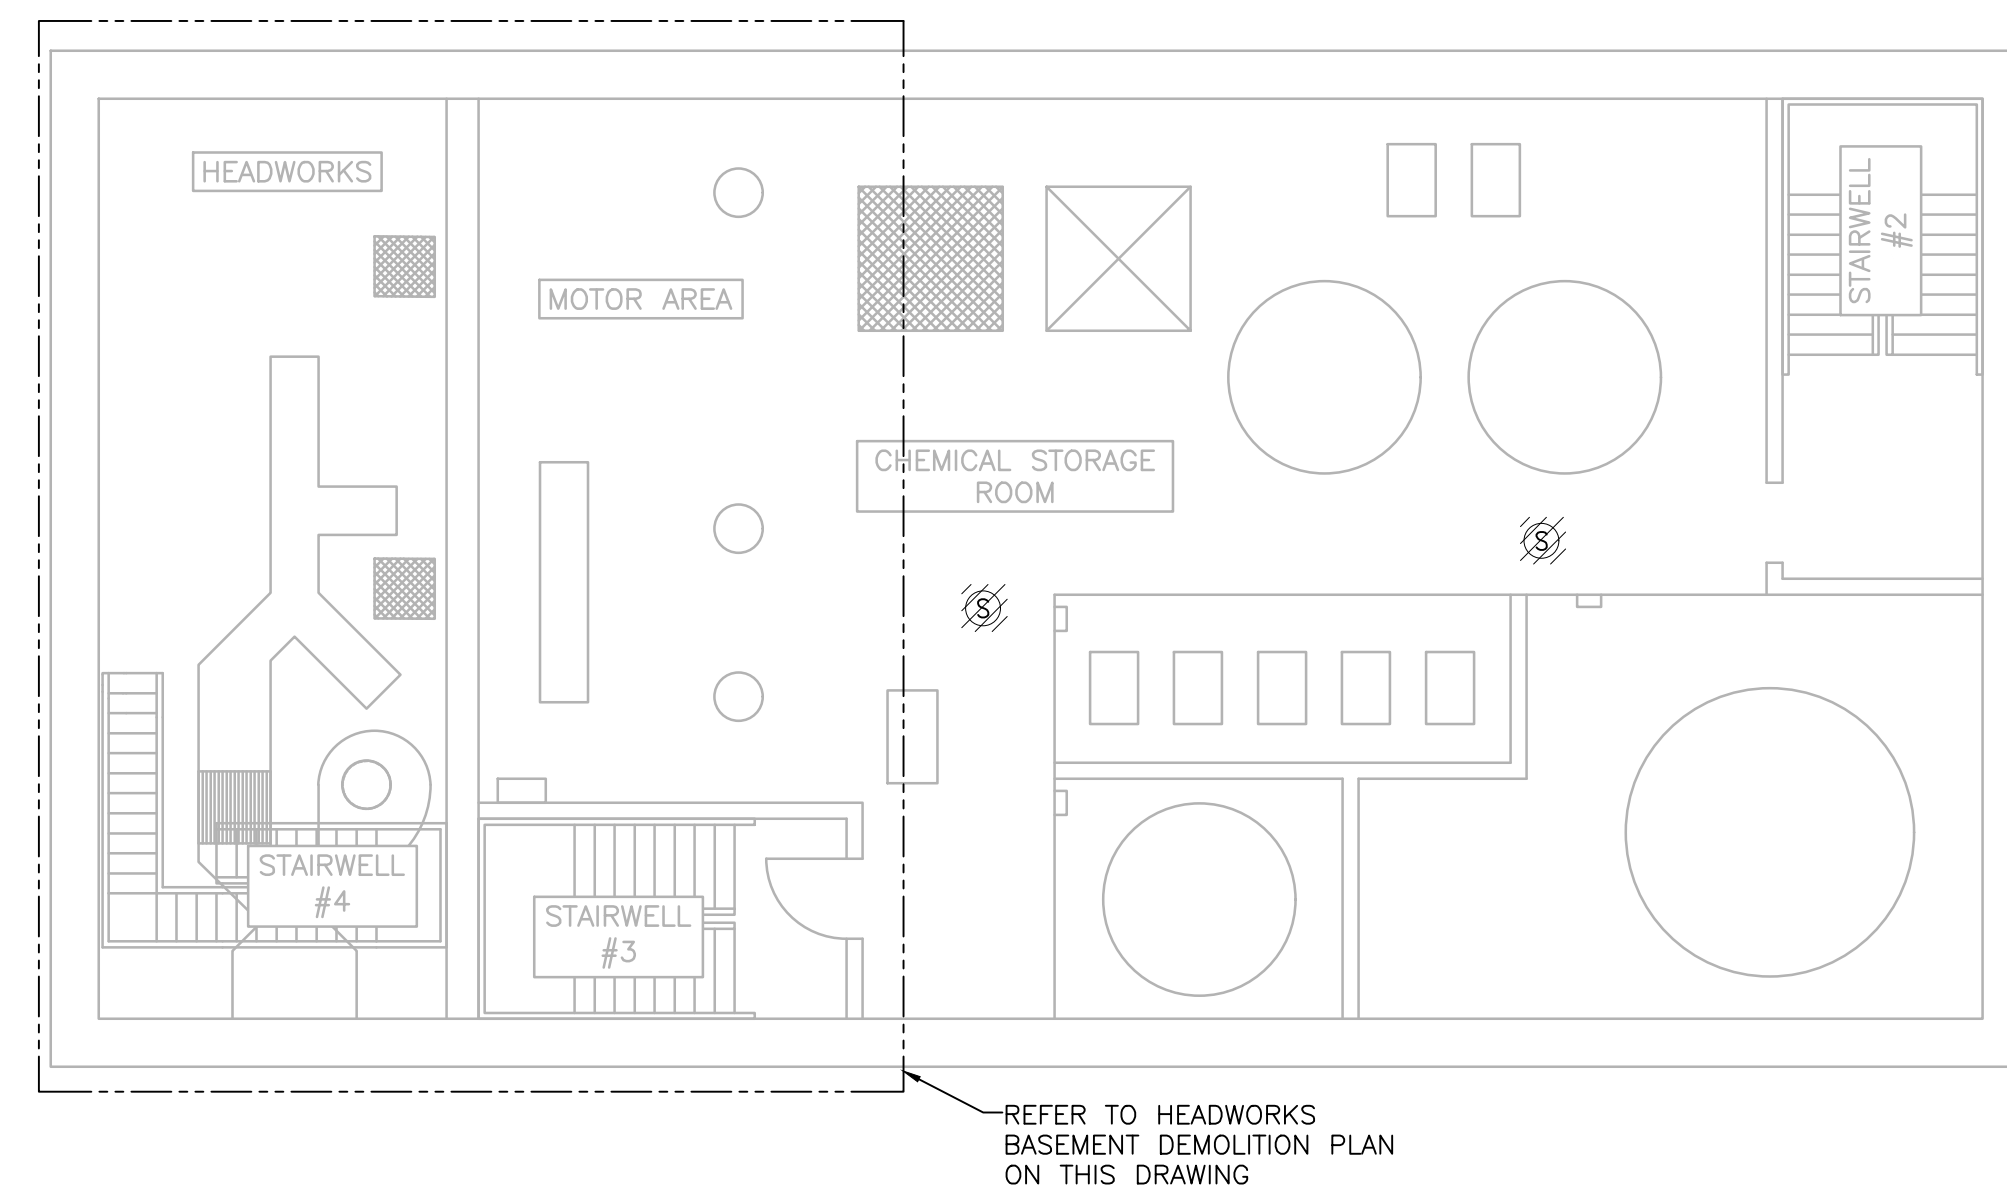
UNLESS OTHERWISE NOTED OR CHANGED BY REPRODUCTION

SHEET NO.


E-0.7



SUB BASEMENT - DEMOLITION PLAN
SCALE: 1/8" = 1'

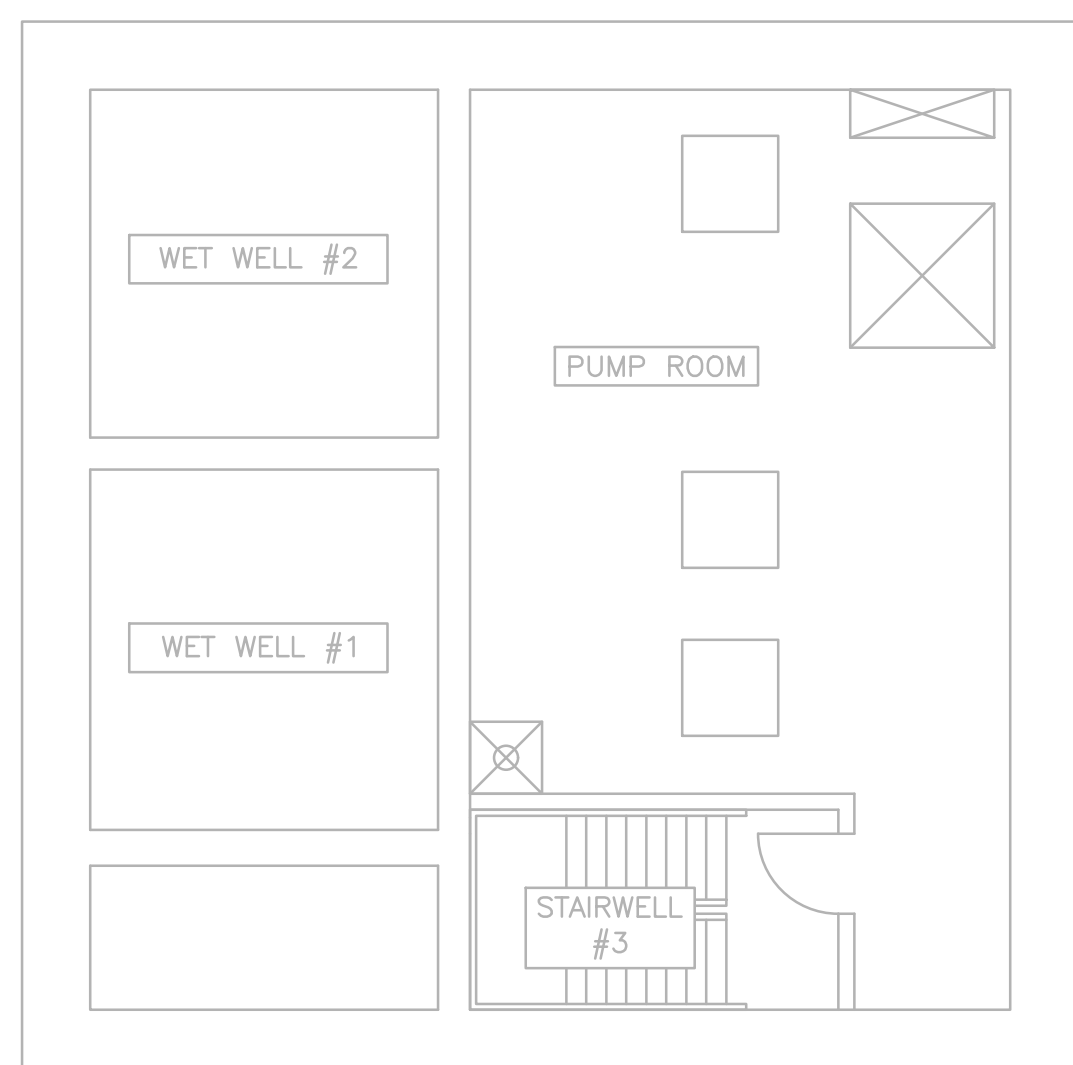

BASEMENT - DEMOLITION PLAN
SCALE: 1/8" = 1'

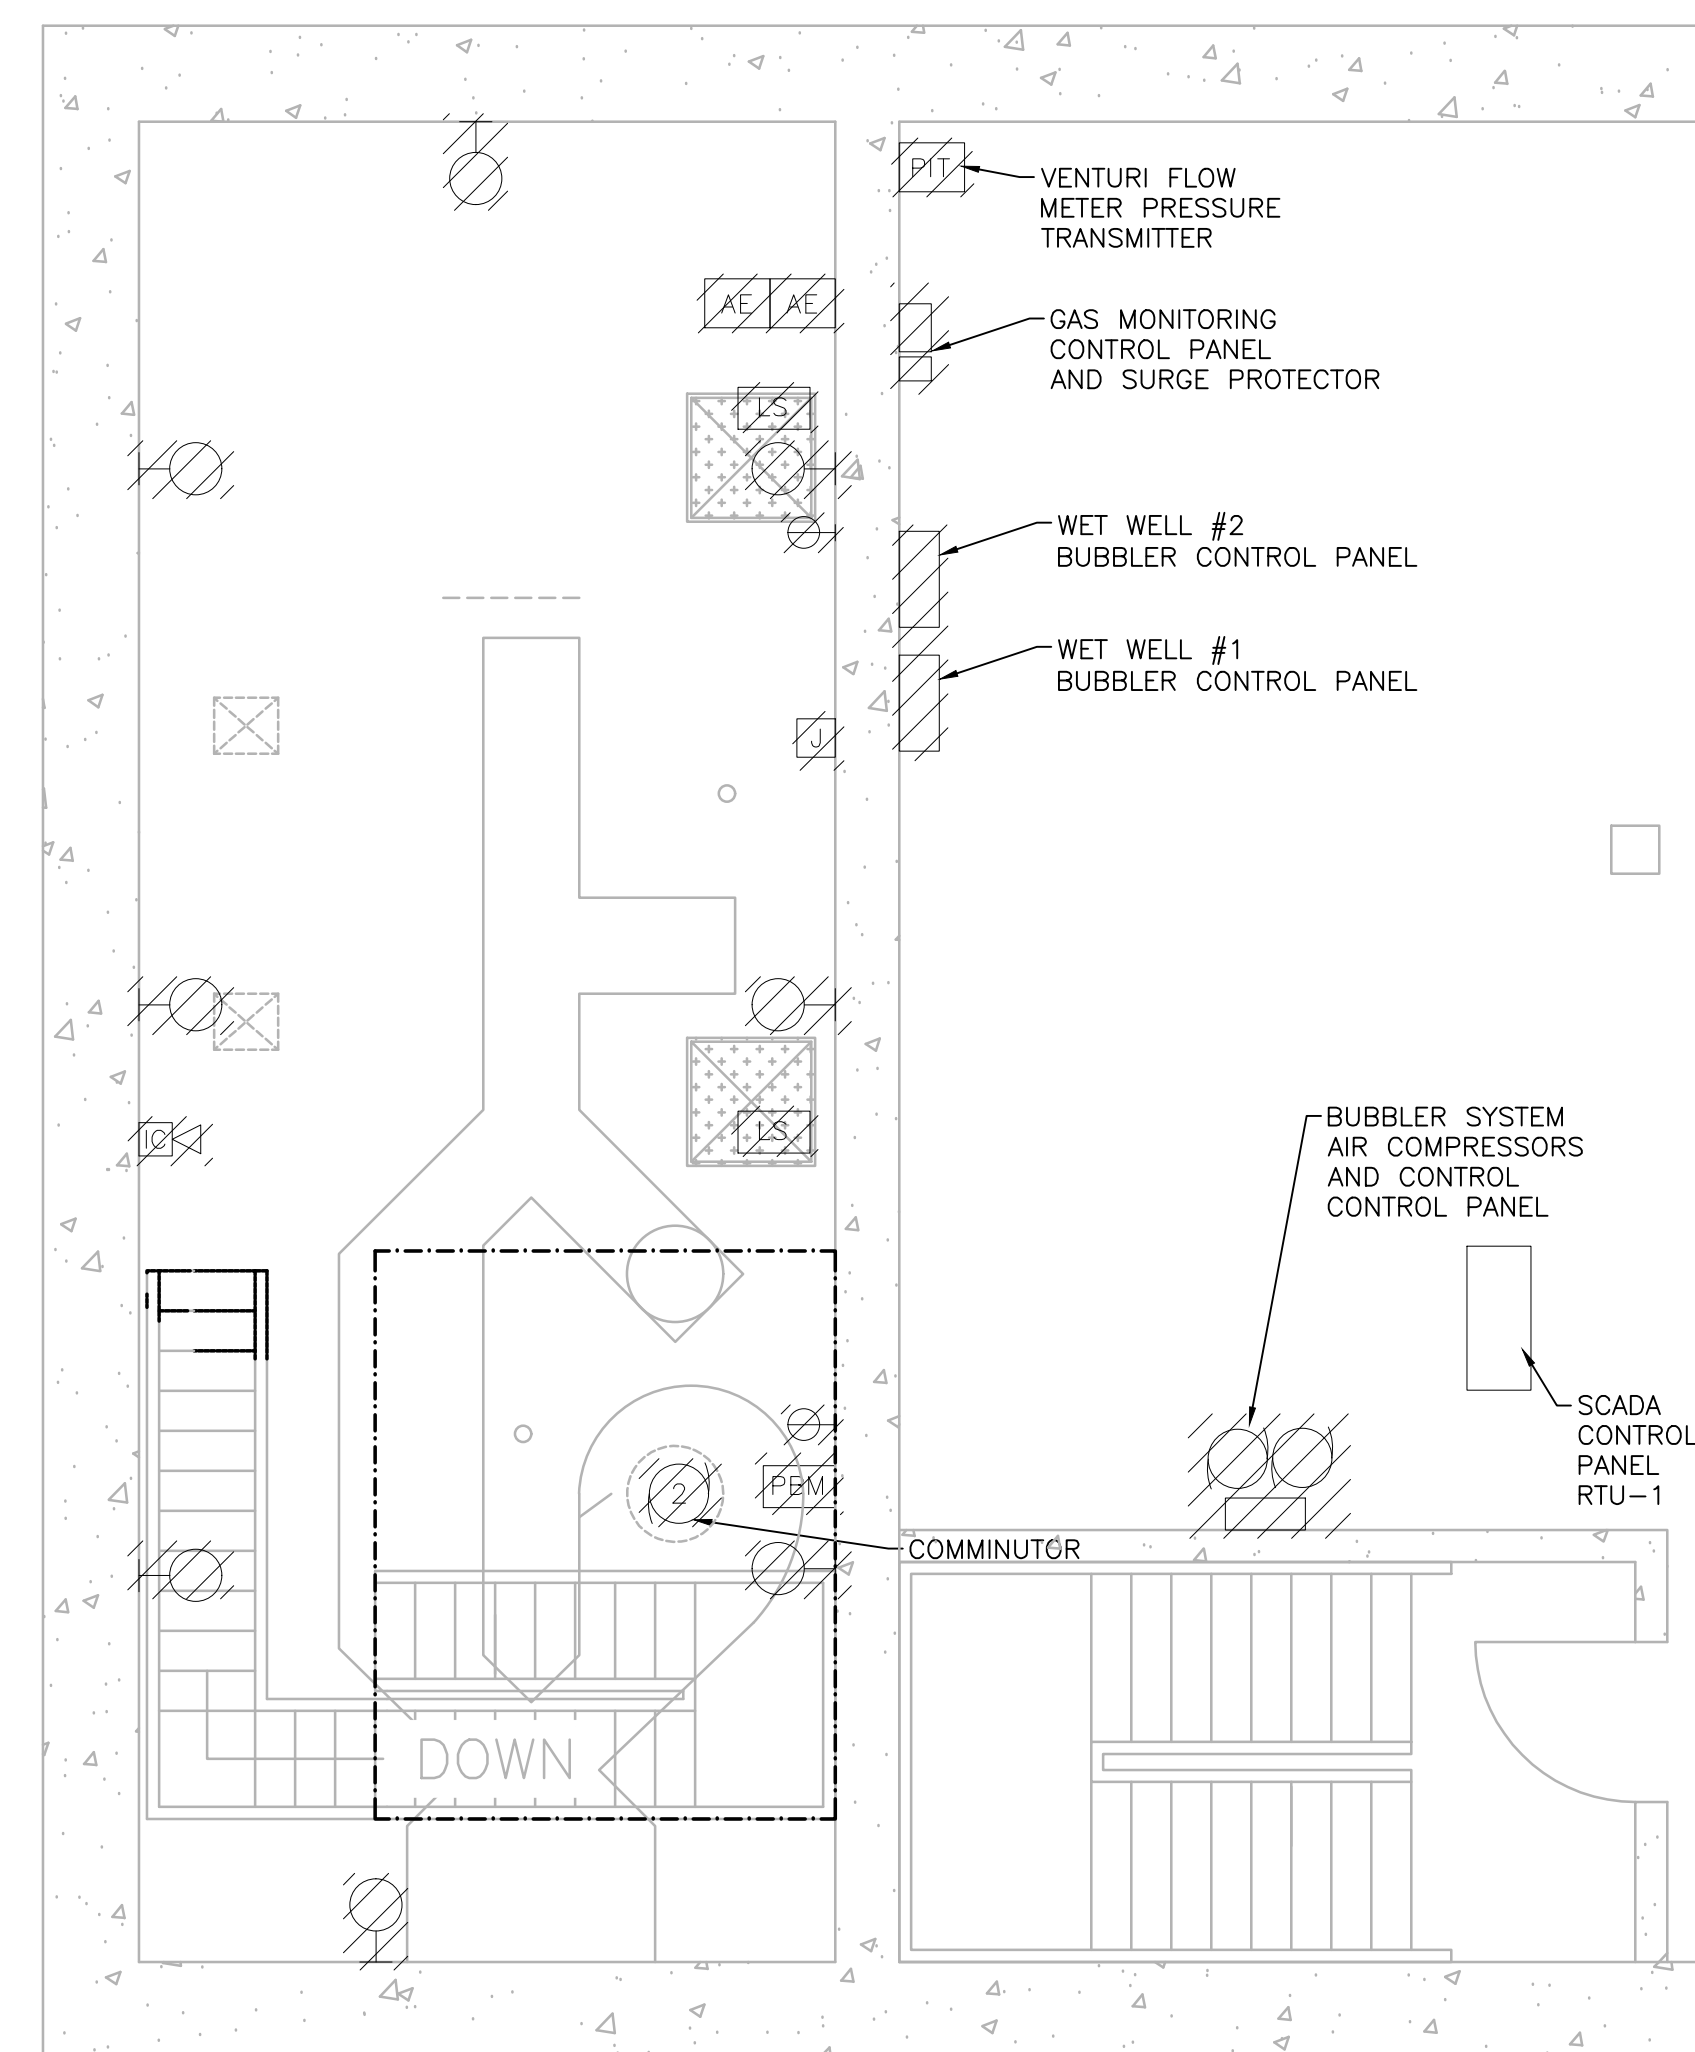

HEADWORKS BASEMENT - DEMOLITION PLAN
SCALE: 1/8" = 1'

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PROJECT

**BURRILLVILLE WWTF
HEADWORKS &
OAKLAND PUMP
STATION
IMPROVEMENTS**

BURRILLVILLE, RI

TITLE

**Operations
Building**
Electrical
Sub Basement and
Basement
Demolition Plans

NO.	REVISIONS	DATE

DRAWN BY: RLB

DESIGNED BY: RLB

CHECKED BY: MC

ISSUE DATE: MAY 2023

BETA JOB NO.: 6861-105


SCALE

AS SHOWN


UNLESS OTHERWISE NOTED OR CHANGED BY REPRODUCTION

SHEET NO.

E-1.1

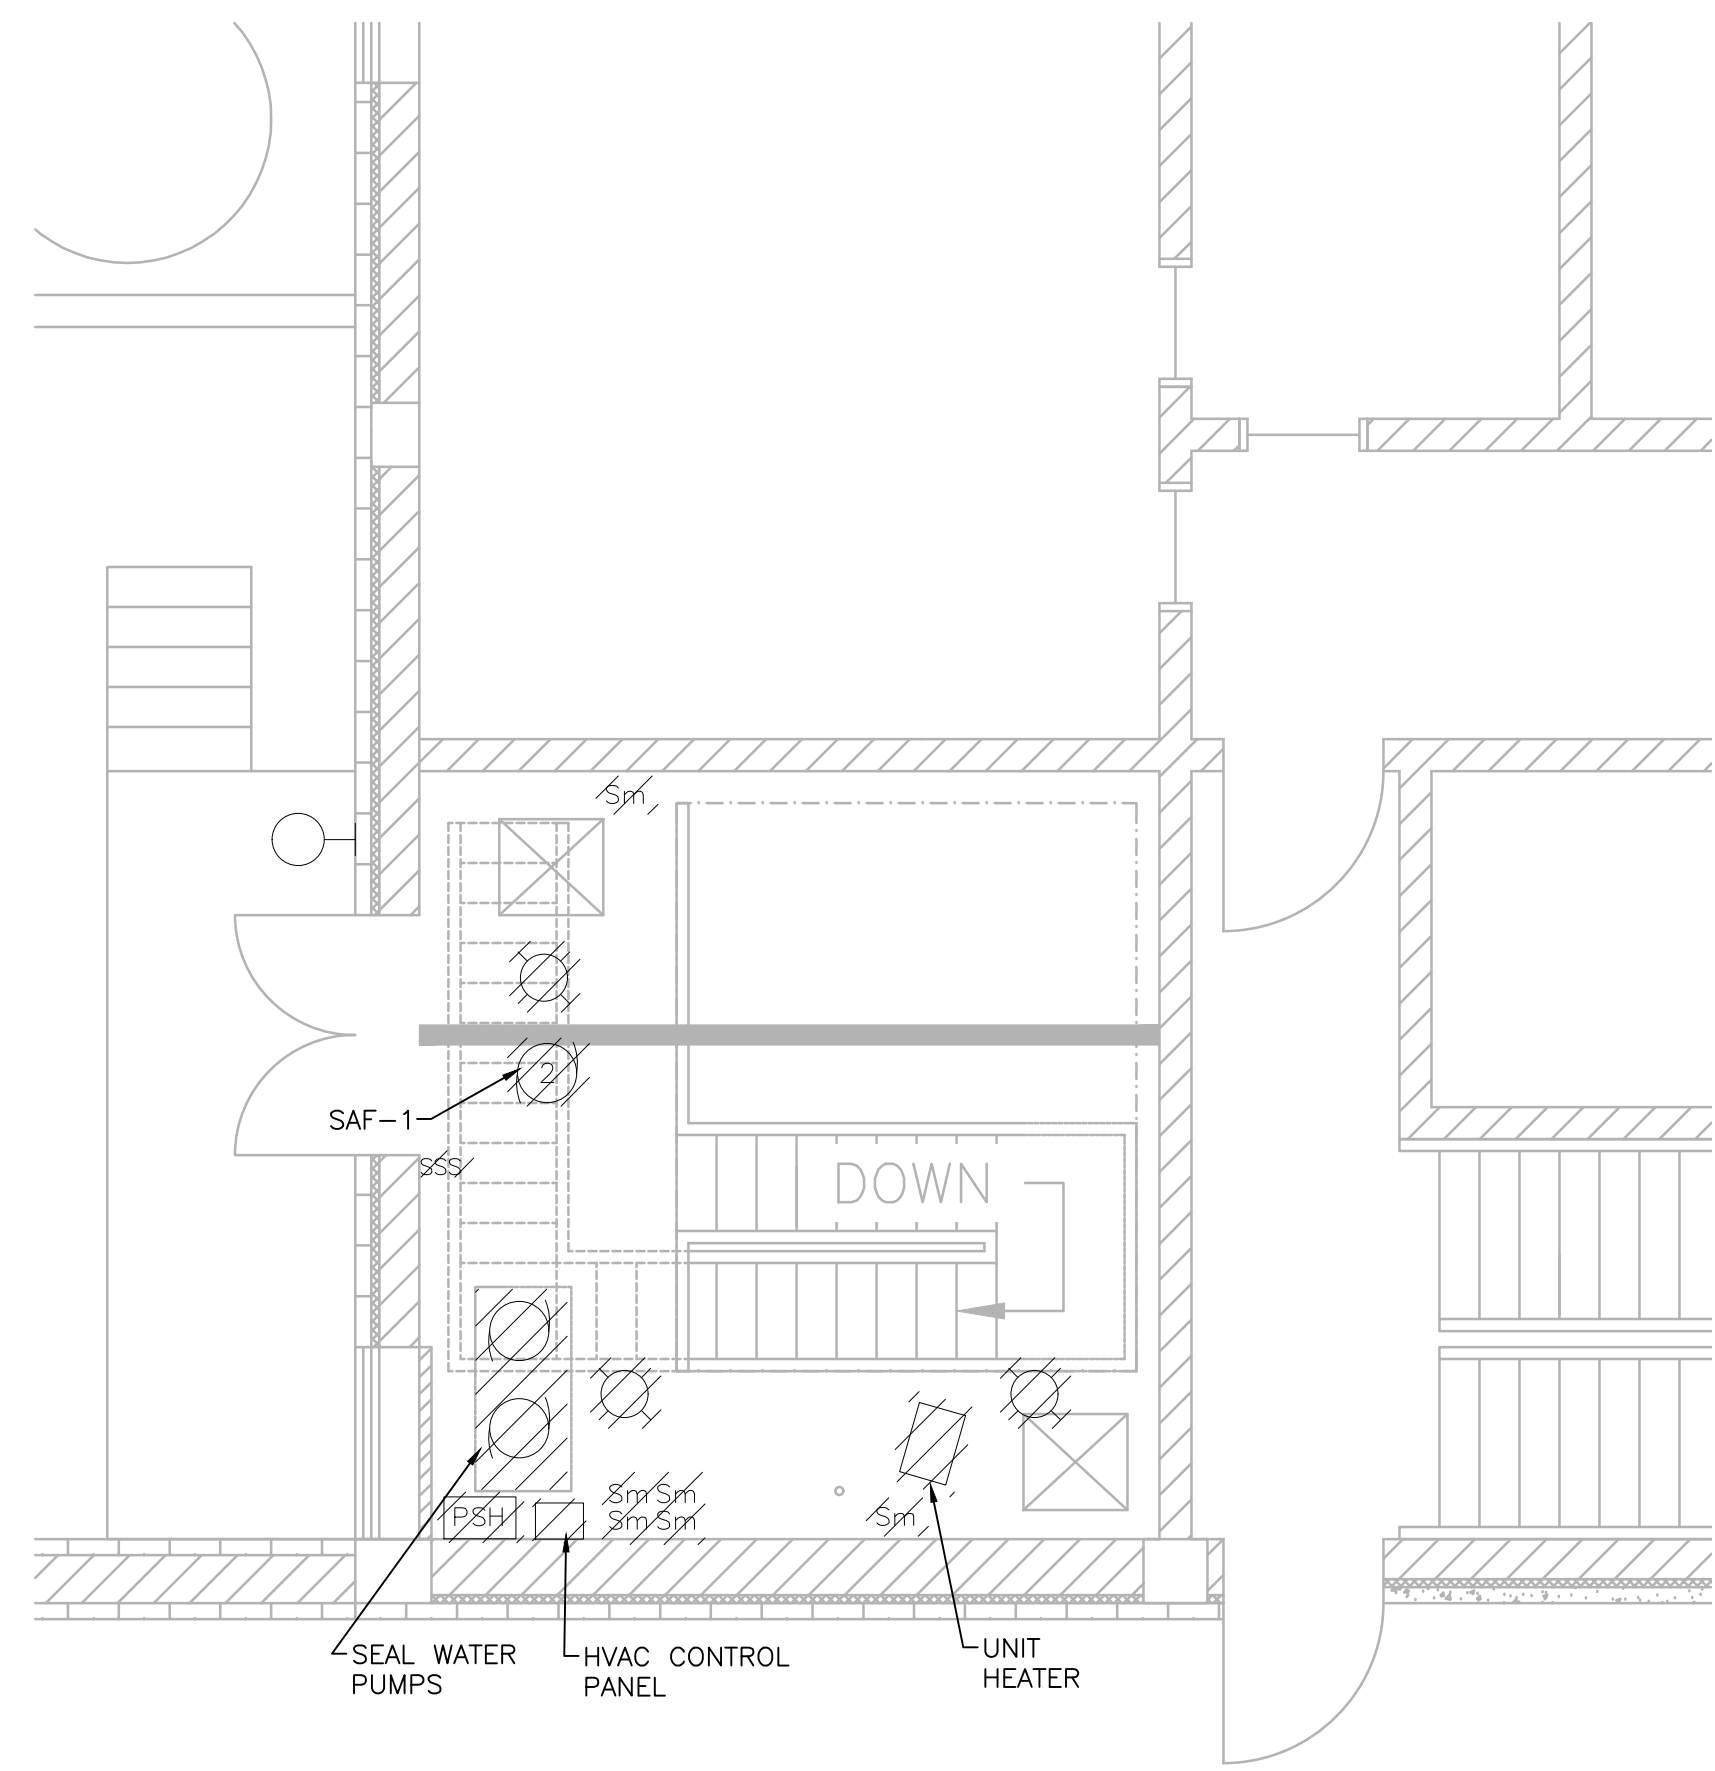

HEADWORKS FIRST FLOOR - DEMOLITION PLAN
SCALE: 1/4" = 1'

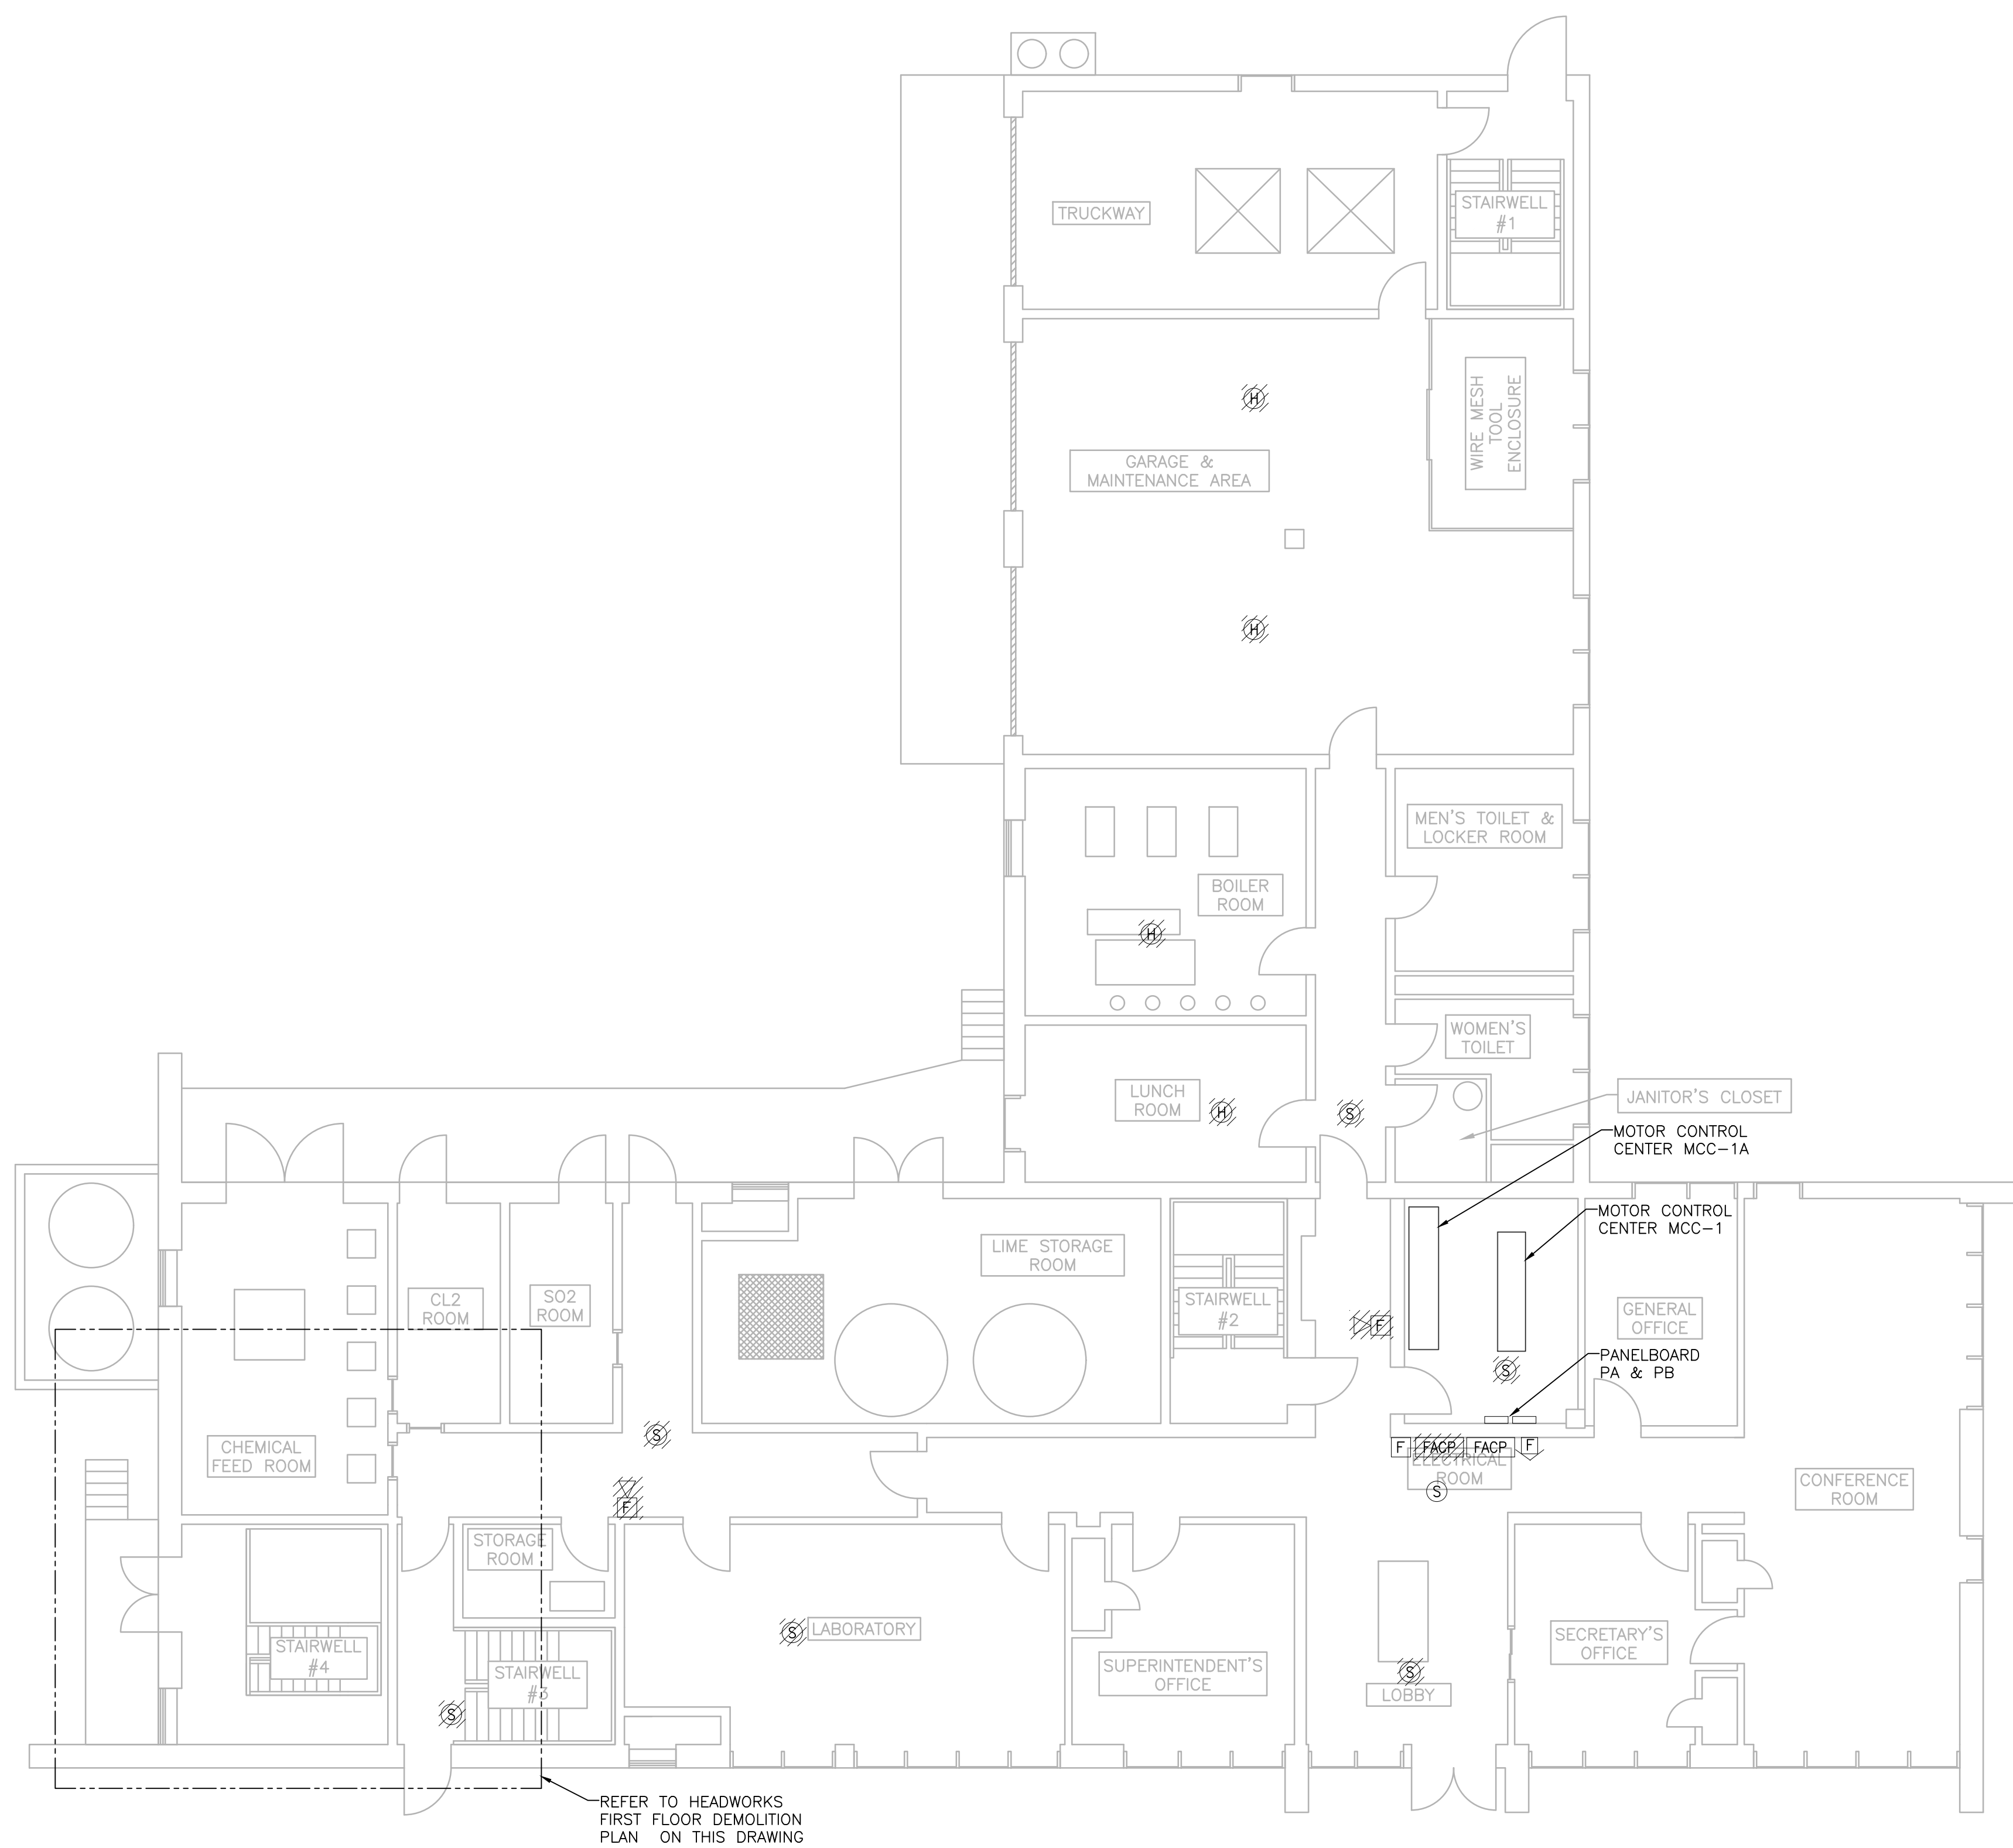


FIRST FLOOR - DEMOLITION PLAN
SCALE: 1/8" = 1'

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PROJECT

**BURRILLVILLE WWTF
HEADWORKS &
OAKLAND PUMP
STATION
IMPROVEMENTS**

BURRILLVILLE, RI

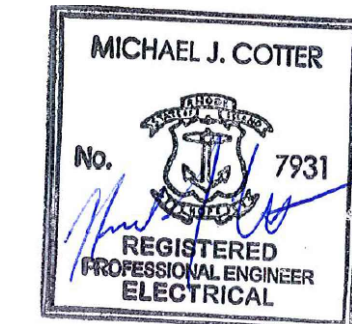TITLE

**Operations
Building**
Electrical
First Floor
Demolition Plan

NO.	REVISIONS	DATE

DRAWN BY: RLB

DESIGNED BY: RLB

CHECKED BY: MC

ISSUE DATE: MAY 2023

BETA JOB NO.: 6861-105

SCALE

AS SHOWN

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SHEET NO.


E-1.2

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PROJECT

**BURRILLVILLE WWTF
HEADWORKS &
OAKLAND PUMP
STATION
IMPROVEMENTS**

BURRILLVILLE, RI

TITLE

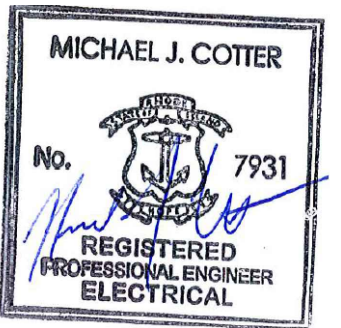**Operations
Building**
Electrical
2nd Floor
Demolition Plan

NO.	REVISIONS	DATE

DRAWN BY: RLB

DESIGNED BY: RLB

CHECKED BY: MC

ISSUE DATE: MAY 2023

BETA JOB NO.: 6861-105

SCALE

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SHEET NO.

E-1.3



2ND FLOOR - DEMOLITION PLAN
SCALE: 1/8" = 1'



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**BURRILLVILLE WWTF
 HEADWORKS &
 OAKLAND PUMP
 STATION
 IMPROVEMENTS**

BURRILLVILLE, RI

**Operations
 Building
 Electrical
 Sub Basement and
 Basement
 Plans**


NO.	REVISIONS	DATE

DRAWN BY: RLB
 DESIGNED BY: RLB
 CHECKED BY: MC
 ISSUE DATE: MAY 2023
 BETA JOB NO.: 6861-105


AS SHOWN

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E-1.4

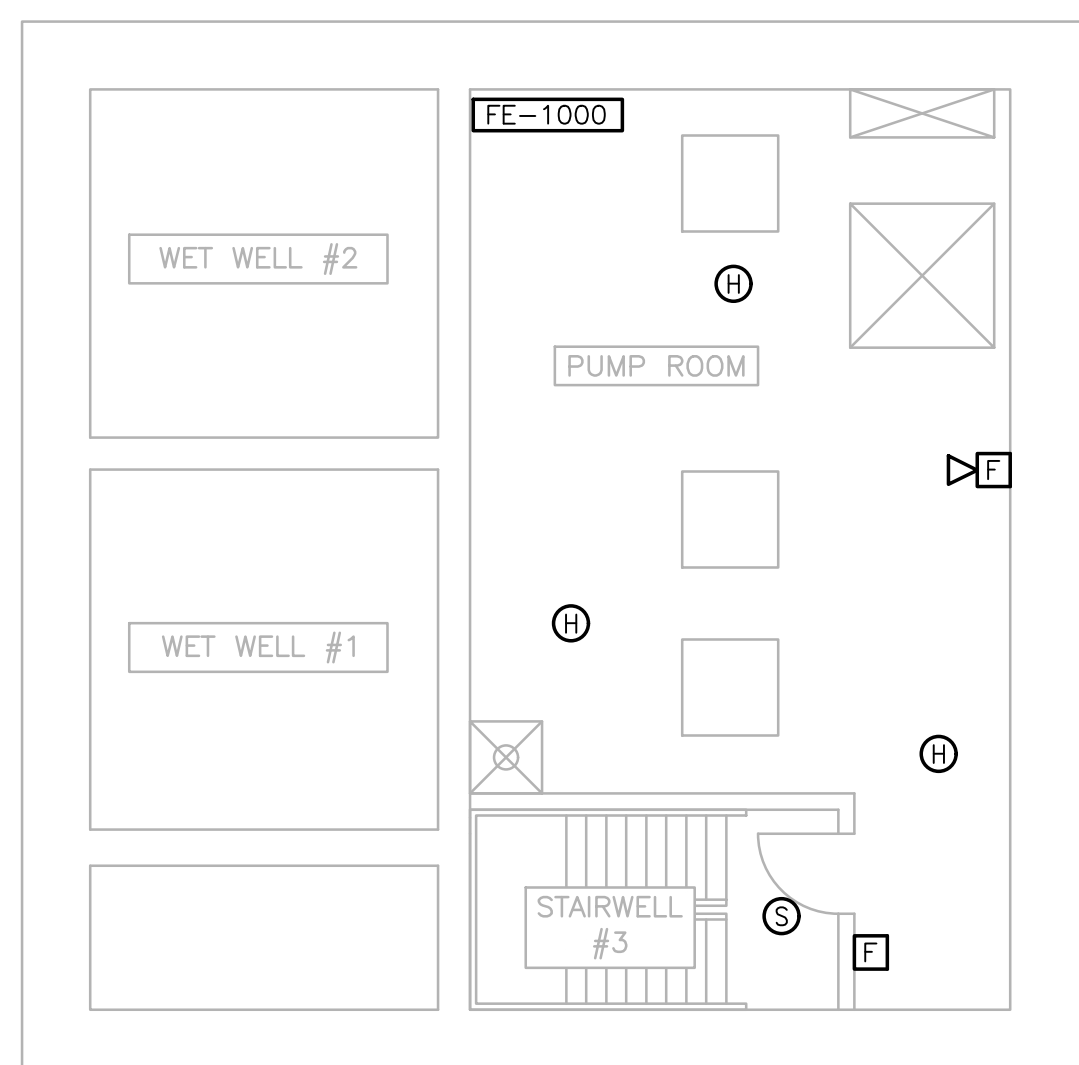


SUB BASEMENT - PLAN
 SCALE: 1/8" = 1'

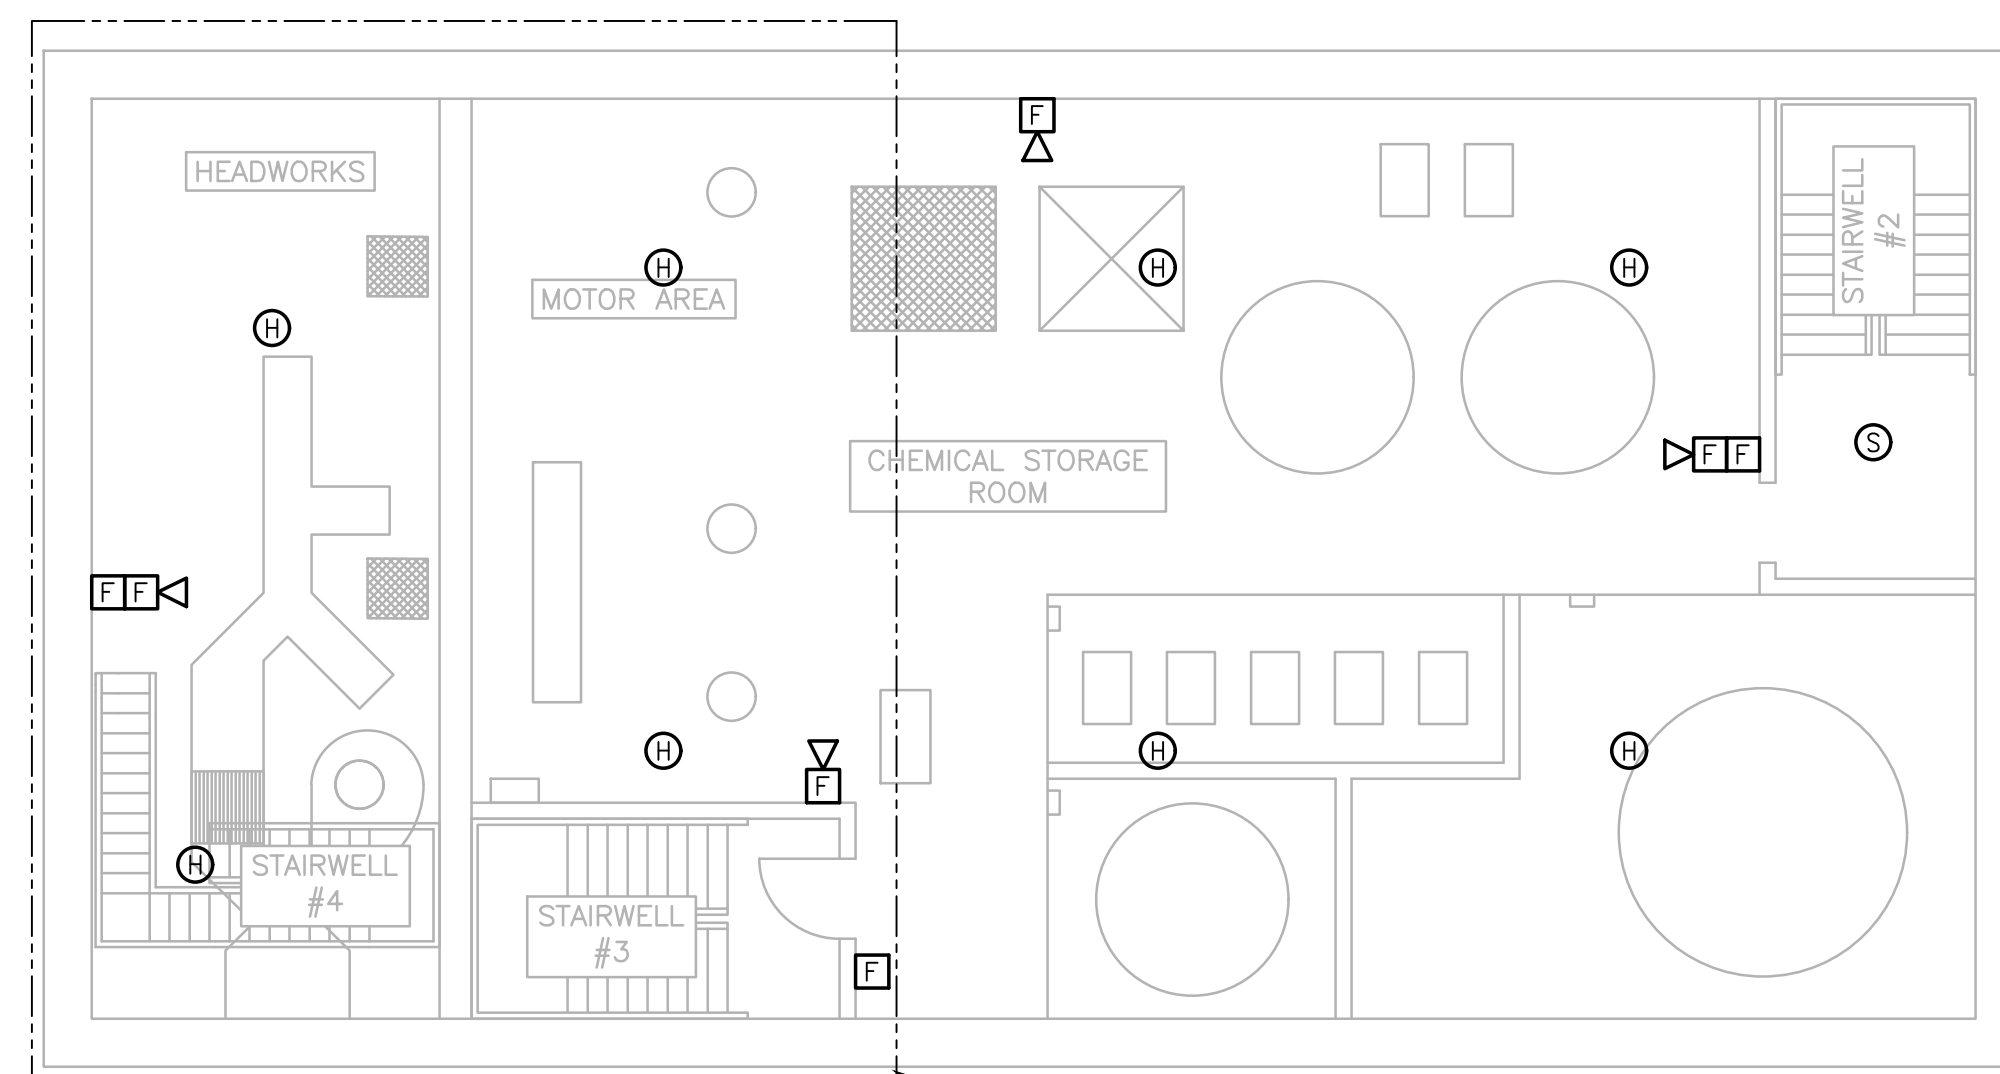


BASEMENT - PLAN
 SCALE: 1/8" = 1'


REFER TO HEADWORKS
 BASEMENT PLANS ON THIS
 DRAWING

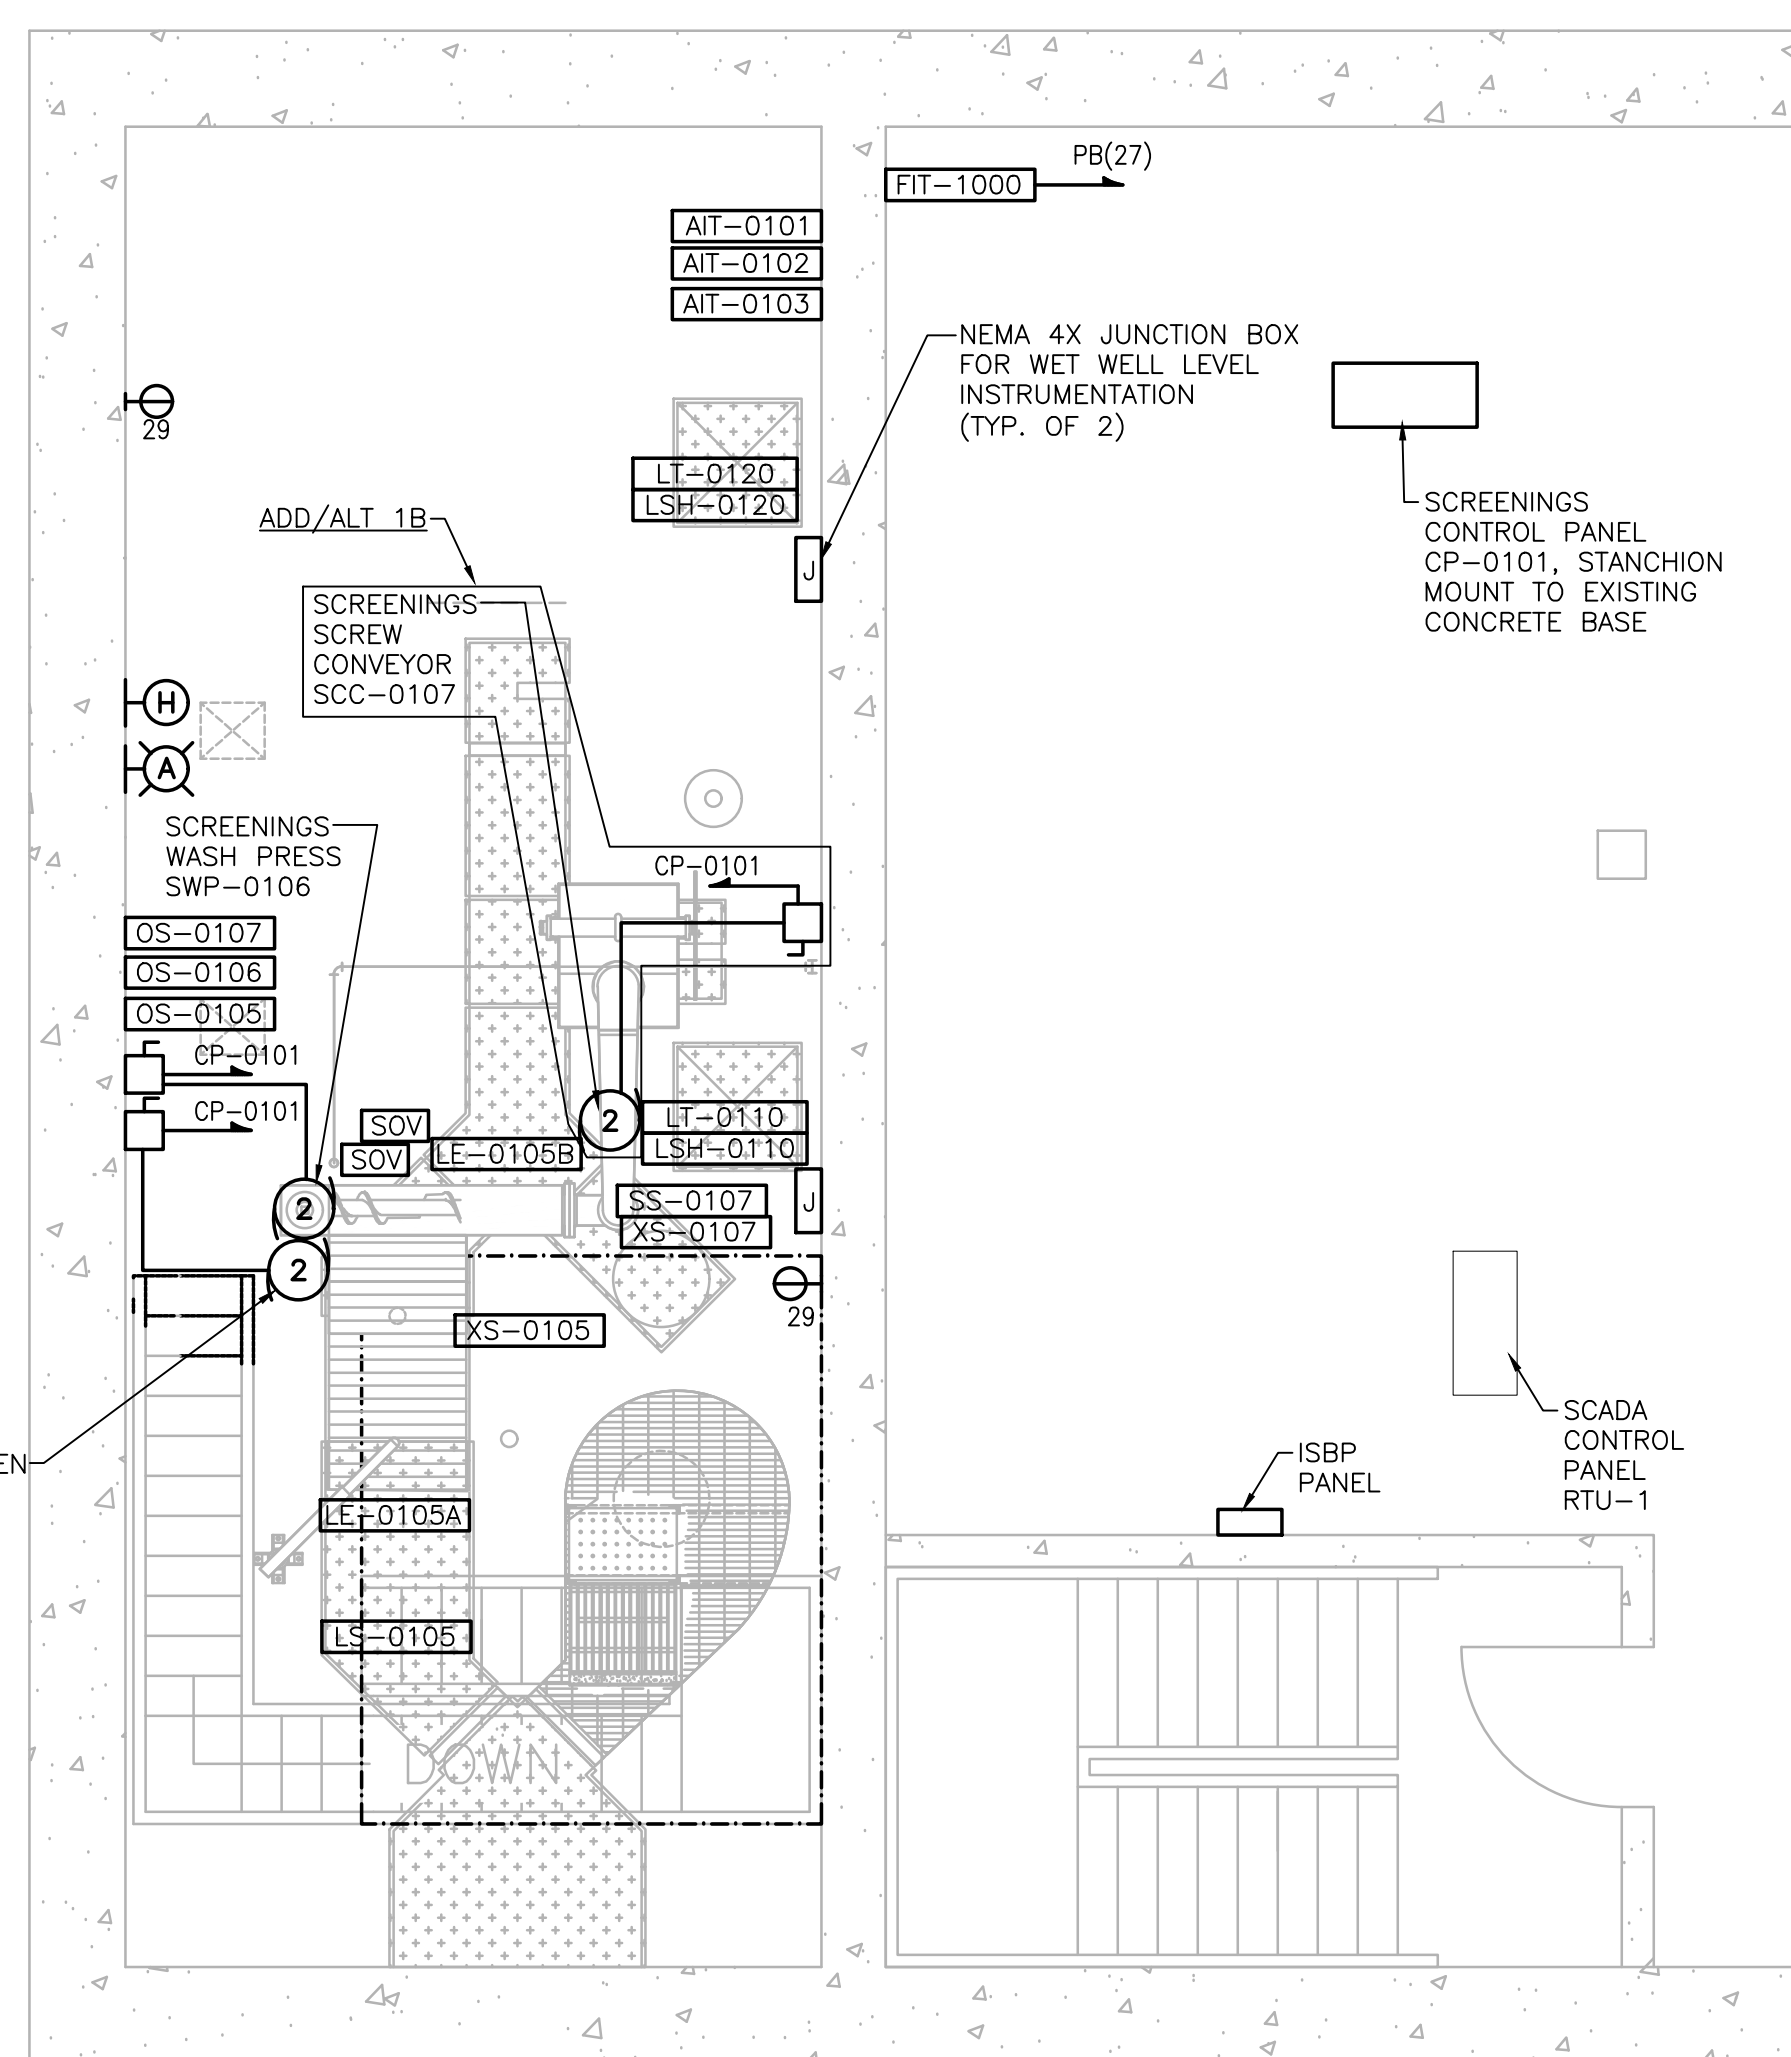


HEADWORKS BASEMENT - POWER PLAN
 SCALE: 1/8" = 1'

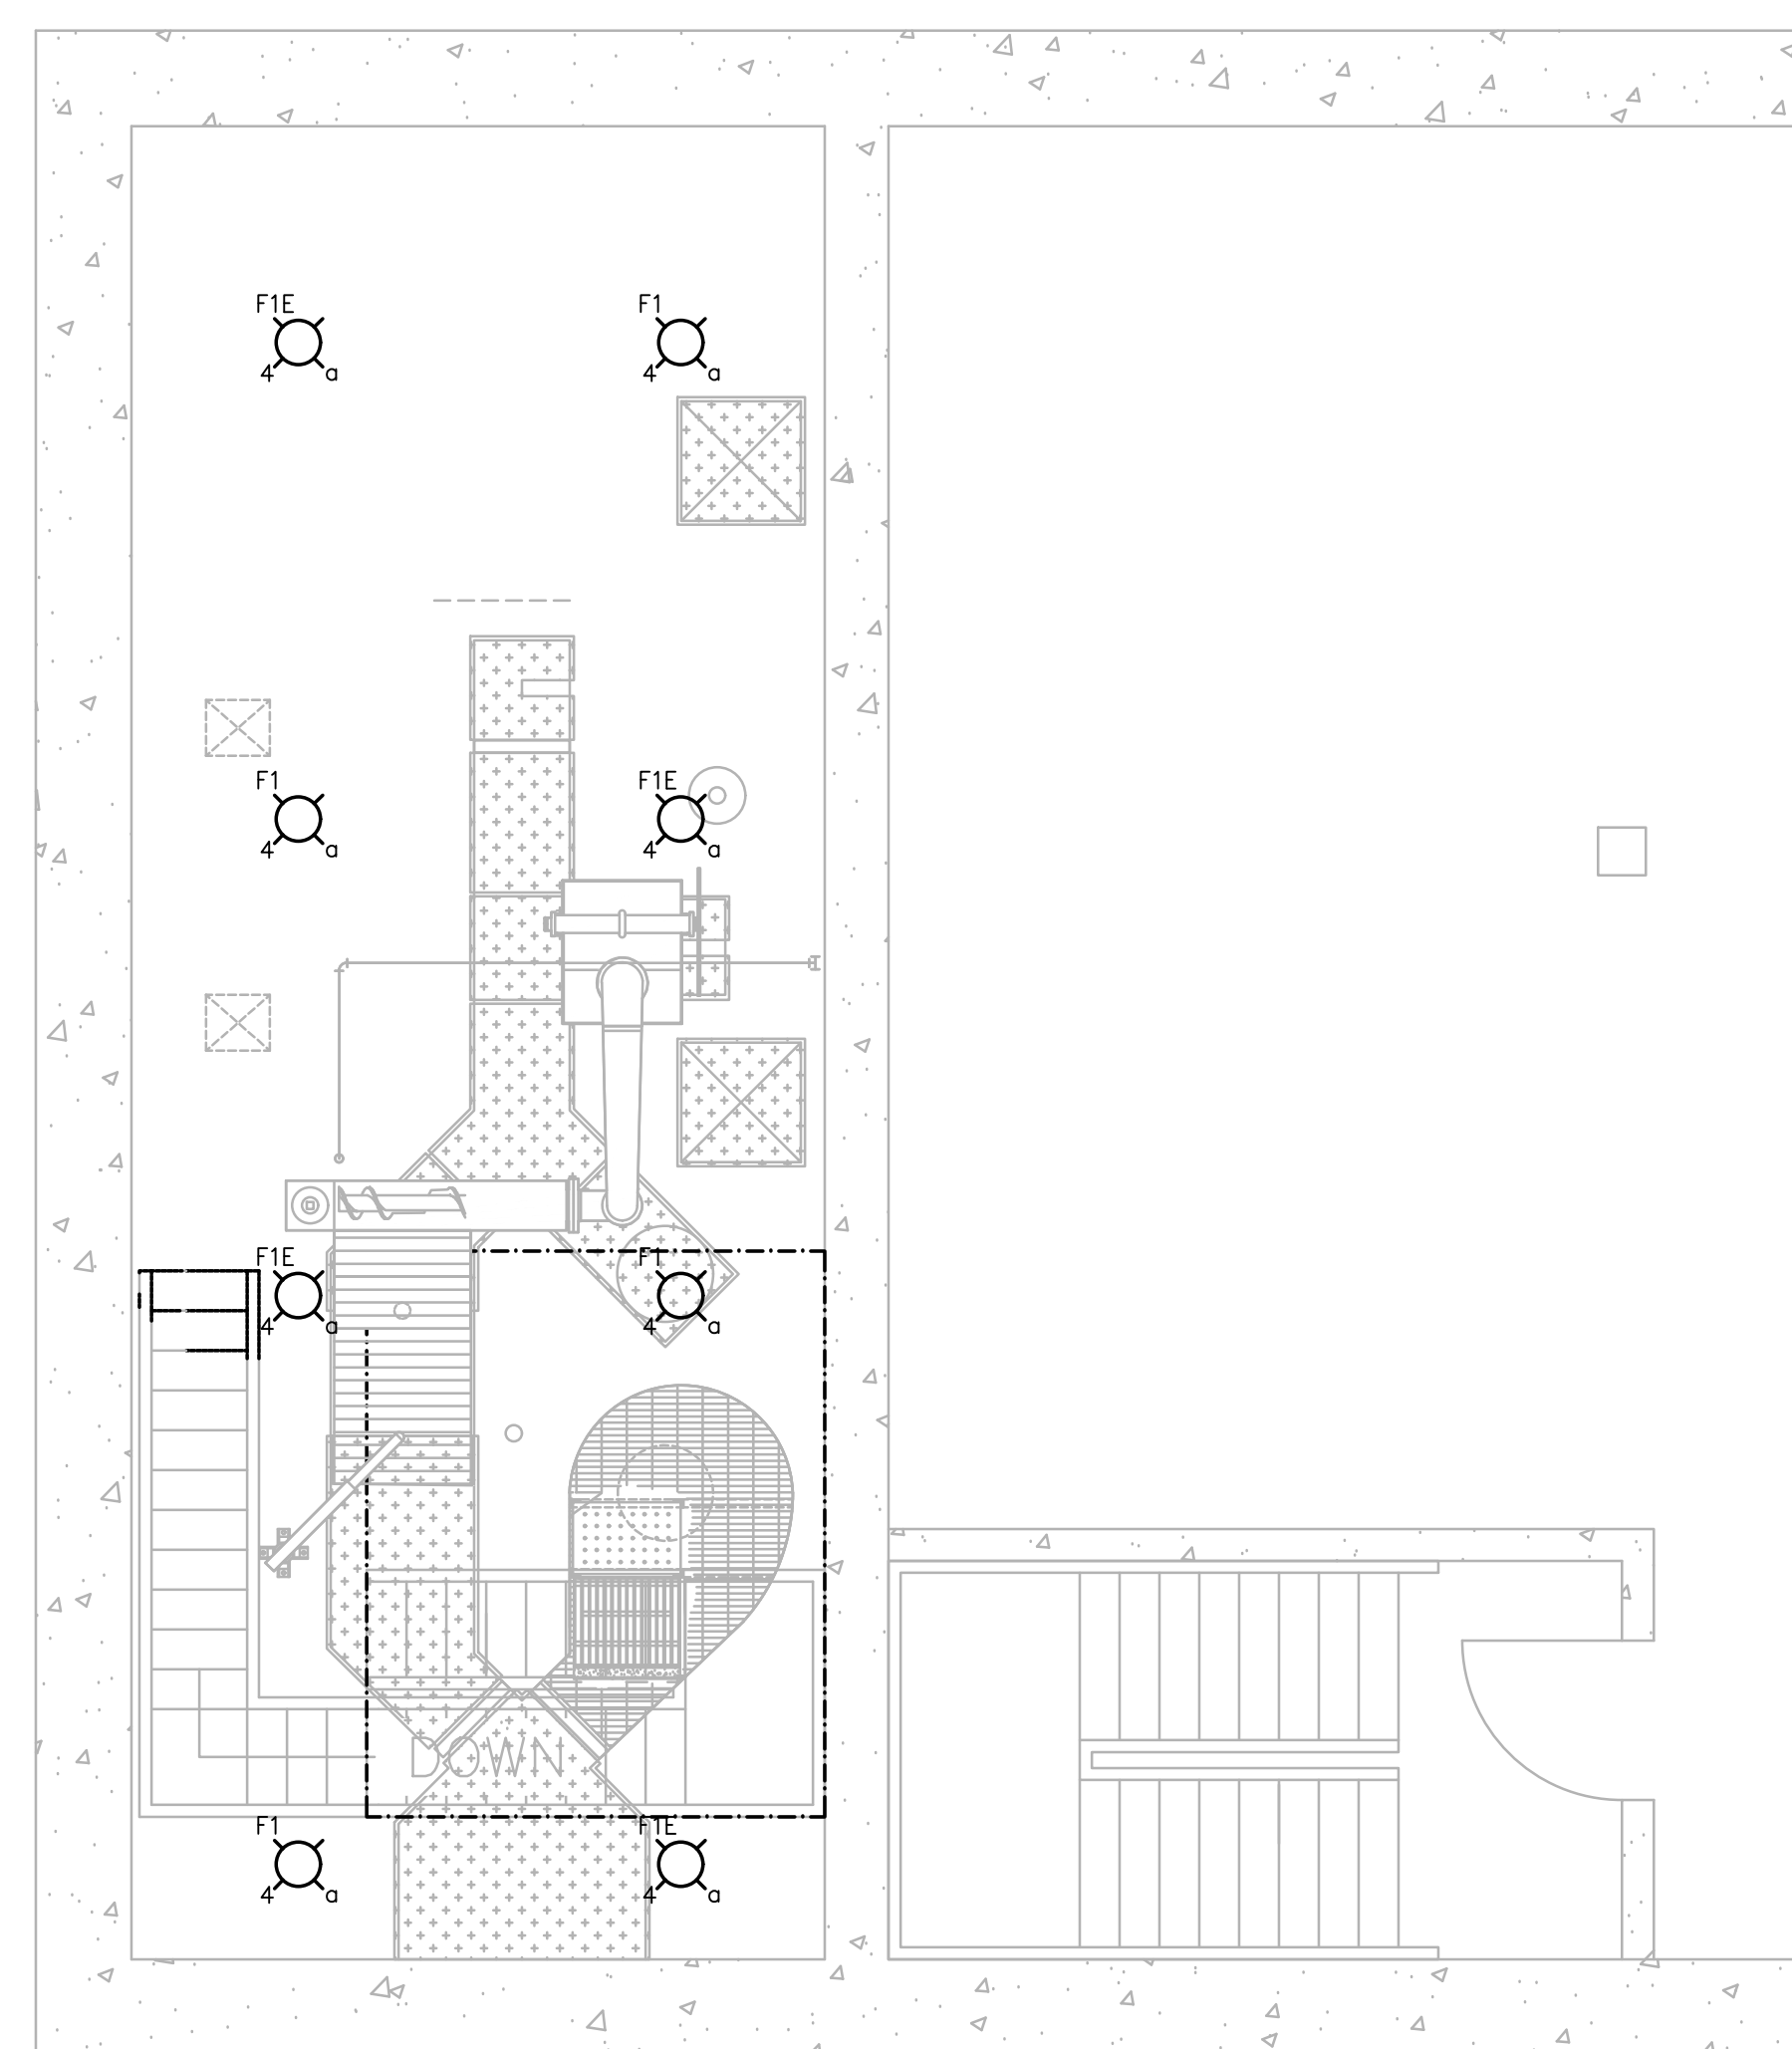


HEADWORKS BASEMENT - LIGHTING PLAN
 SCALE: 1/8" = 1'

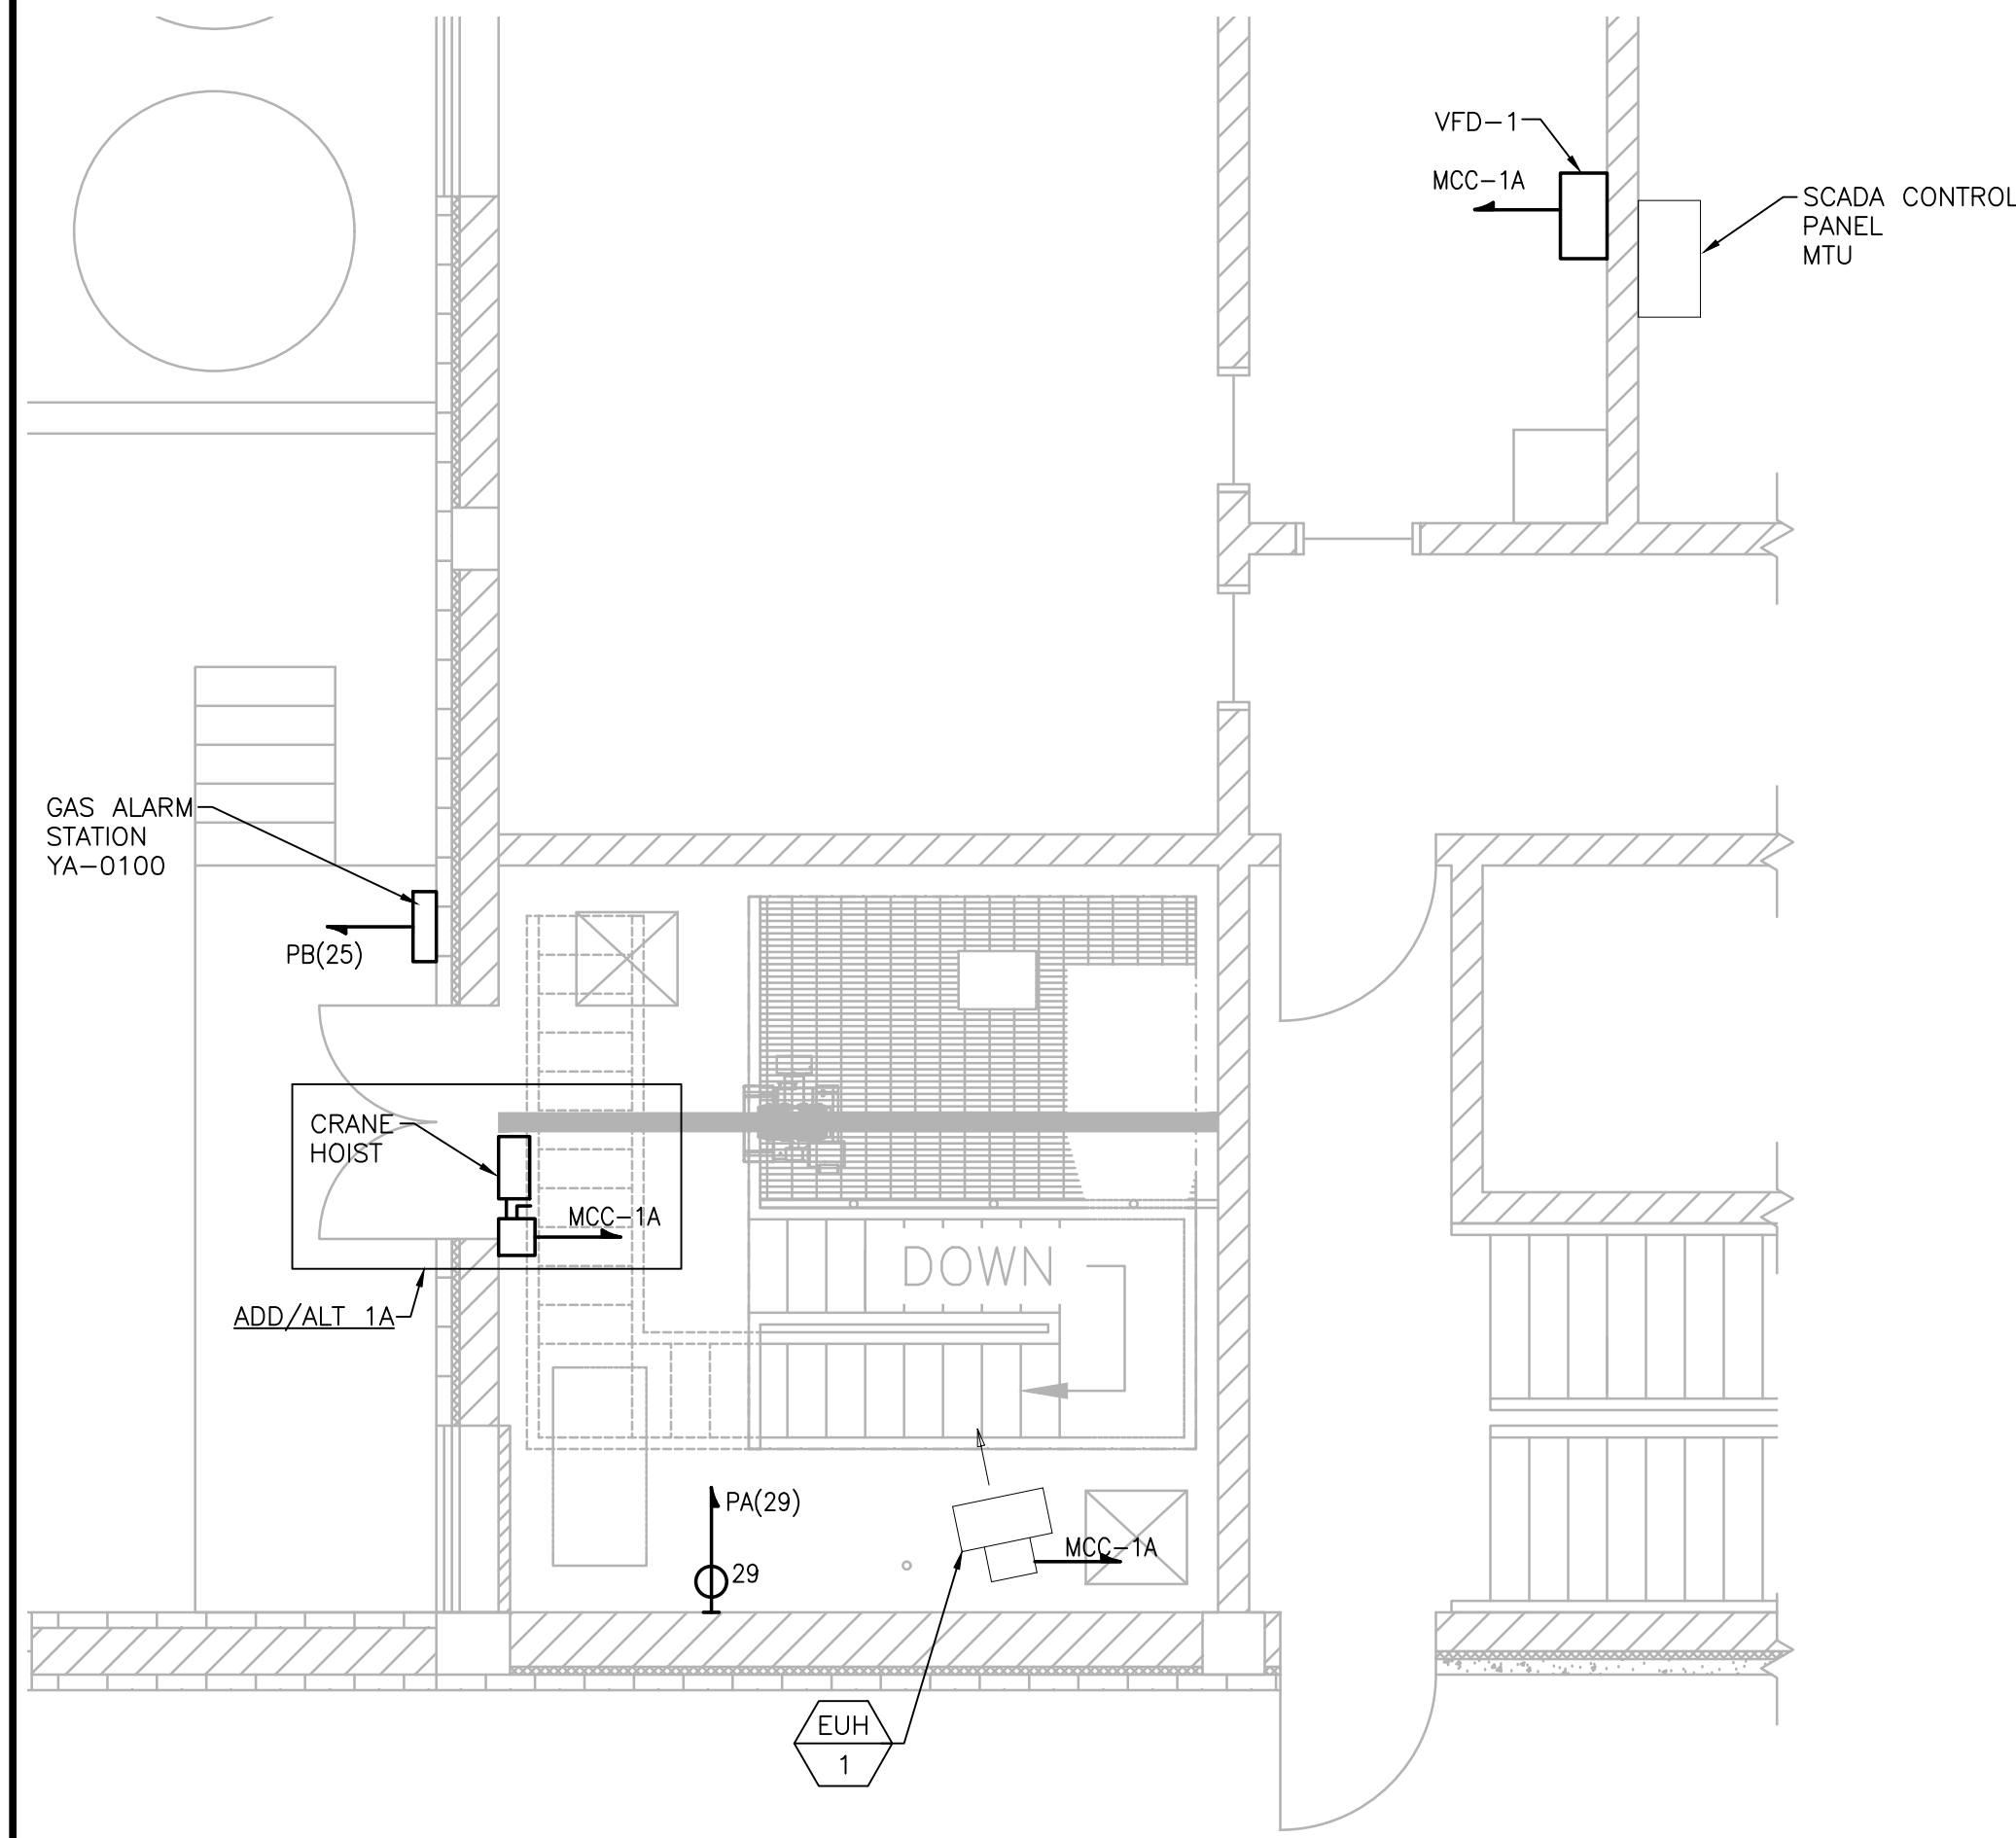

HEADWORKS FIRST FLOOR - POWER PLAN
SCALE: 1/4" = 1'

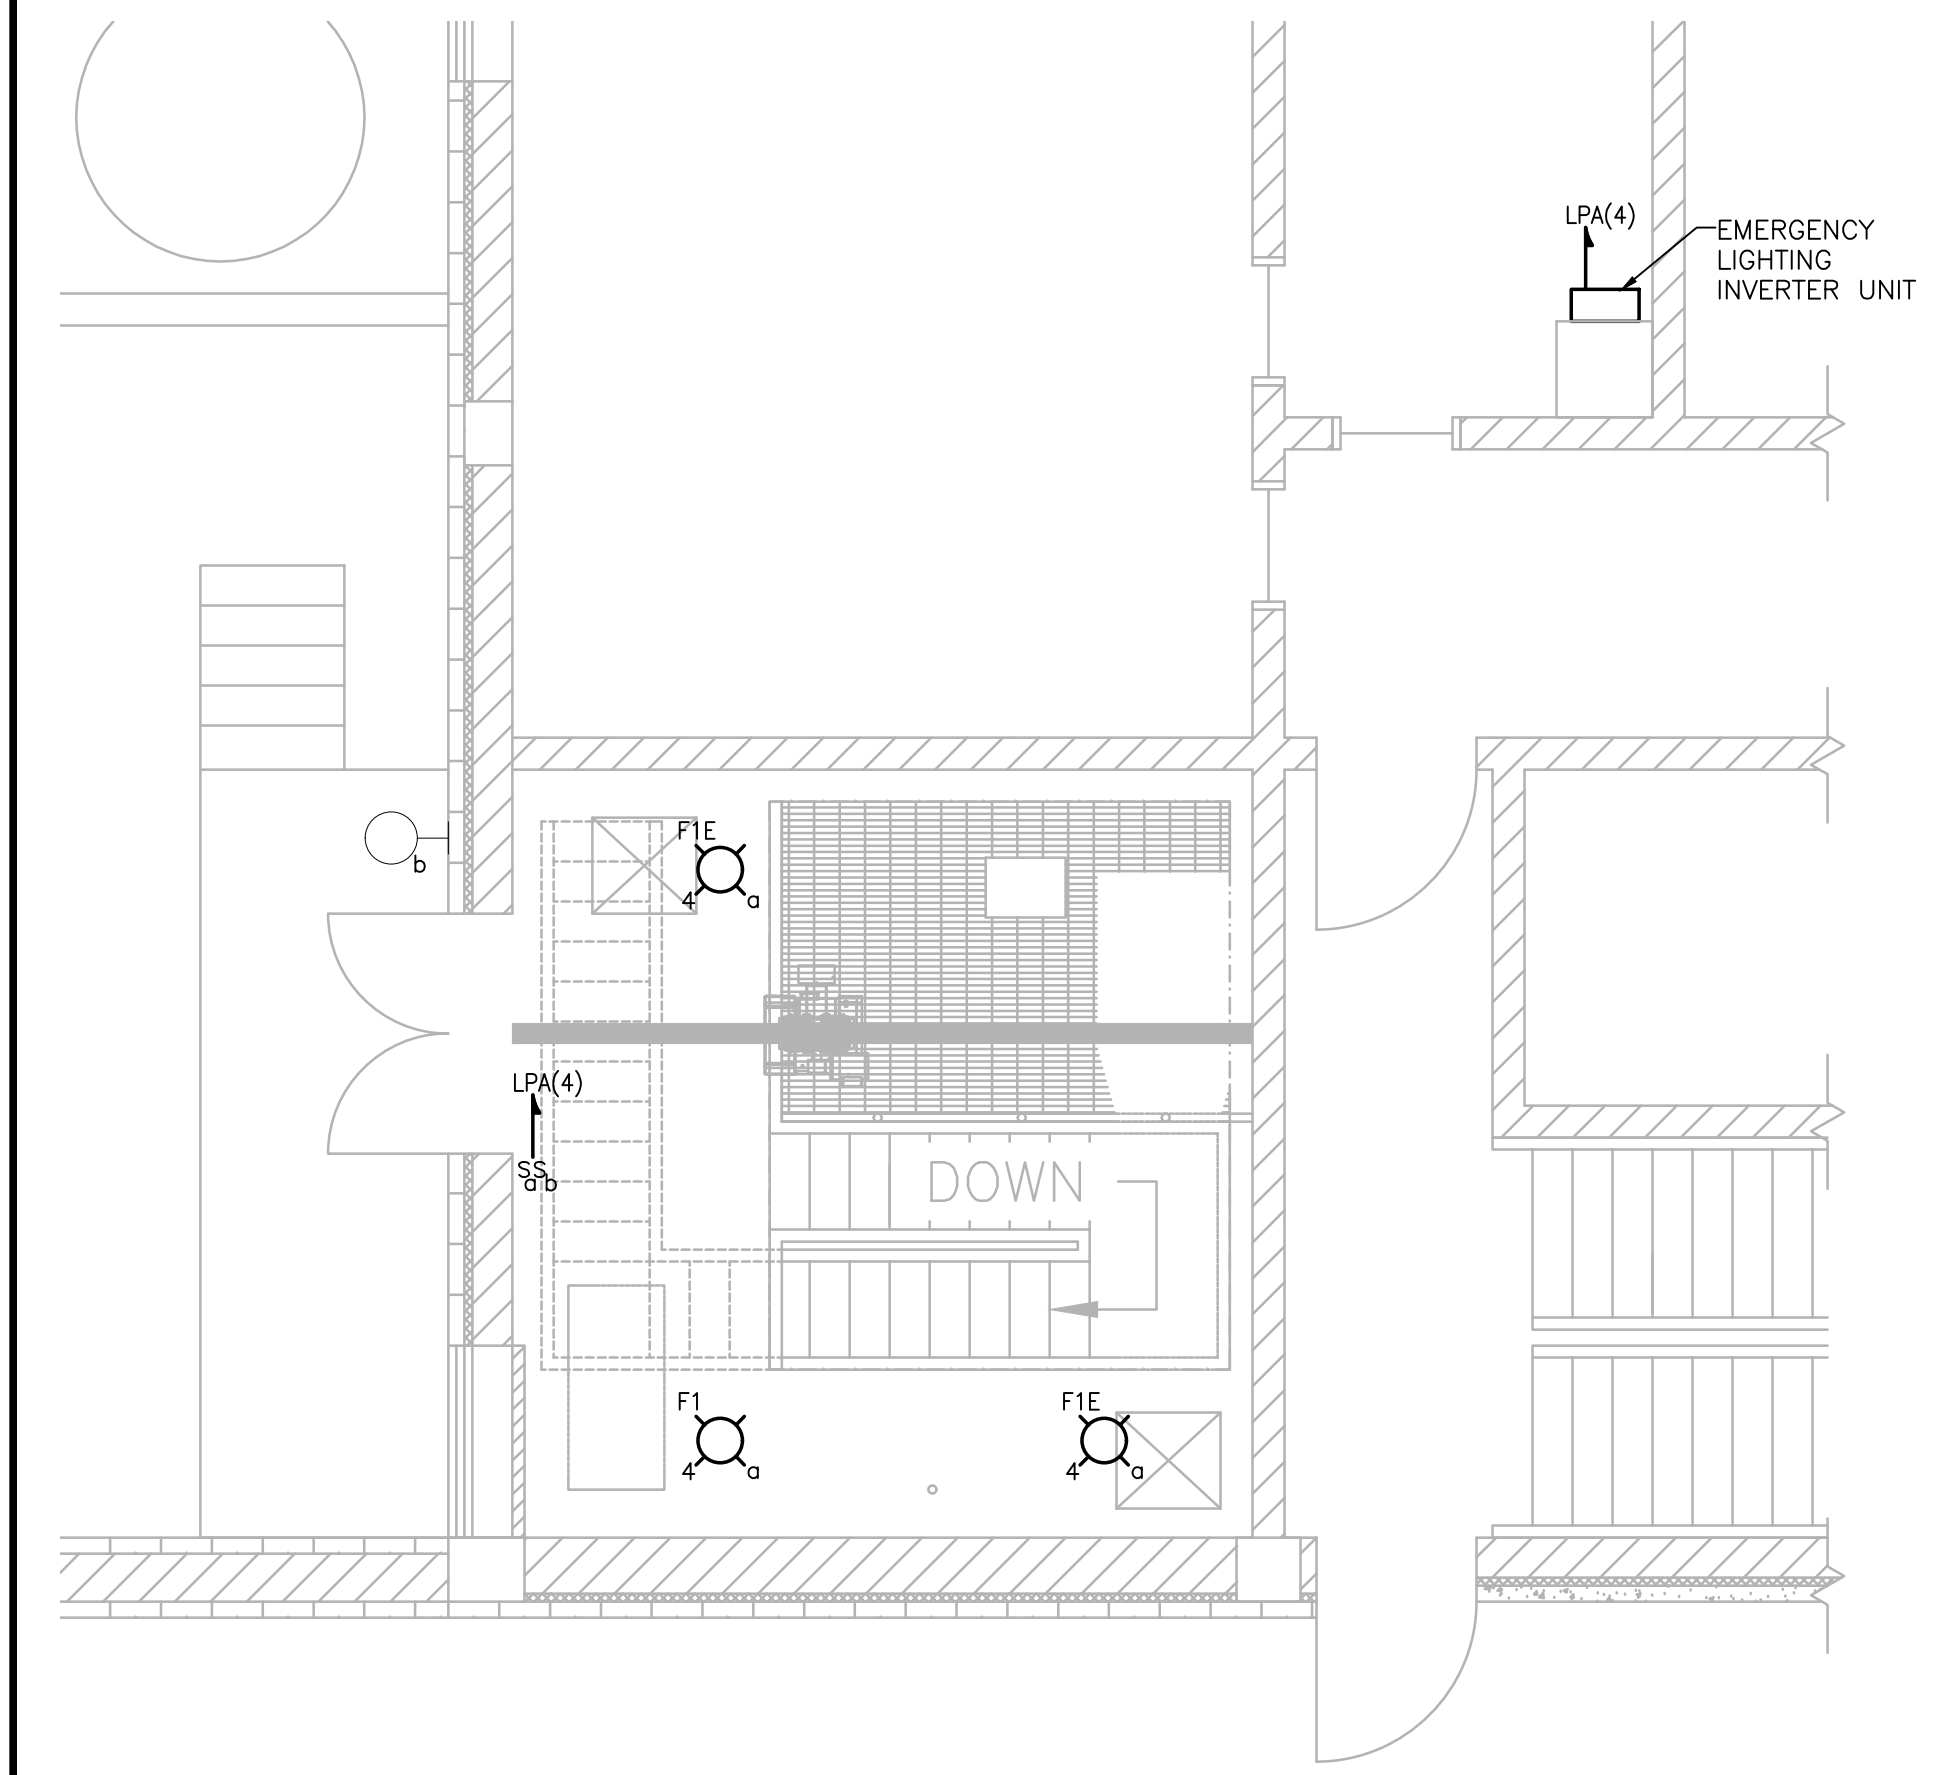

HEADWORKS FIRST FLOOR - LIGHTING PLAN
SCALE: 1/4" = 1'

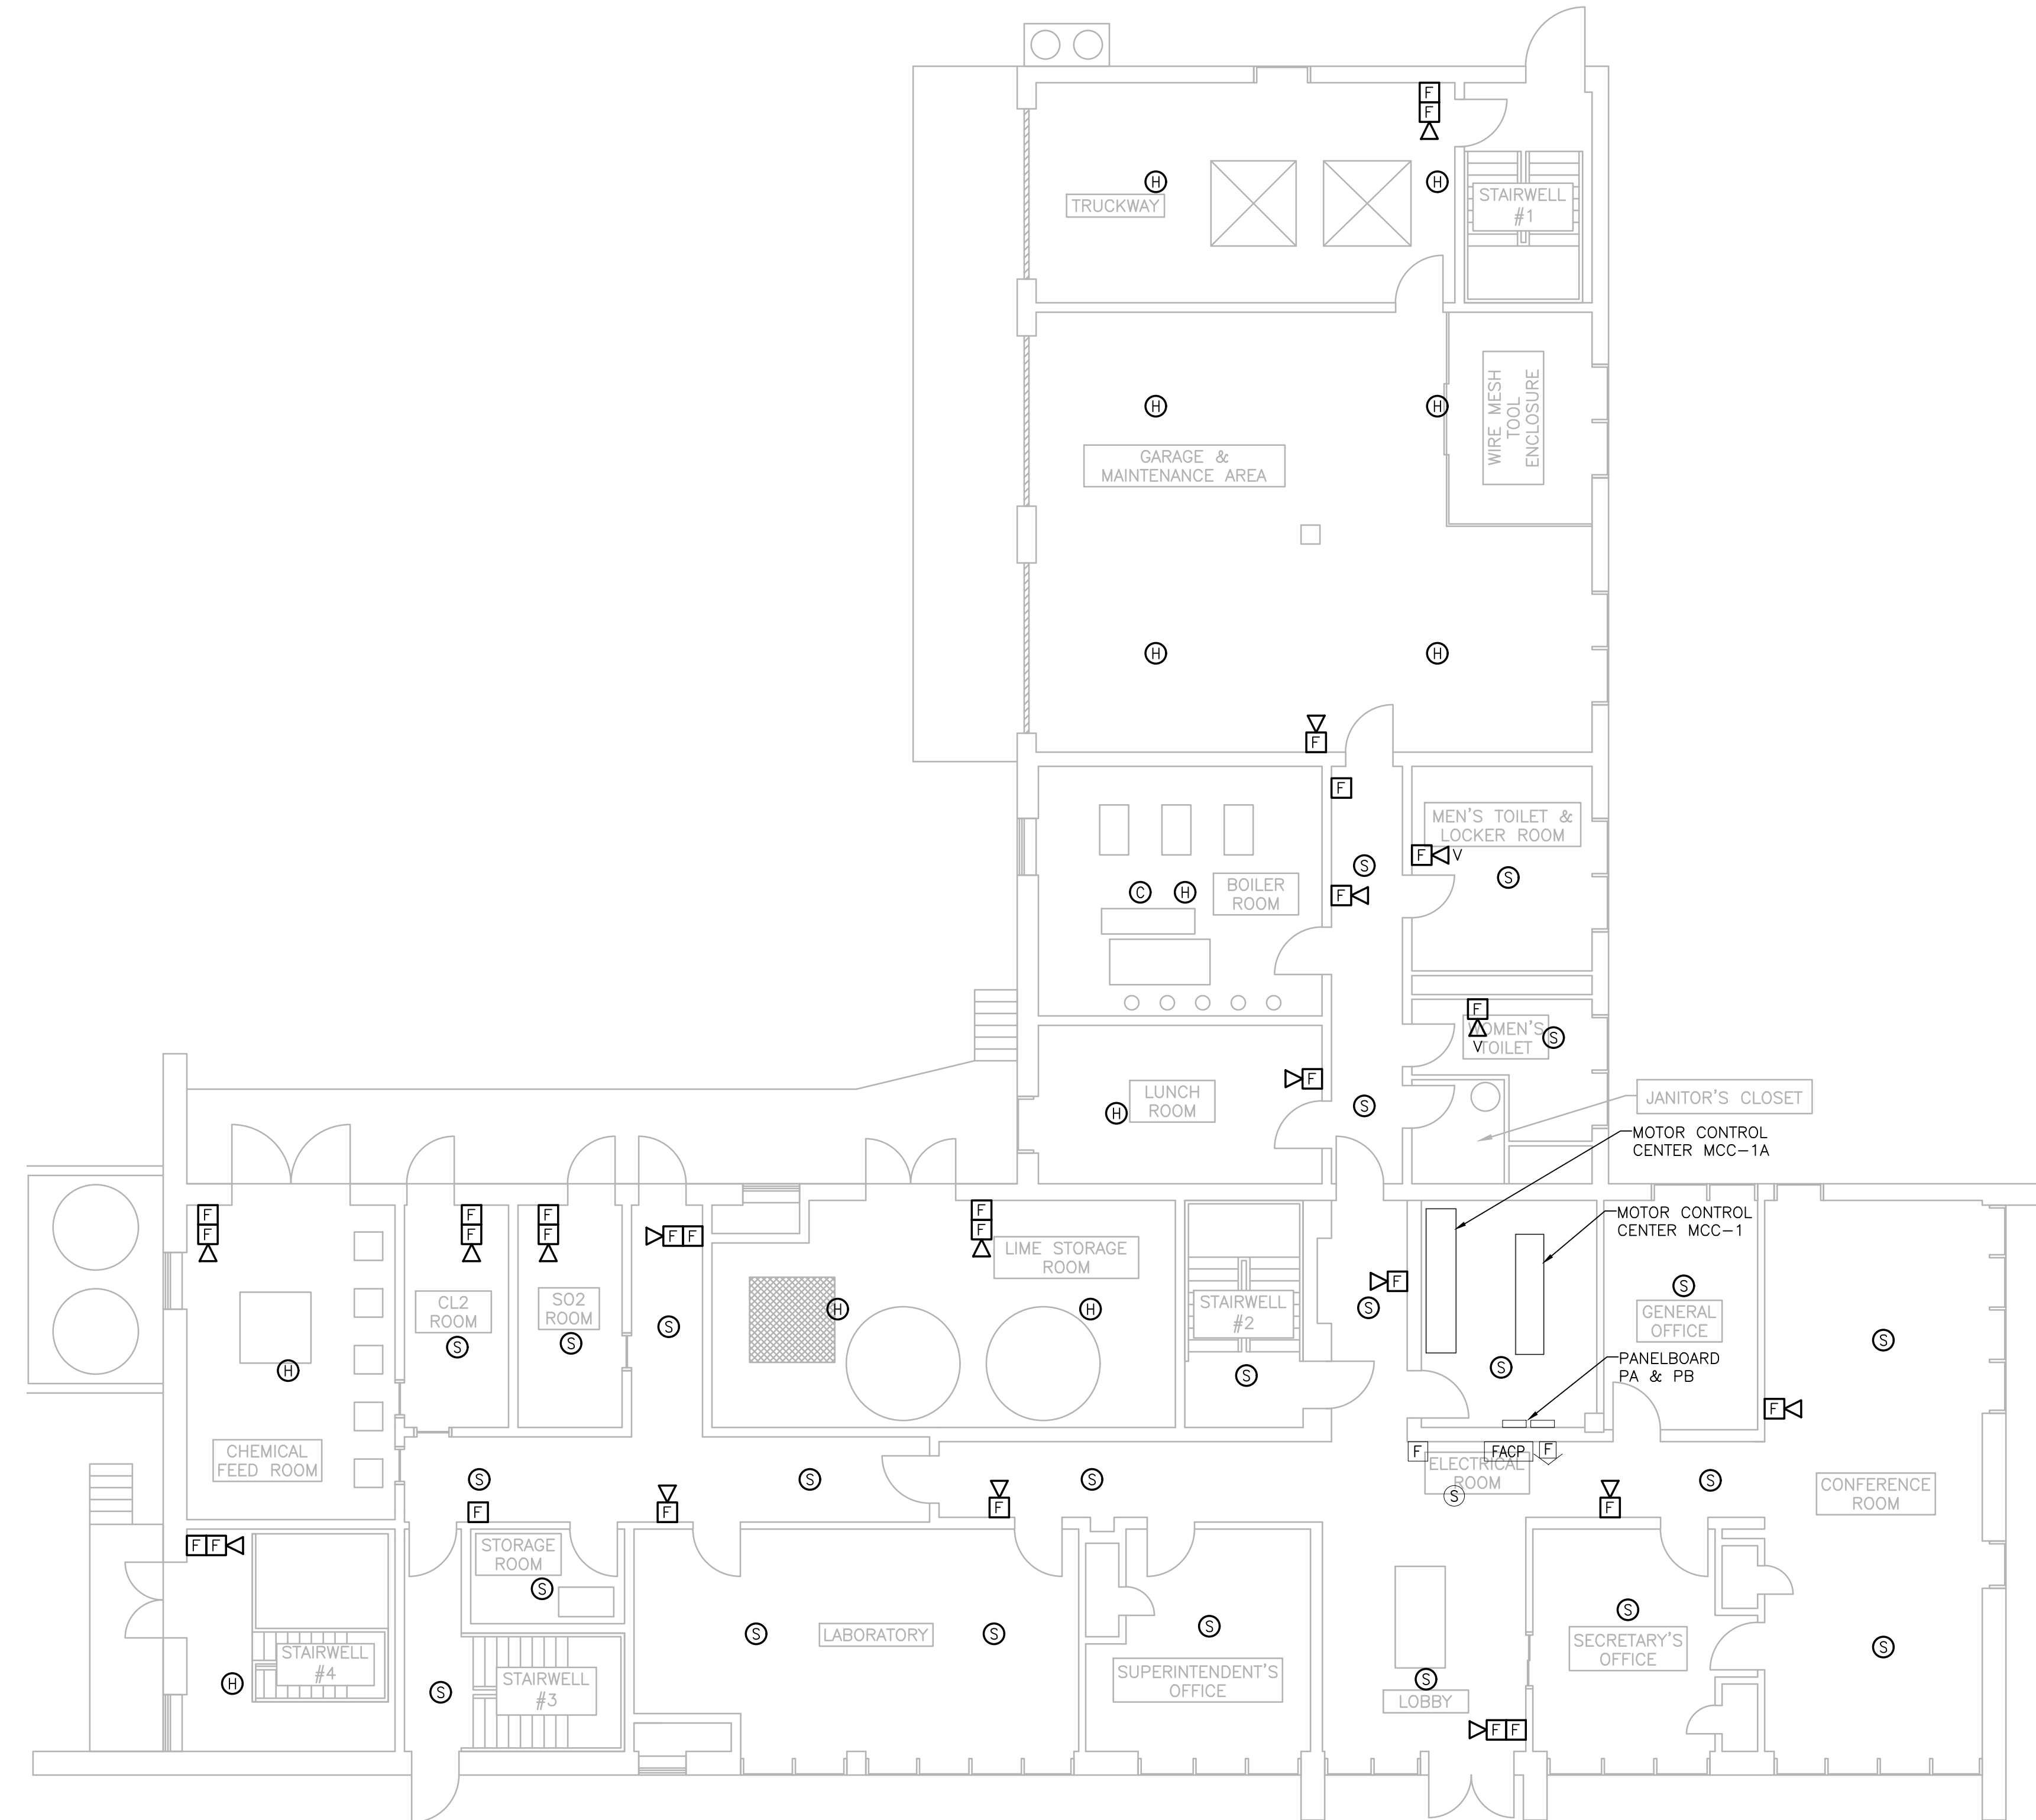


FIRST FLOOR - PLAN
SCALE: 1/8" = 1'

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PROJECT

**BURRILLVILLE WWTF
HEADWORKS &
OAKLAND PUMP
STATION
IMPROVEMENTS**

BURRILLVILLE, RI

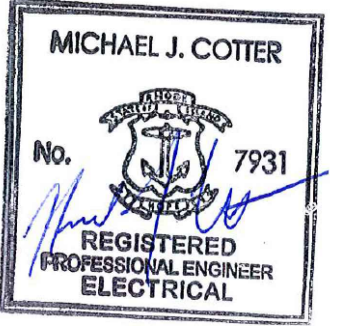TITLE

**Operations
Building**
Electrical
First Floor
Plans

NO.	REVISIONS	DATE

DRAWN BY:	RLB
DESIGNED BY:	RLB
CHECKED BY:	MC
ISSUE DATE:	MAY 2023
BETA JOB NO.:	6861-105

SCALE

AS SHOWN

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SHEET NO.


E-1.5

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PROJECT

BURRILLVILLE WWTF HEADWORKS & OAKLAND PUMP STATION IMPROVEMENTS

BURRILLVILLE, RI

TITLE

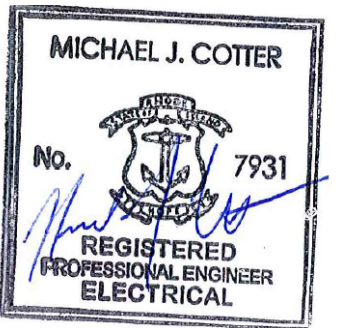Operations Building

Electrical 2nd Floor Demolition Plan



2ND FLOOR - PLAN
SCALE: 1/8" = 1'

NO.	REVISIONS	DATE
-----	-----------	------

DRAWN BY: RLB

DESIGNED BY: RLB

CHECKED BY: MC

ISSUE DATE: MAY 2023

BETA JOB NO.: 6861-105


SCALE

AS SHOWN

UNLESS OTHERWISE NOTED OR CHANGED BY REPRODUCTION

SHEET NO.

E-1.6

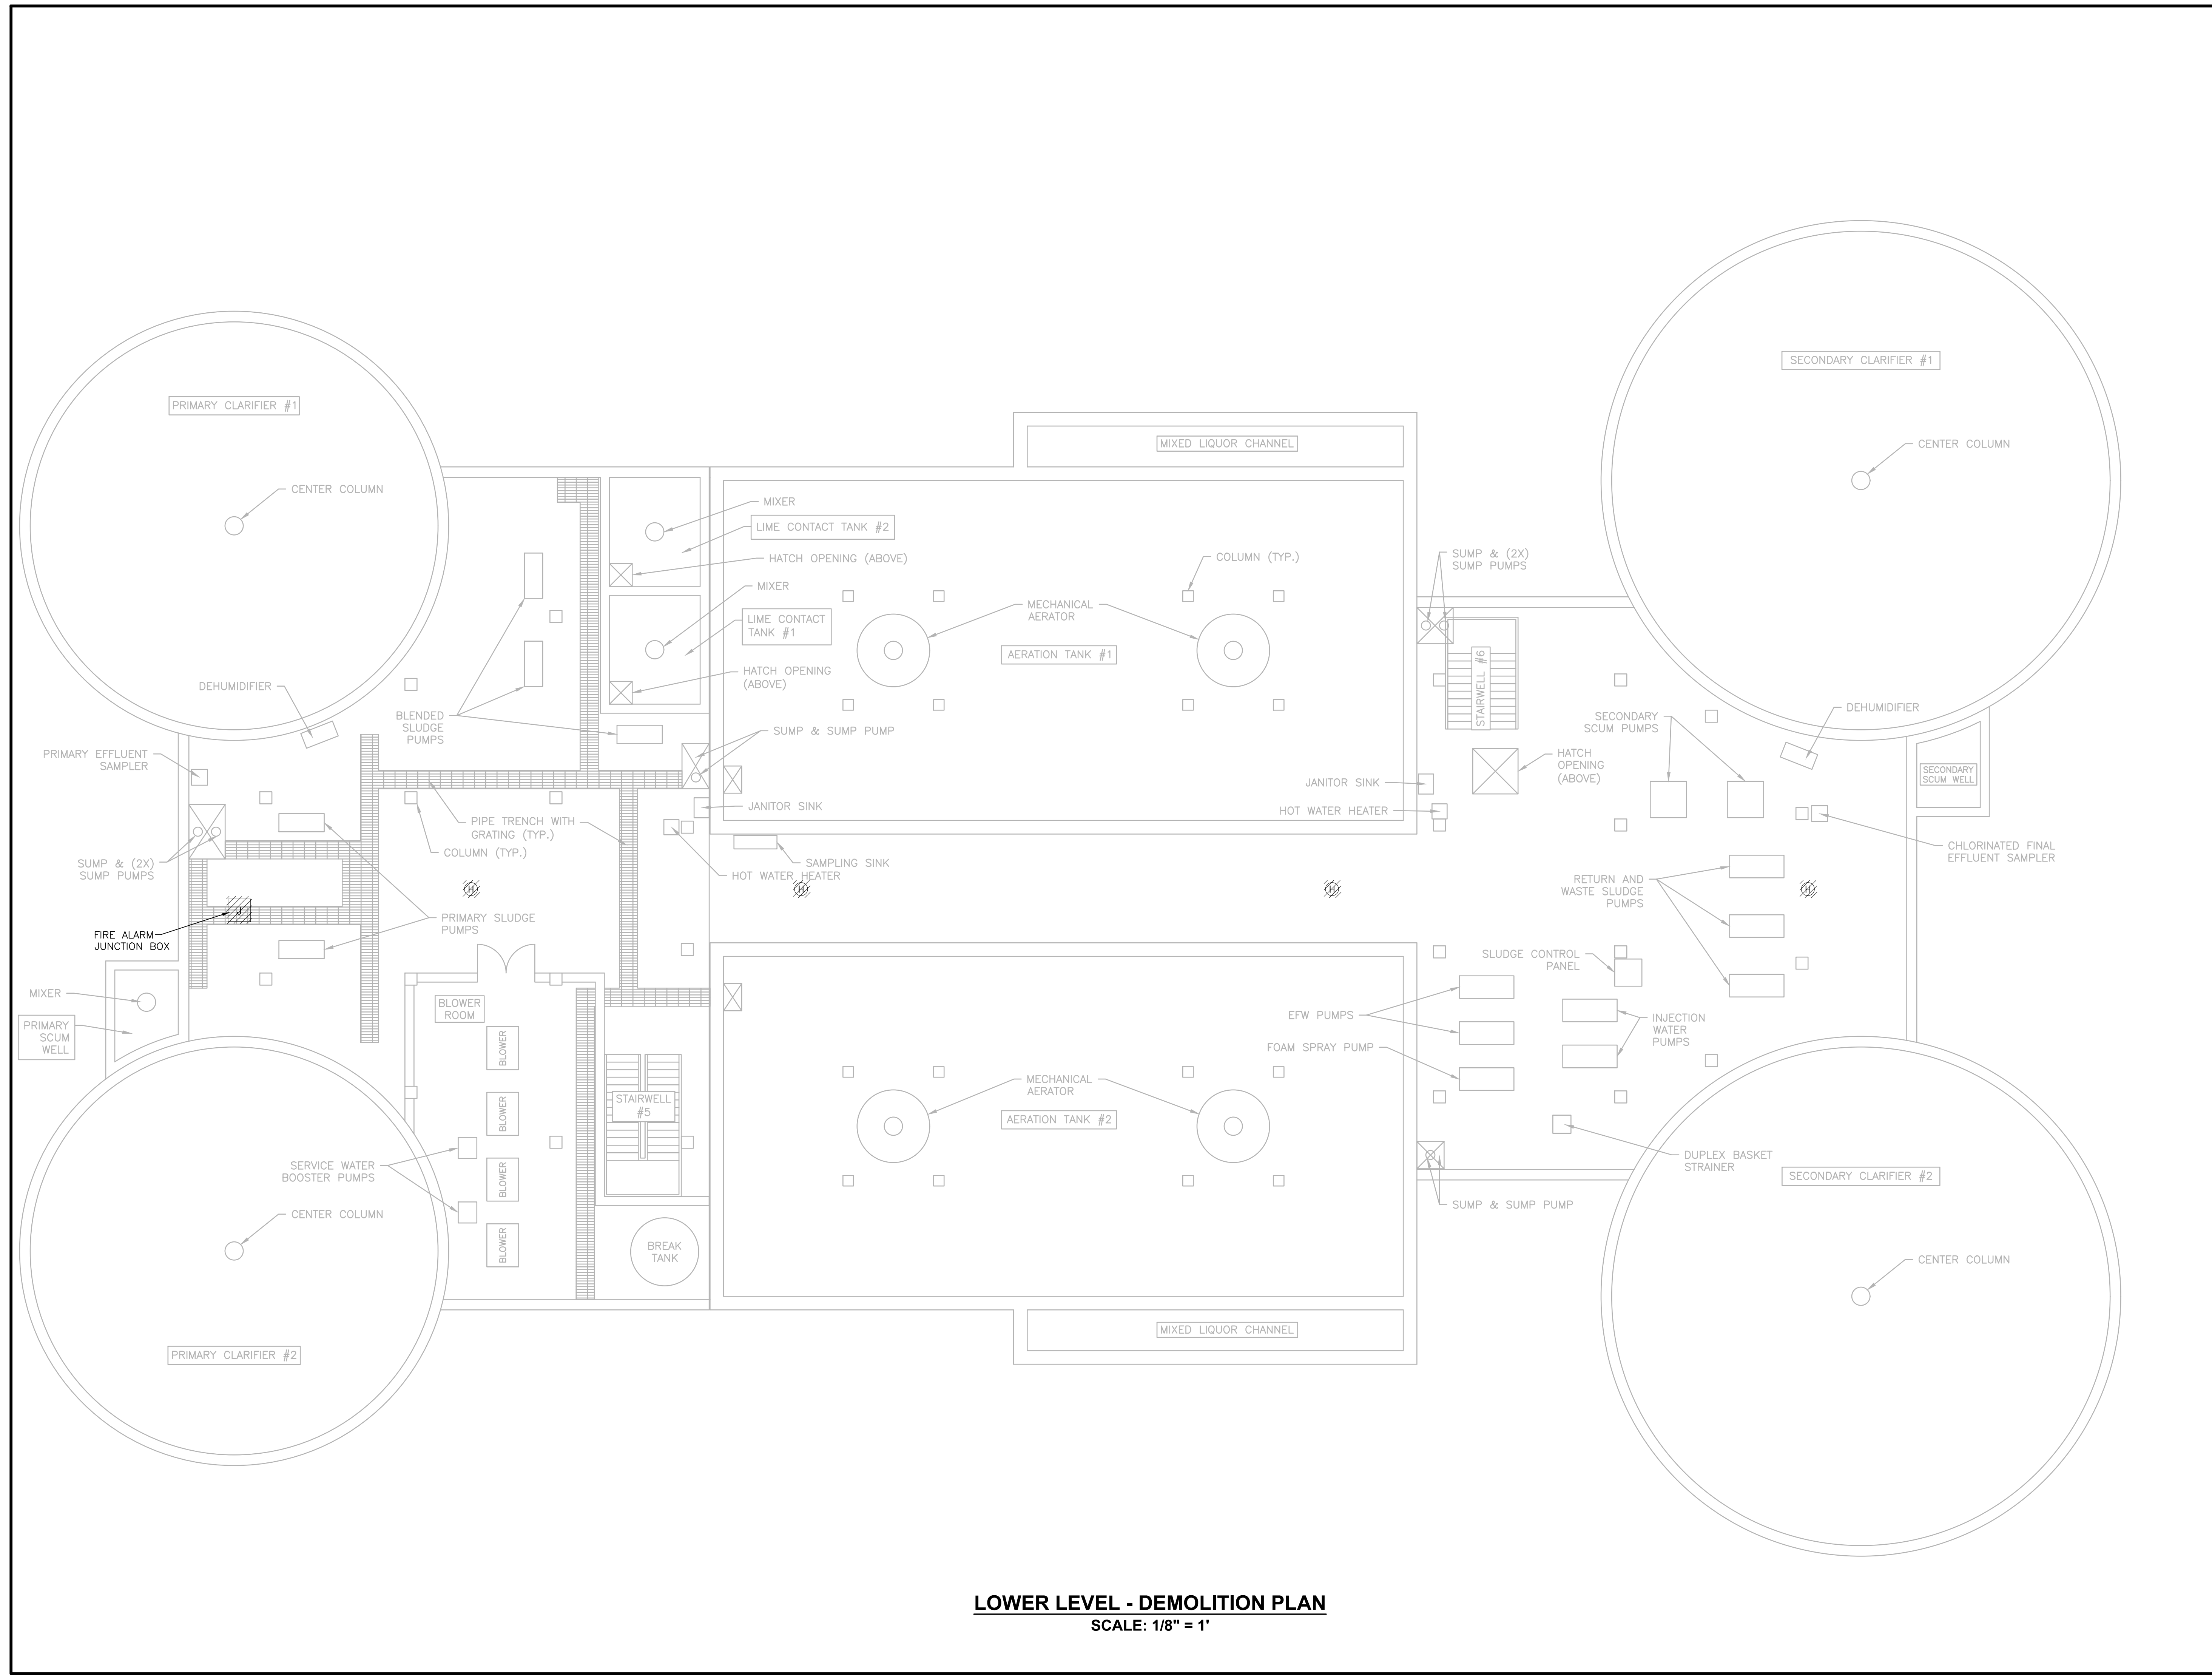


LOWER LEVEL - DEMOLITION PLAN
SCALE: 1/8" = 1'

PREPARED BY



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PROJECT

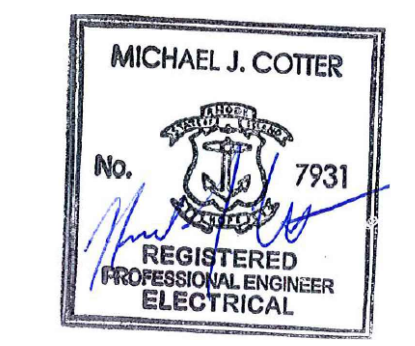**BURRILLVILLE WWTf
HEADWORKS &
OAKLAND PUMP
STATION
IMPROVEMENTS**

BURRILLVILLE, RI

TITLE

**Pump
Gallery**
Electrical
Lower Level
Demolition Plan


NO.	REVISIONS	DATE

DRAWN BY:	RLB
DESIGNED BY:	RLB
CHECKED BY:	MC
ISSUE DATE:	MAY 2023
BETA JOB NO.:	6861-105

SCALE
AS SHOWN

UNLESS OTHERWISE NOTED OR CHANGED BY REPRODUCTION

SHEET NO.
E-2.1

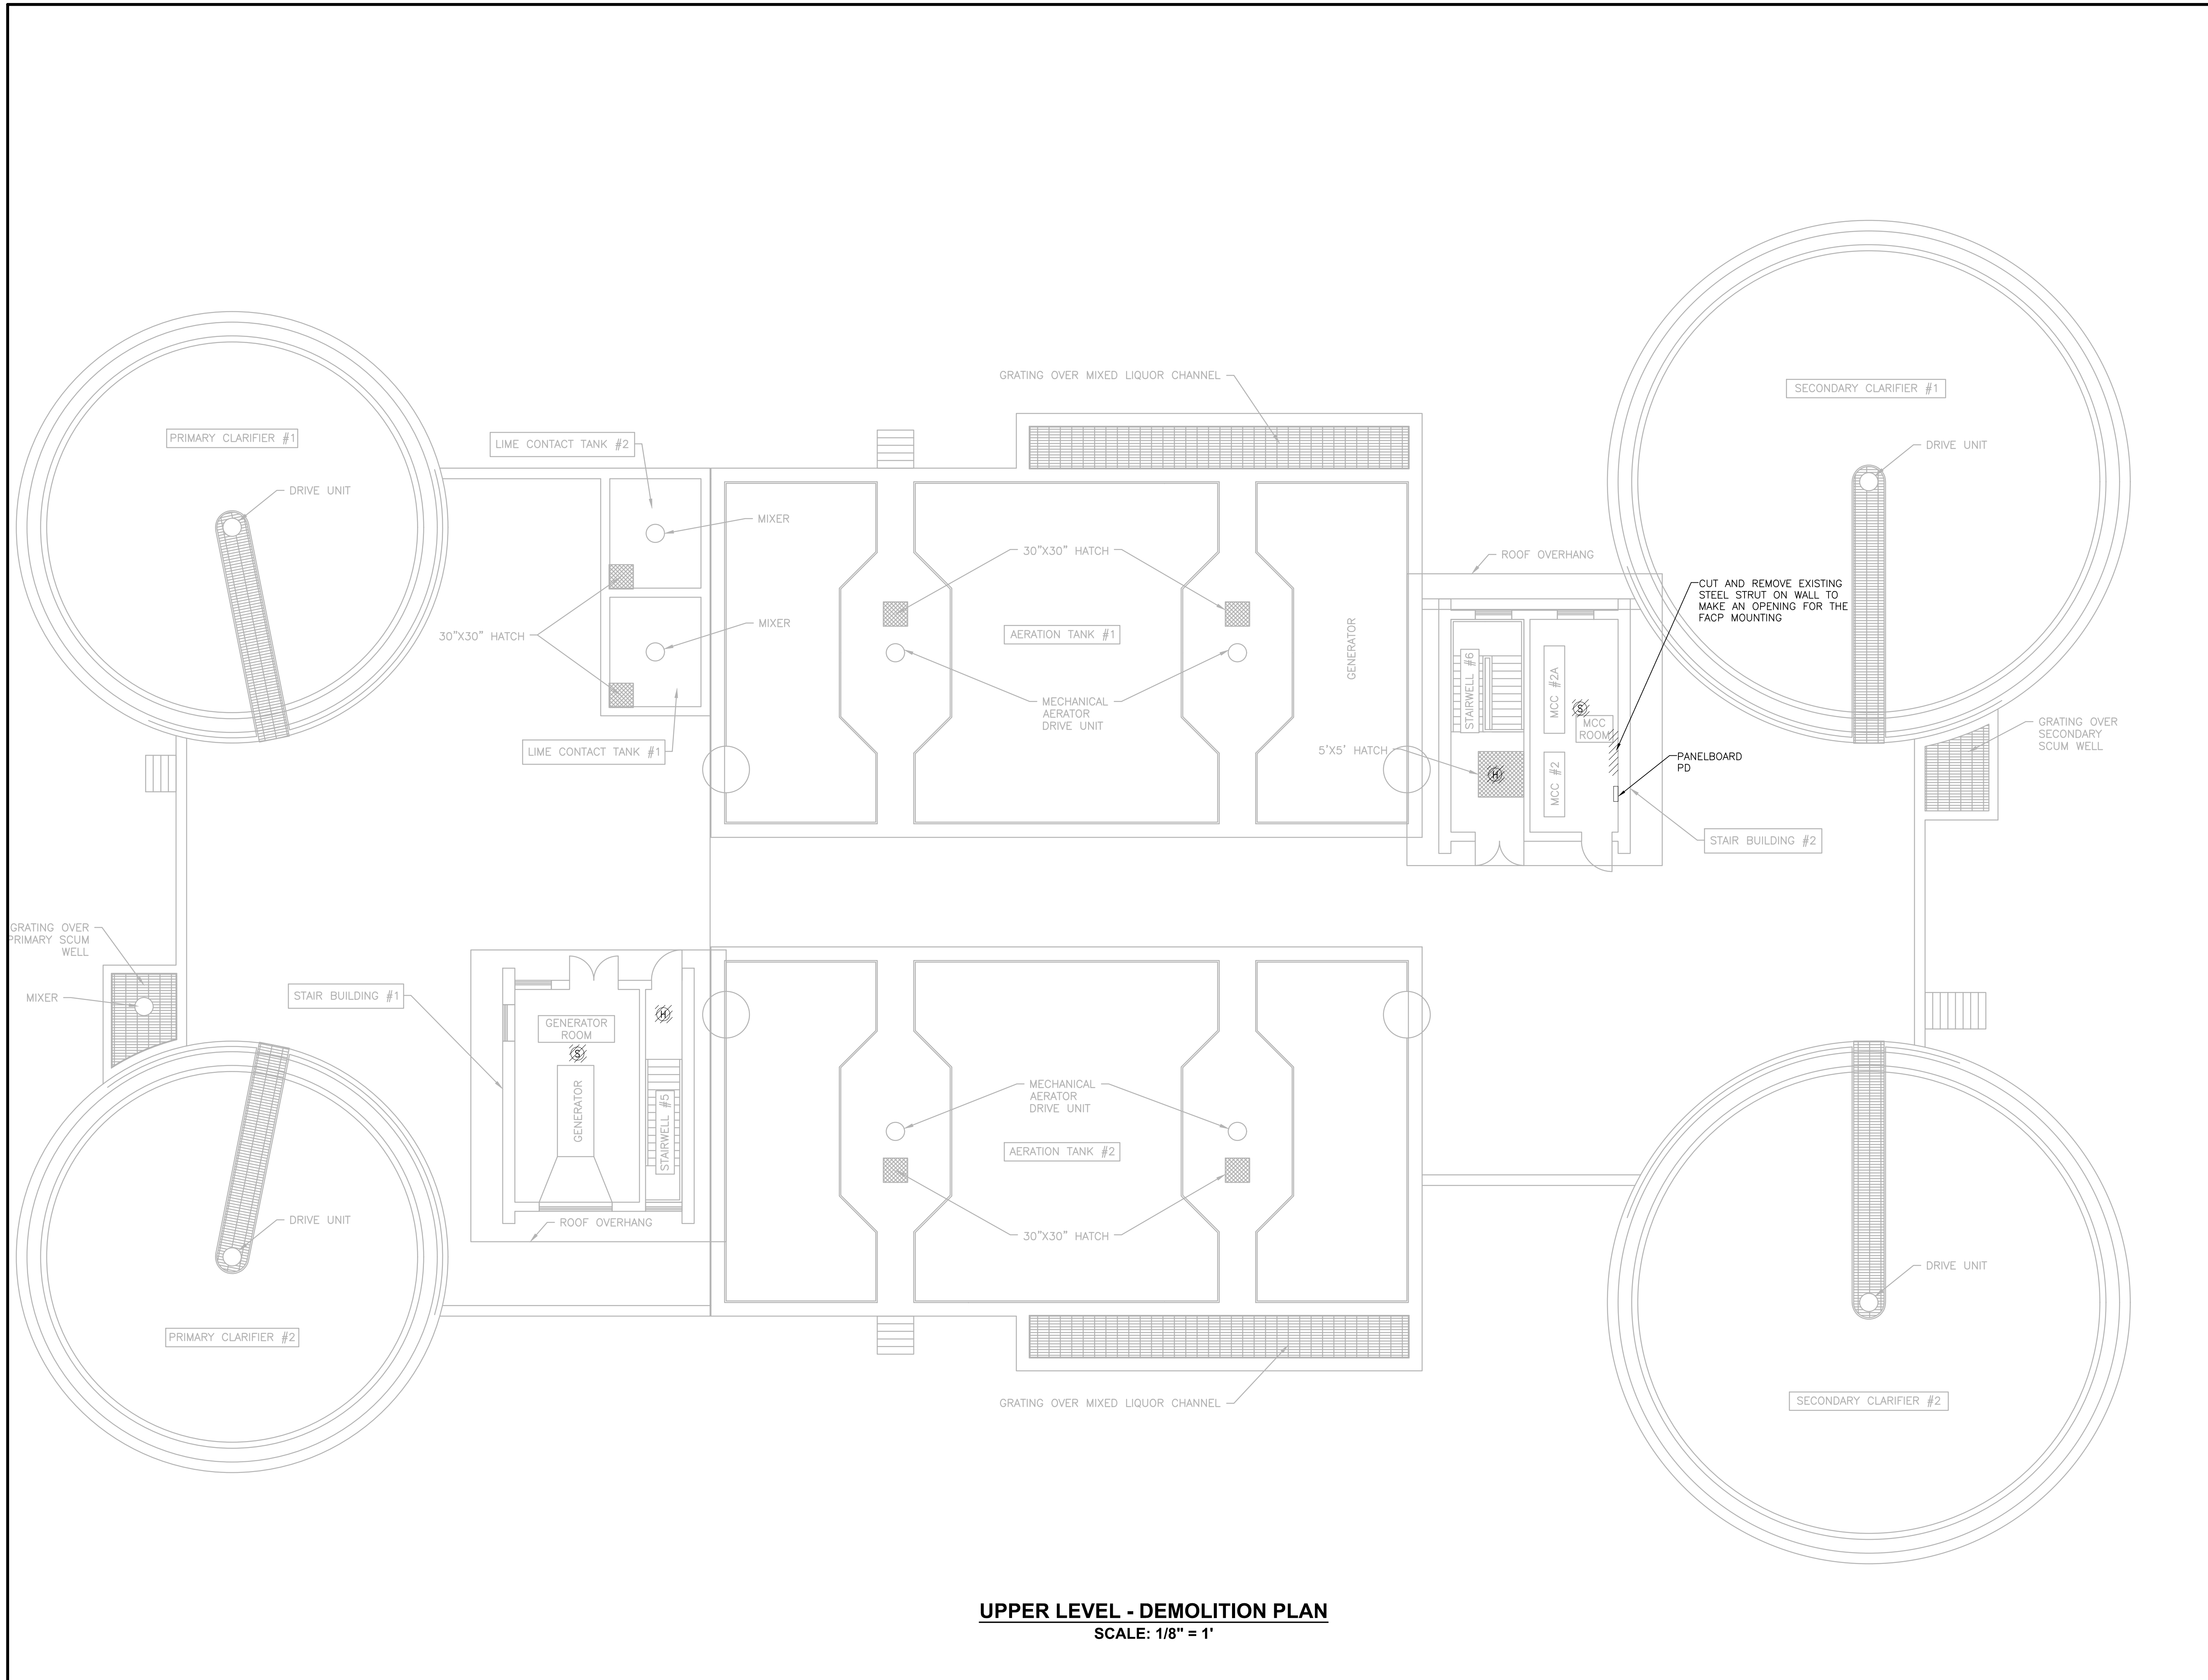


UPPER LEVEL - DEMOLITION PLAN
SCALE: 1/8" = 1'

PREPARED BY



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PROJECT

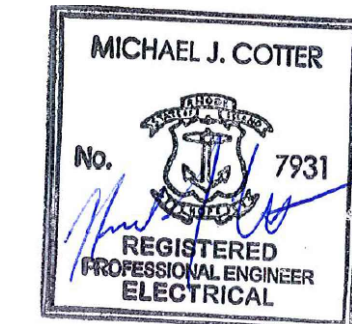**BURRILLVILLE WWTF
HEADWORKS &
OAKLAND PUMP
STATION
IMPROVEMENTS**

BURRILLVILLE, RI

TITLE


**Pump
Gallerly**
Electrical
Upper Level
Demolition Plan

NO.	REVISIONS	DATE

DRAWN BY:	RLB
DESIGNED BY:	RLB
CHECKED BY:	MC
ISSUE DATE:	MAY 2023
BETA JOB NO.:	6861-105

SCALE
AS SHOWN
<small>UNLESS OTHERWISE NOTED OR CHANGED BY REPRODUCTION</small>

SHEET NO.	E-2.2
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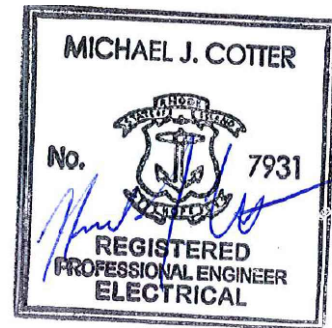


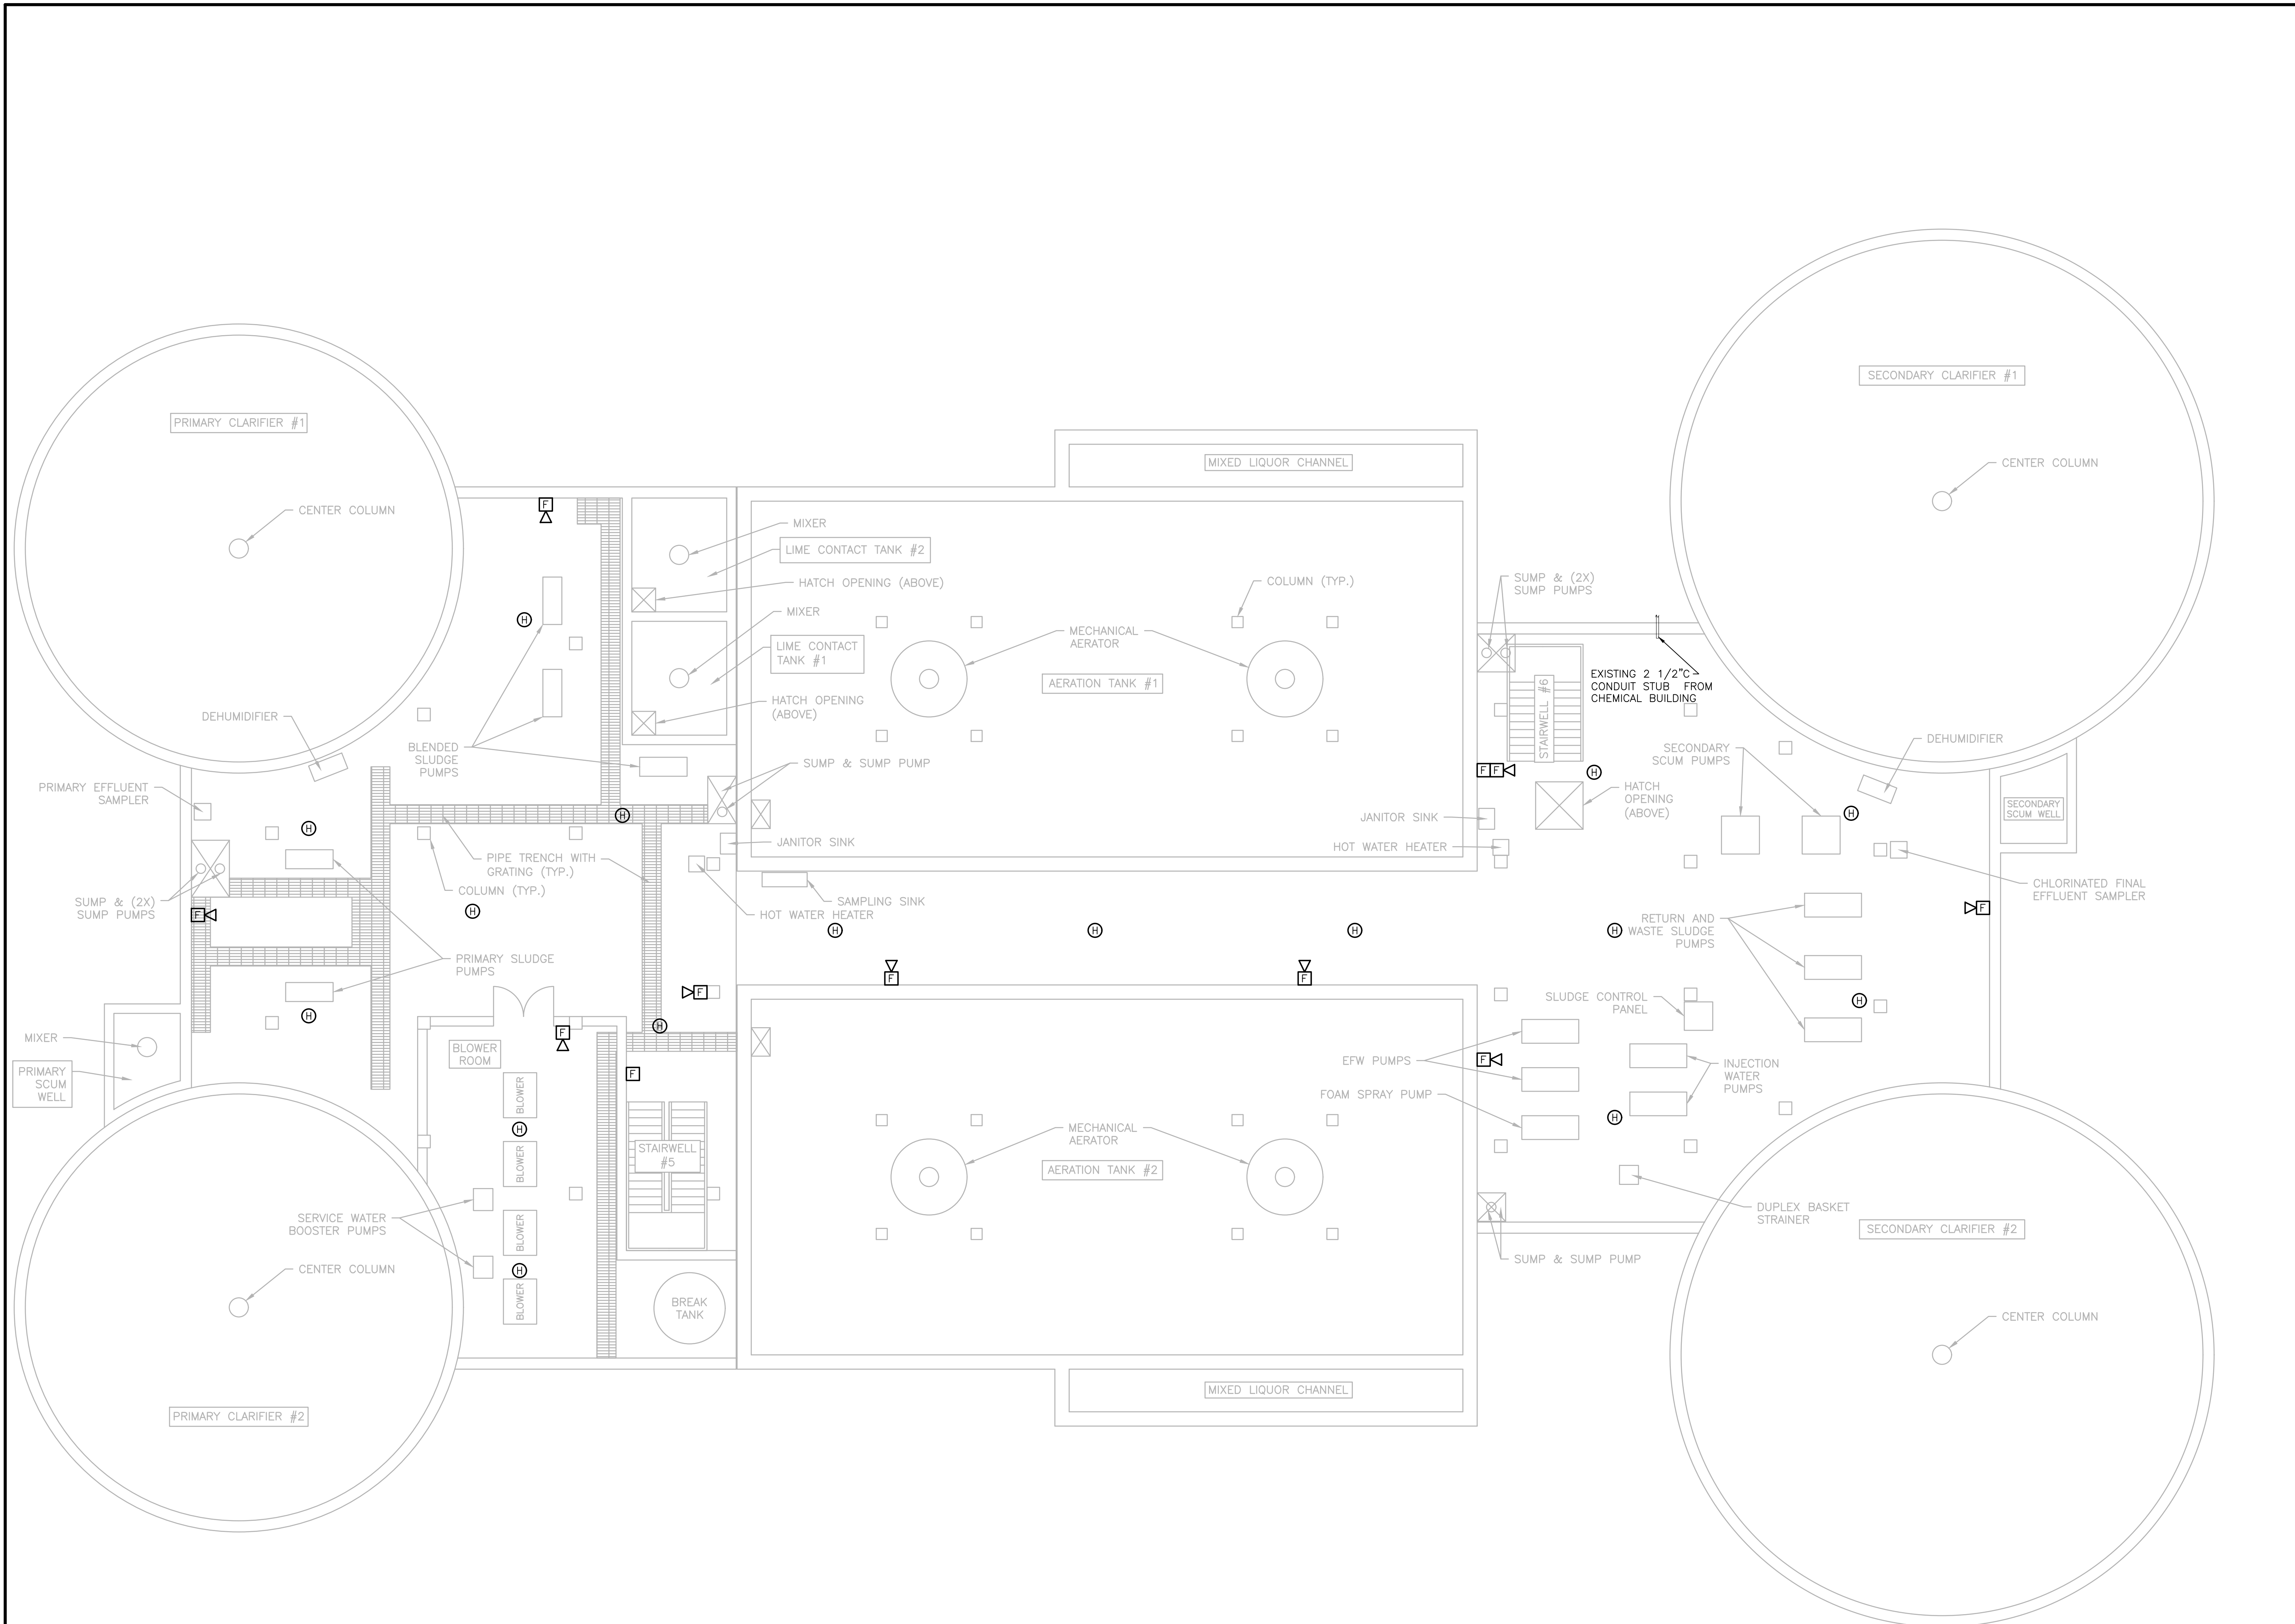LOWER LEVEL - DEMOLITION PLAN
 SCALE: 1/8" = 1'

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PROJECT

**BURRILLVILLE WWTF
 HEADWORKS &
 OAKLAND PUMP
 STATION
 IMPROVEMENTS**

BURRILLVILLE, RI

TITLE

**Pump
 Gallery**
 Electrical
 Lower Level
 Demolition Plan

NO.	REVISIONS	DATE

DRAWN BY:	RLB
DESIGNED BY:	RLB
CHECKED BY:	MC
ISSUE DATE:	MAY 2023
BETA JOB NO.:	6861-105


SCALE

AS SHOWN

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SHEET NO.

E-2.3

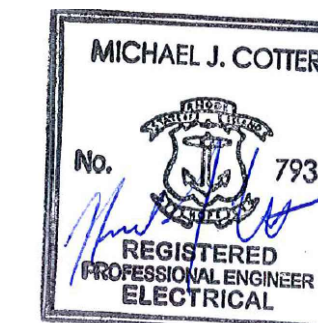

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**BURRILLVILLE WWTF
HEADWORKS &
OAKLAND PUMP
STATION
IMPROVEMENTS**

BURRILLVILLE, RI

**Oakland
Pump Station**

Electrical Site
Plan and Details


NO.	REVISIONS	DATE

DRAWN BY:	RLB
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CHECKED BY:	MC
ISSUE DATE:	MAY 2023
BETA JOB NO.:	6861-105

AS SHOWN

E-3.0

DUCT / CABLE SCHEDULE				
DUCT NO.	SIZE	CONDUCTORS	FROM	TO
D1	3"	(4) #250KCMIL	UTILITY POLE	UTILITY METER
D2	3"	PULL STRING	STUB UP AND CAP AT UTILITY POLE BASE	STUB UP AND CAP BELOW UTILITY METER
D3	3"	(4) #250KCMIL, #4 GND	GENERATOR	GENERATOR DISCONNECT SWITCH
D4	1"	(4) #12, #12GND	MPB	GENERATOR AUXILIARY SYSTEMS
D5	1"	(6) #14	GENERATOR	ATS, EMERGENCY STOP, PUMP CONTROL PANEL

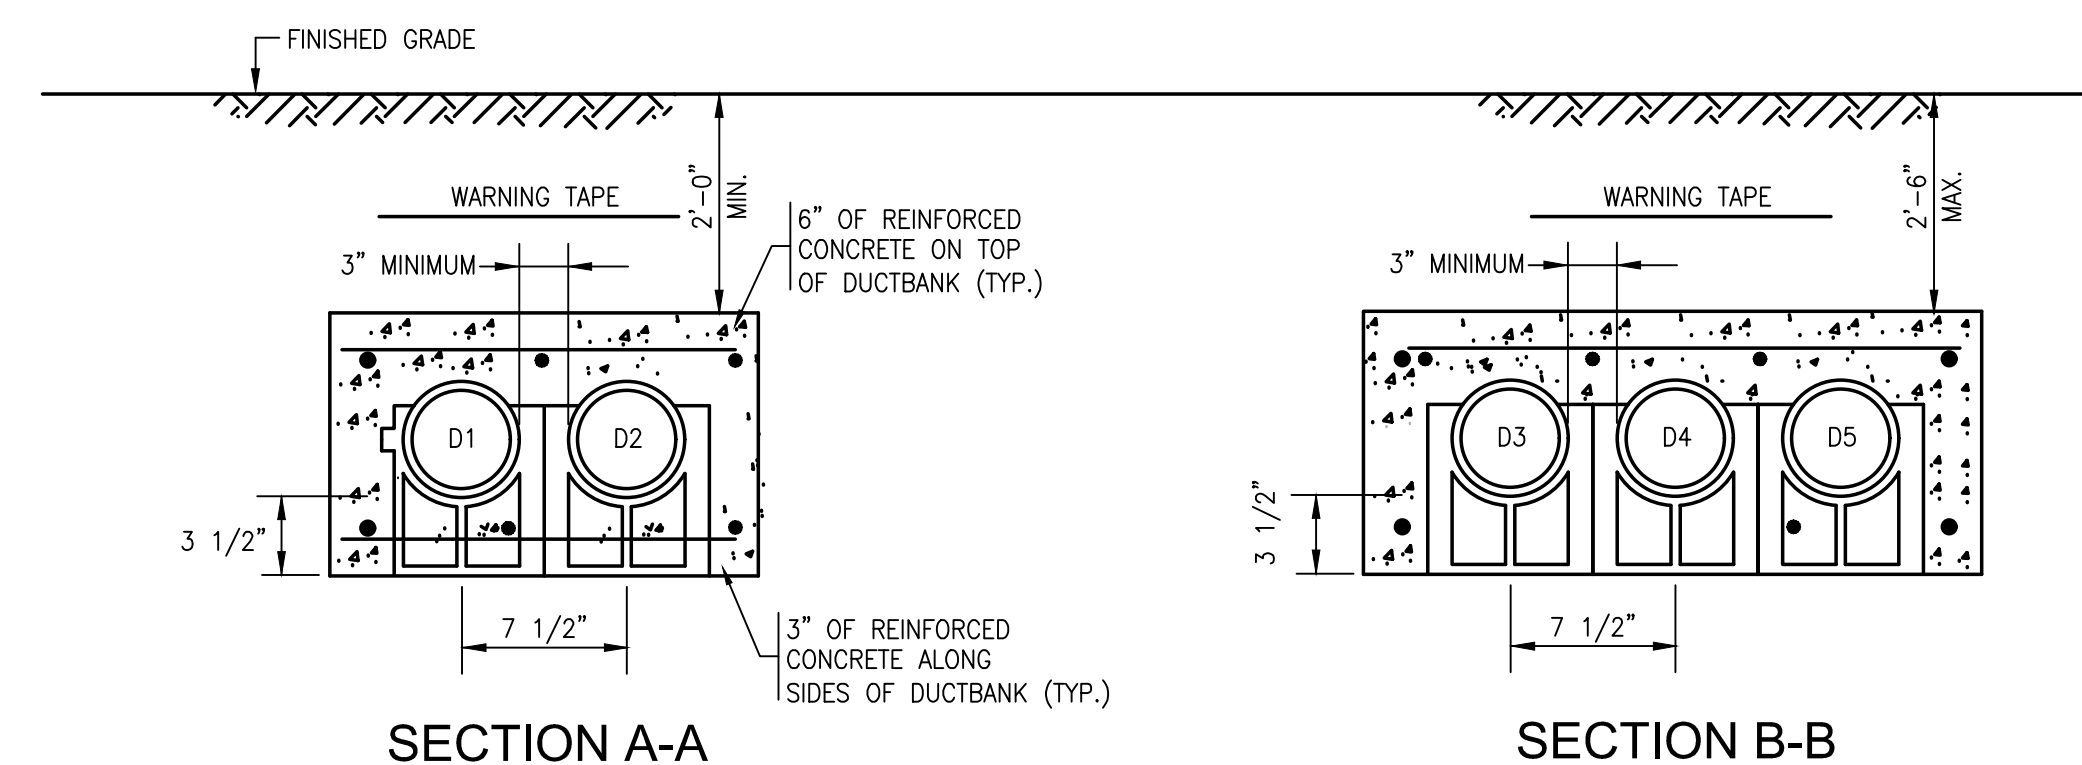


NOTES:

- BACKFILL DUCT BANK IN LAYERS AND MANUALLY TAMP OR "PUDDLE" CONCRETE FILL. PROVIDE RED DUCT BANK MARKER TAPES, READING "CAUTION - ELECTRICAL LINES BELOW", OVER ENTIRE LENGTH OF DUCTLINE. LOCATE TAPES 12 INCHES BELOW GRADE. PROVIDE A TAPE FOR EVERY 12 INCHES OF WIDTH OF DUCTLINE.


DUCTBANK SECTIONS

NO SCALE

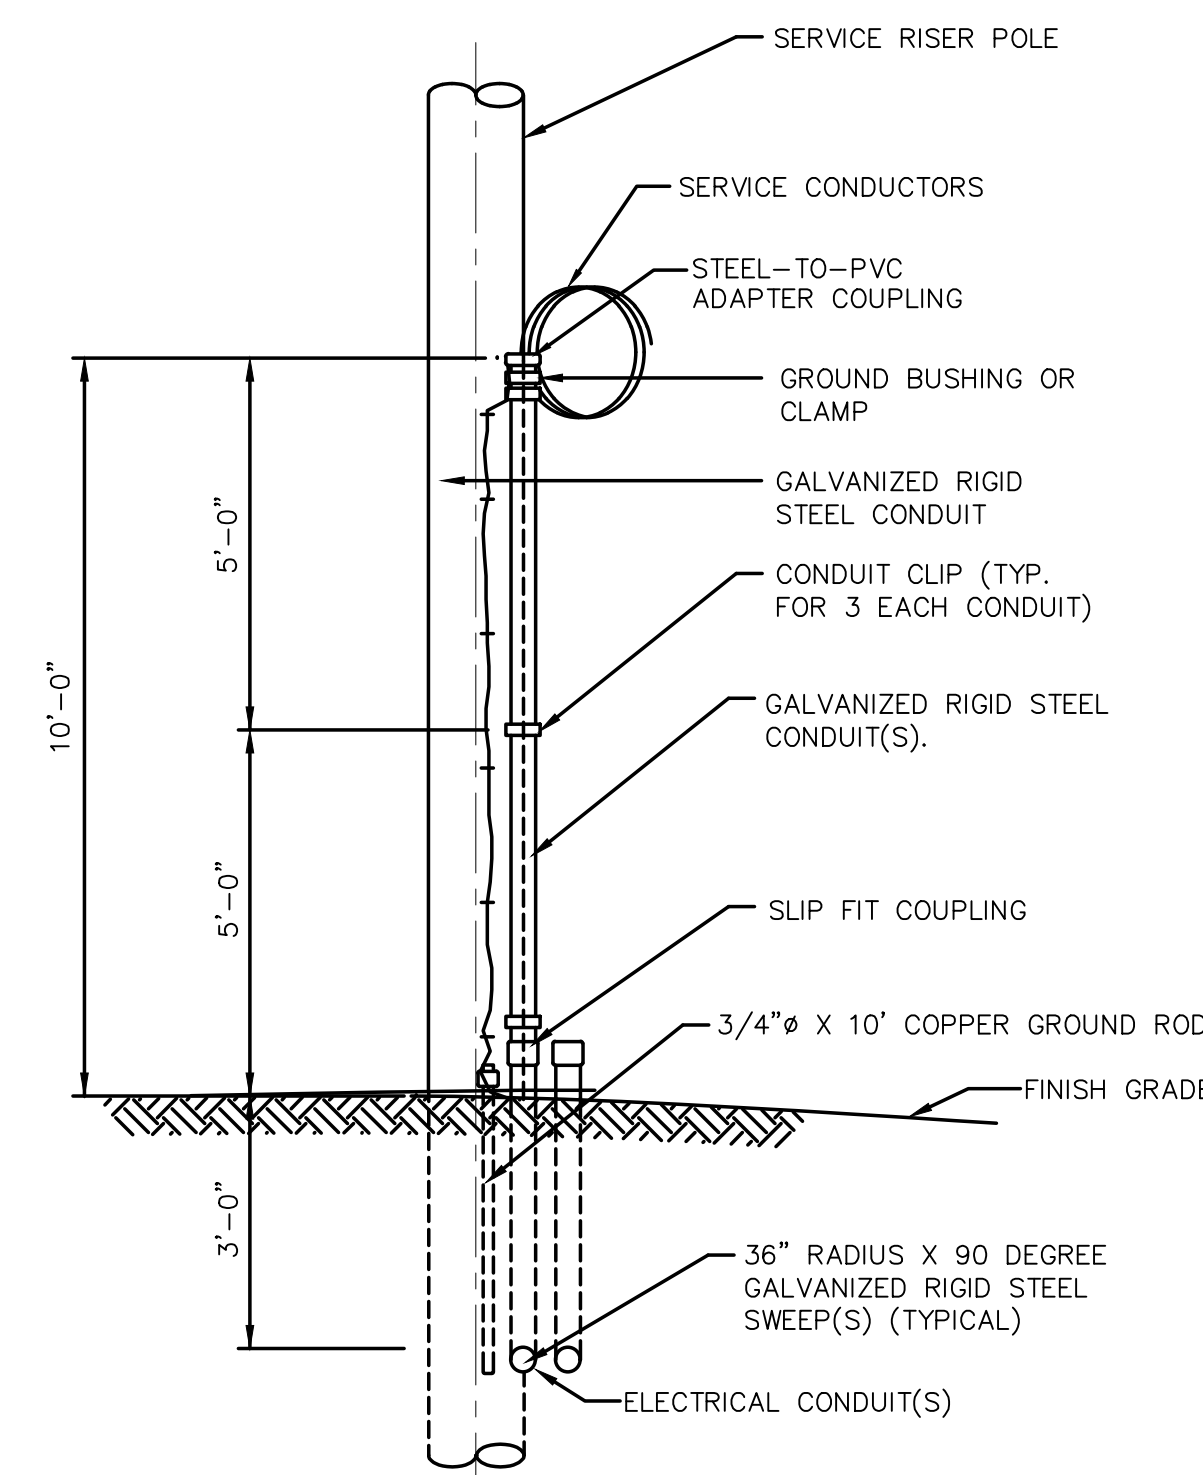

UTILITY POLE SERVICE
RISER DETAIL

NOT TO SCALE

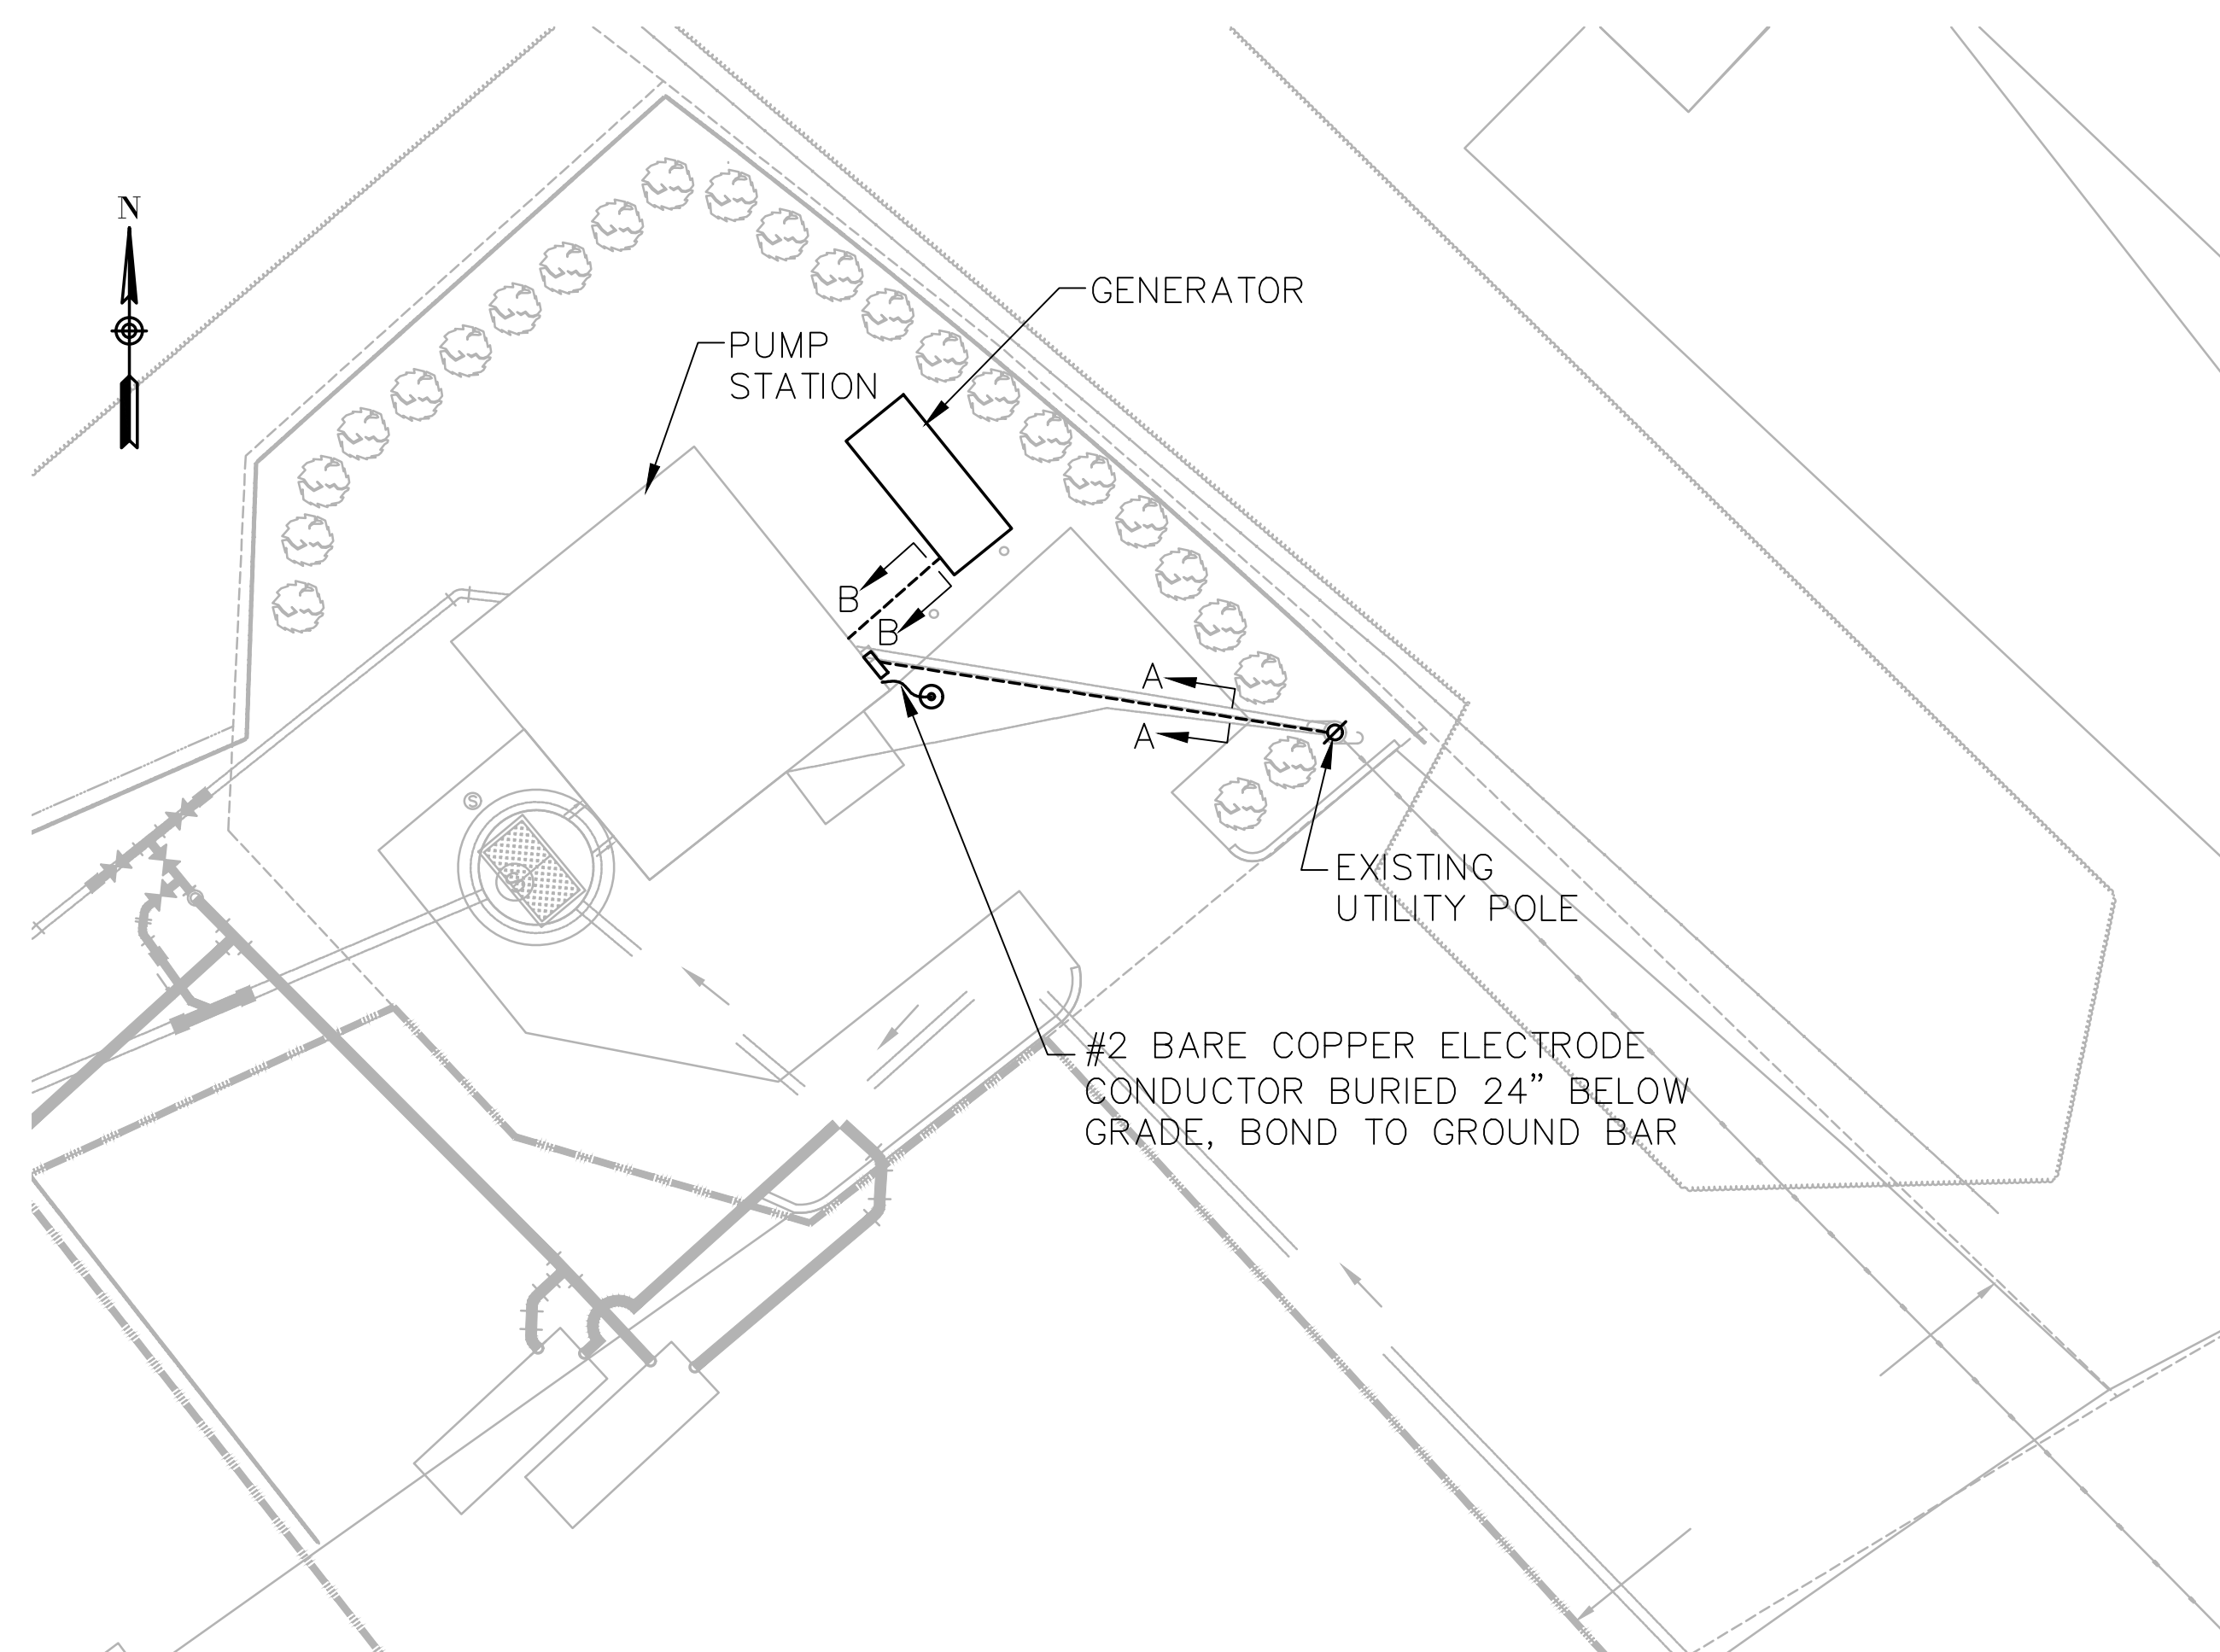

ELECTRICAL SITE PLAN

SCALE: 1" = 10' - 0"

