



PROFILE OF FLOOD WALLS AND DIKES
SCALE: HOR. 1" = 200'
VERT. 1" = 10'

"Blow-up Window" of Figure 2b (see Figure 2b)

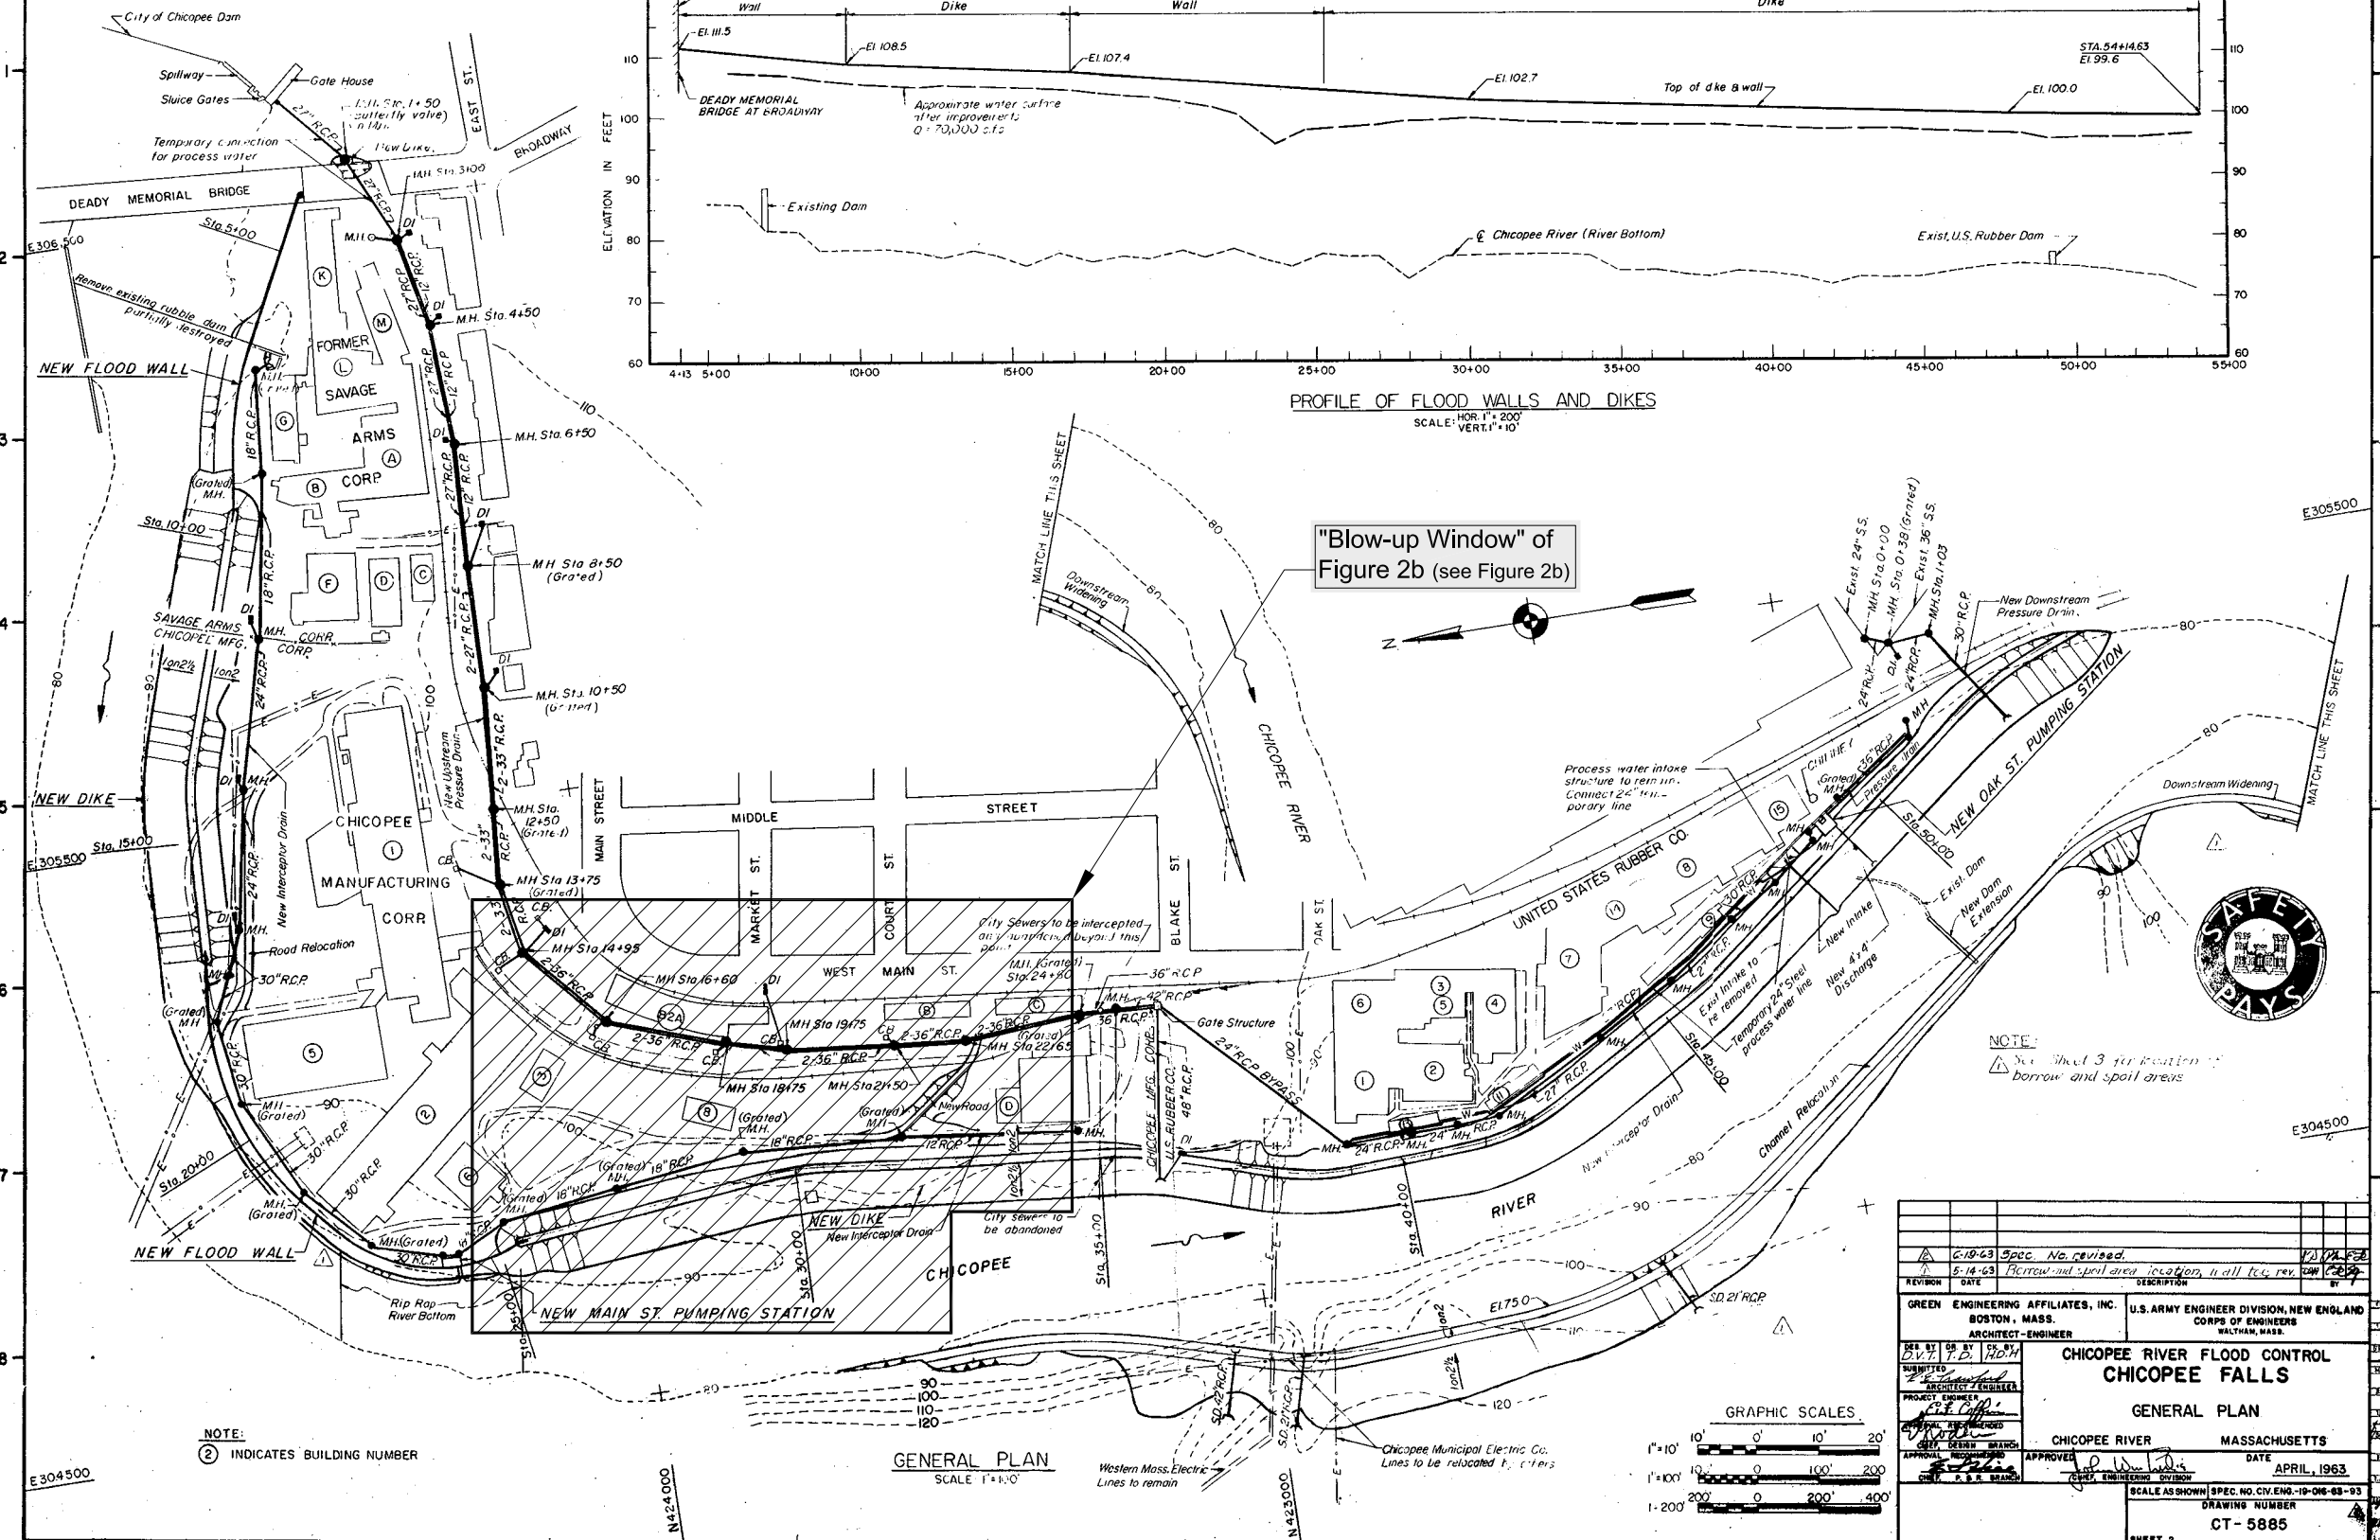

NOTE:
② INDICATES BUILDING NUMBER

GENERAL PLAN
SCALE 1" = 300'

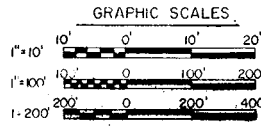

REVISION	DATE	DESCRIPTION	BY
1	5-18-63	Revised and spill area location, wall loc. rev.	CEP
2	5-18-63	Spec. No. revised.	VA/PE

DESIGN BY	DATE	PROJECT ENGINEER	DATE
CEP	5-18-63	CEP	APRIL, 1963
CHECKED BY	DATE	APPROVED	DATE
CEP	5-18-63	CEP	APRIL, 1963

PROJECT	CHICOPEE RIVER FLOOD CONTROL
SUBJECT	CHICOPEE FALLS
GENERAL PLAN	
LOCATION	CHICOPEE RIVER MASSACHUSETTS
DRAWING NUMBER	CT-5885
SHEET	2

Figure 2a
Site Plan
Work Plan for
Borehole Backfilling
Within
USACE Levee Right of Way
Scale: 1" = 300' 9/16/10